



1 MAIN FLOOR PLAN - MECHANICAL - NEW CONSTRUCTION
 M1.1 SCALE: 1:300

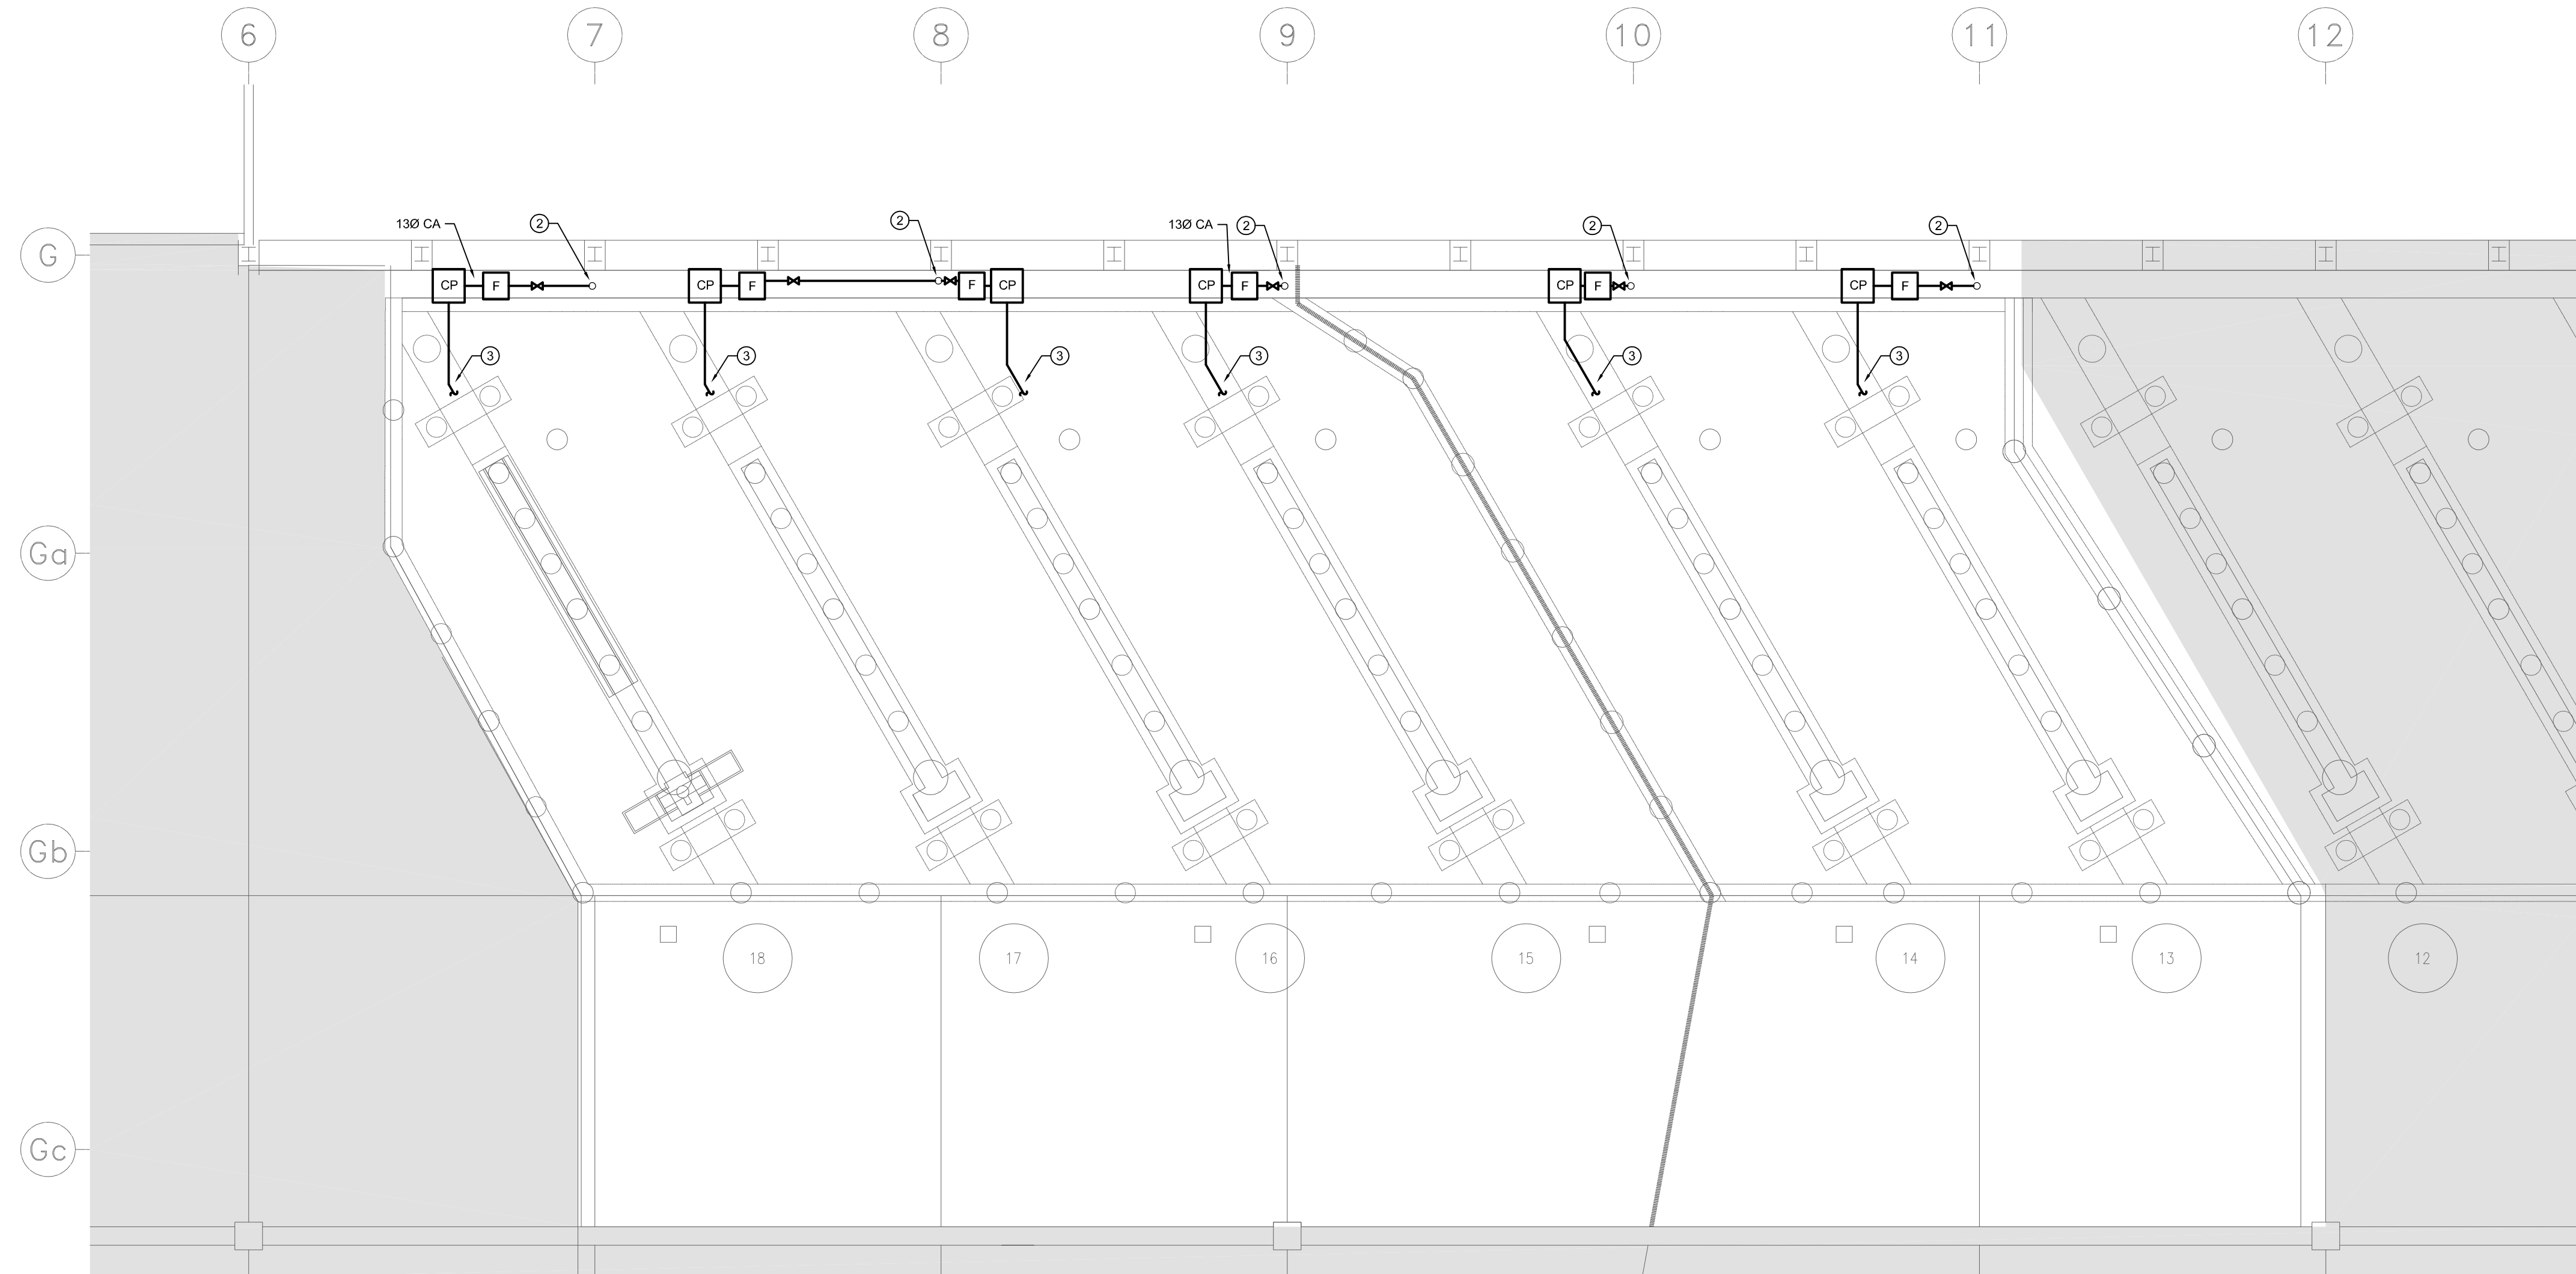


2 PARTIAL MAIN FLOOR PLAN - COMPRESSED AIR - NEW CONSTRUCTION
 M1.1 SCALE: 1:100

COMPRESSED AIR KEY NOTES

1. EXISTING COMPRESSED AIR PLANT.
2. EXISTING 19mm COMPRESSED AIR DROPS FROM GENERAL AIR SYSTEM.
3. PROVIDE COMPRESSED AIR TO EACH HOIST AS PER DETAIL 3/M1.1

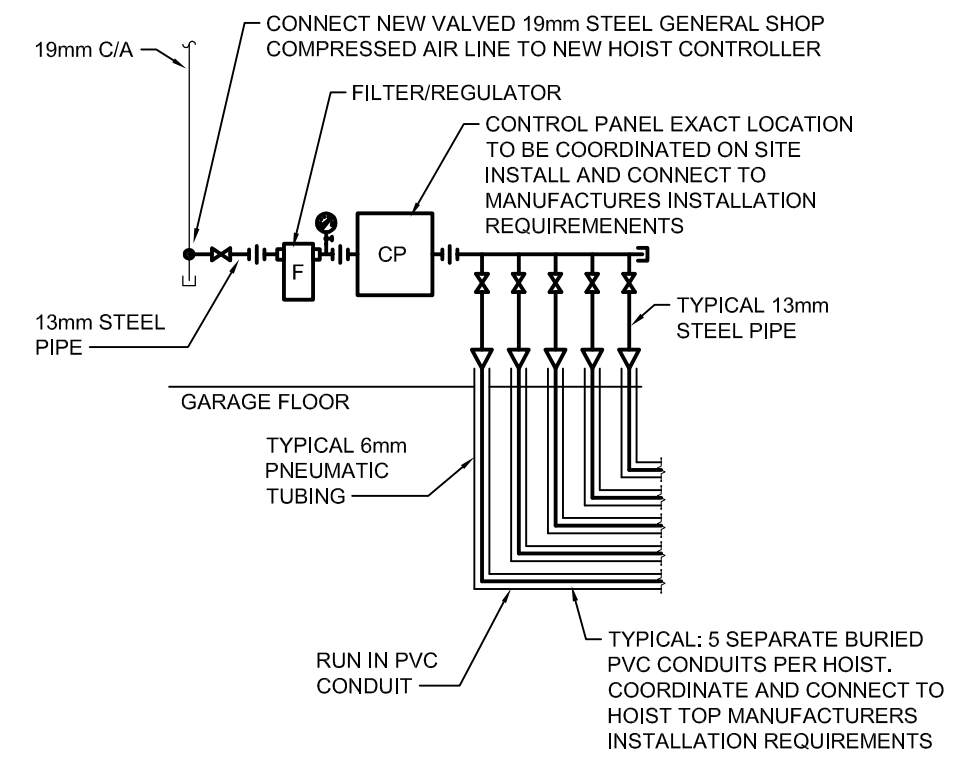

3 COMPRESSED AIR DETAIL
 M1.1 SCALE: NTS

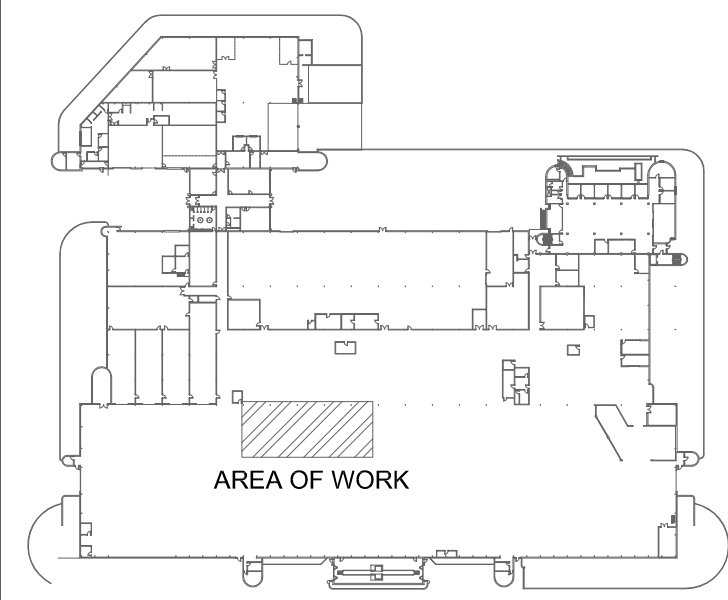

KEYPLAN
 SCALE: NTS

The General Contractor shall check & verify all dimensions and report any errors or omissions to the designers.

No.	Date	Issue/Revision	By
0	19/08/19	ISSUED FOR BID	JH

**ENGINEERS
 GEOSCIENTISTS
 MANITOBA**
 Certificate of Authorization
SMS Engineering Ltd.
 No. 166

PRELIMINARY
 NOT FOR CONSTRUCTION

Consultant
 770 Bradford Street
 Winnipeg, Canada
 T 204 775 0291
 SMSeng.com
 18-435-01

300-275 Carlton Street
 Winnipeg, Manitoba R3C 5R6
 T 204. 943. 7501
 F 204. 943. 7507

**Crosier Kilgour
 & Partners Ltd.**
 CONSULTING STRUCTURAL ENGINEERS

Project
**WINNIPEG TRANSIT
 GARAGE BUILDING**
 HOIST REPLACEMENT
 421 OSBORNE STREET
 WINNIPEG, MANITOBA

Sheet Title
**MAIN FLOOR PLAN - MECHANICAL -
 NEW CONSTRUCTION**

File 2018-1170 Date 2019-06-10

Design JH Drawn RNS

Revision 0 Sheet No. M1.1