
EXISTING MAIN DISTRIBUTION EXISTING PANEL A - WEST (LOCATED IN MAIN FLOOR FIRST AID ROOM) (LOCATED IN BASEMENT ELECTRICAL ROOM) 600A, 120/208V, 3Ø, 4W 225A, 120/208V, 3Ø, 4W - 3C #6 AWG - 2C #12 AWG RW90 TECK90 IN CONDUIT EXISTING STARTER **EXISTING** HRV-1 EXISTING PARTIAL SINGLE LINE DIAGRAM - DEMOLITION SCALE: N.T.S.

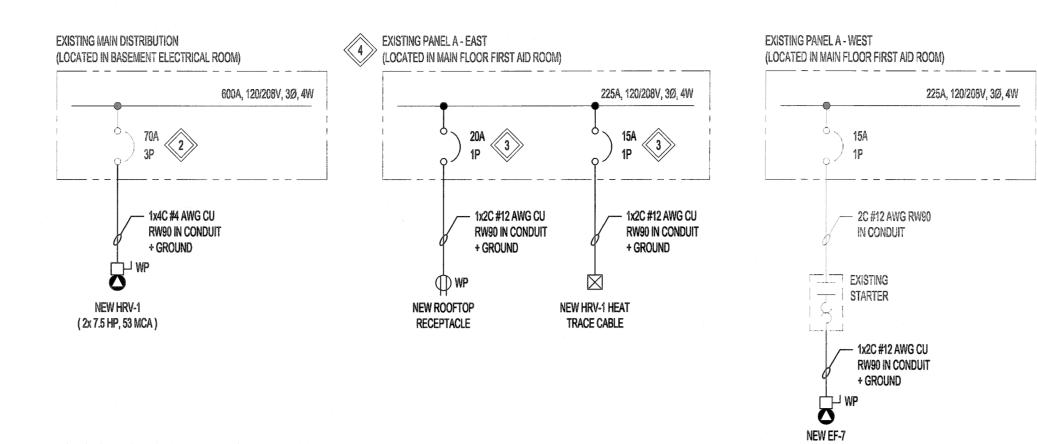

PARTIAL SINGLE LINE DIAGRAM - NEW

SCALE: N.T.S.

	LUMINAIRE SCHEDULE															
						MOUNTING				LAMPS			POWER			
	TYPE	DESCRIPTION	MANUF.	PART/MODEL#			RECESSED		SUSPENDED	QTY PER FIXTURE	TYPE	COLOR TEMP ("K)	LUMENS (LM)	WATTS PER VOLT. FIXTURE (V) (W) NOTES		
	Α	1'x 4' LED SURFACE WRAP LUMINAIRE C/W 50K HOUR L70 RATING, WHITE DIFFUSER, 5 YEAR WARRANTY, 80 CRI, AND 0-10V DIMMING TO 10%.	LITHONIA	SBL4-4000LM-80CRI-40K-MIN10-GZT-MVOLT	х	•		х .	•	1	LED	4000	4000	120	32.4	
	В	1' x 4' LED RECESSED FLAT PANEL C/W 60K HOUR L97 RATING, 5 YEAR WARRANTY, 80 CRI, AND 0-10V DIMMING TO 10%.					Х			1	LED	4000	6000	120	50	
	С	2' x 4' LED RECESSED FLAT PANEL C/W 60K HOUR L97 RATING, 5 YEAR WARRANTY, 80 CRI, AND 0-10V DIMMING TO 10%.	LITHONIA	EPANL-2X4-4000LM-80CRI-40K-MIN10-ZT-MVOLT	х		Х	.		1	LED	4000	4000	120	39	

LEGEND:

EQUIPMENT LOAD

CIRCUIT BREAKER MOTOR DISCONNECT

MOTOR STARTER

THESE DRAWINGS SHALL NOT BE SCALED.

NOTES:

THE CONTRACTOR SHALL VISIT THE SITE AND SATISFY ONESELF ALL DIMENSIONS, DATUM,

AND DETAILED INFORMATION SHOWN ARE CORRECT. THE CONTRACTOR IS TO REVIEW AND COORDINATE ALL ARCHITECTURAL, MECHANICAL, ELECTRICAL AND STRUCTURAL DRAWINGS FOR ADDITIONAL OPENINGS THROUGH FLOORS

WALLS, AND CEILINGS FOR DUCT, PIPE & ELECTRICAL RISERS AND ALL OPENINGS NOT

SHOWN ON DRAWINGS. ALL OPENINGS THROUGH THE FIRE SEPARATIONS AS A RESULT OF THE WORK OF THIS CONTRACT ARE TO BE FIRE STOPPED AND SEALED WITH ULC APPROVED FIRE STOPPING TO MAINTAIN THE INTEGRITY OF THE FIRE SEPARATION, AND PROVIDE AND SMOKE-TIGHT

Barrier. ALL PRODUCTS AND MATERIALS TO BE USED AND INSTALLED SHALL CONFORM WITH

MANUFACTURER'S SPECIFICATIONS & APPLICABLE CODES.

THE CONTRACTOR SHALL BE RESPONSIBLE TO PATCH AND MAKE GOOD ALL EXISTING CONSTRUCTION AFFECTED BY THE REMOVAL OF ALL ITEMS FORMING THE PART OF THE RENOVATION WORK.

WHERE NEW FLOORING AND BASE IS TO BE INSTALLED IN EXISTING AREAS (REFER TO FLOOR PLAN AND ROOM SCHEDULE) THE EXISTING FLOORING SURFACE AND BASE MUST BE REMOVED, UNLESS OTHERWISE NOTED. ALL FLOOR SURFACES SHALL BE PREPARED IN ACCORDANCE TO MANUFACTURER'S RECOMMENDATIONS FOR INSTALLATION OF NEW

WHERE PAINTING OF EXISTING WALLS IS INDICATED ON THE ROOM SCHEDULE, THESE WALLS MUST BE CLEANED OF ANY EXISTING WALL COVERING, PATCHED & PREPARED TO ACCEPT NEW MATERIAL, UNLESS OTHERWISE NOTED.

GENERAL NOTES:

1. THE ELECTRICAL SUBCONTRACTOR SHALL COORDINATE EXACT LOCATIONS OF MECHANICAL EQUIPMENT WITH THE MECHANICAL DRAWINGS PRIOR TO BID.

KEYNOTES:


 $\langle\!\langle 1 \rangle\!\rangle$ disconnect and remove all associated wiring, conduit, connectors, ETC. FOR EXISTING HRV-1.

 $\langle\!\langle 2 \rangle\!\rangle$ in the event that the mechanical contractor provides equipment REQUIRING A DIFFERENT MOCP FOR HRV-1, THE ELECTRICAL SUBCONTRACTOR SHALL PROVIDE A NEW BREAKER TO MATCH EXISTING IN ALL RESPECTS. THE ELECTRICAL SUBCONTRACTOR SHALL DETERMINE THE SHORT CIRCUIT INTERRUPTING RATING OF THE PANEL ON-SITE AND COORDINATE THE MOCP OF NEW HRV-1 PRIOR TO BID.

 \ll 3 \gg New Breakers for Panel 'a' shall match existing in all respects. The ELECTRICAL SUBCONTRACTOR SHALL DETERMINE THE SHORT CIRCUIT INTERRUPTING RATING OF THE PANEL ON-SITE.

4 EXISTING PANEL 'A' IS LABELED WITH A HAND CROSSED OUT LAMACOID DISPLAYING 'PANEL B'.

 \ll 5 \gg disconnect and remove all associated wiring, conduit, connectors, ETC. FOR EXISTING EF-7 DOWNSTREAM OF THE EXISTING STARTER.

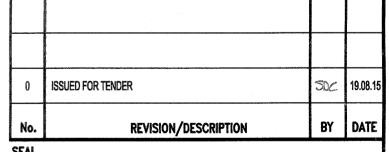



SDC			-	CLS					
DF	RAWN		CHECKED		DESIGNED		APPROVED		
DA	ATE		USER Approval						



THE CITY OF WINNIPEG
PLANNING, PROPERTY AND
DEVELOPMENT DEPARTMENT
MUNICIPAL ACCOMMODATIONS DIVISION
3-65 GARRY STREET, R3C 4K4

PROJECT ROOFTOP HEAT RECOVERY VENTILATOR REPLACEMENT **BONIVITAL POOL**

1215 ARCHIBALD STREET

SHEET TITLE

ELECTRICAL PARTIAL SINGLE LINE DIAGRAM AND LUMINAIRE SCHEDULE

SCALE **AS SHOWN**

ENGINEERS GEOSCIENTISTS Certificate of Authorization KGS Group

No. 245