


## MAIN FLOOR NOTES:

- REMOVE ALL EXISTING EXTERIOR WOOD SIDING FROM BUILDING BACK TO EXISTING EXTERIOR SHEATHING
- REMOVE EXISTING FRONT ENTRANCE DOOR, TRANSLE AND TRIM. FRAME NEW OPENING IN EXISTING WALL REMOVE EXISTING FRONT ENTRANCE DOOR, FRAME REFER TO STRUCTURAL DRAWINGS FOR DETAILS
- REMOVE EXISTING WOOD ENCLOSURE AROUND STAIRS LEADING TO DRY WELL
- REMOVE ALL EXISTING INTERIOR MASONITE WALL COVER
- SALVAGE AND REUSE ALL INTERIOR FIR TRIM SAND PRIME AND PAINT WHITE TO MATCH INTERIOR WALL FINISH (TYP.)
- PROVIDE NEW 19x89 WOOD TRIM ARCOND .....
  PRIME AND PAINT WHITE TO MATCH INTERIOR WALL PROVIDE NEW 19x89 WOOD TRIM AROUND NEW OPENINGS
- FRAME NEW OPENING IN EXISTING WALL TO ACCOMMODATE NEW DOOR LOCATION REFER TO STRUCTURAL DRAWINGS FOR DETAILS
- PAINT EXISTING INTERIOR RAILINGS AROUND HATCH SAFETY YELLOW
- FRAME IN EXISTING WINDOW OPENINGS TO ACCEPT NEW EXTERIOR AND INTERIOR FINISH FRAME TO MATCH EXISTING
- FRAME IN WALL OPENINGS DUE TO REMOVAL OF EXISTING EQUIPMENT FRAME TO MATCH EXISTING
- NEW DEMIZING WALL FRAME IN BETWEEN JOISTS UP TO ROOF DECK SEE WALL SCHEDULE FOR WALL CONSTRUCTION
- EXISTING WOOD BEAM AND COLUMNS PAINT WHITE TO MATCH NEW INTERIOR FINISH
- REMOVE (4) FOUR CHAINLINK FENCE POSTS LOCATED ADJACENT TO SOUTH WALL
- FINISH SITE GRADING DUE TO REMOVAL OF CONCRETE ENTRANCE PAD WITH TOPSOIL AND SOD TO LIMITS OF
- NEW CONCRETE ENTRANCE SLAB REFER TO STRUCTURAL DRAWINGS FOR DETAILS

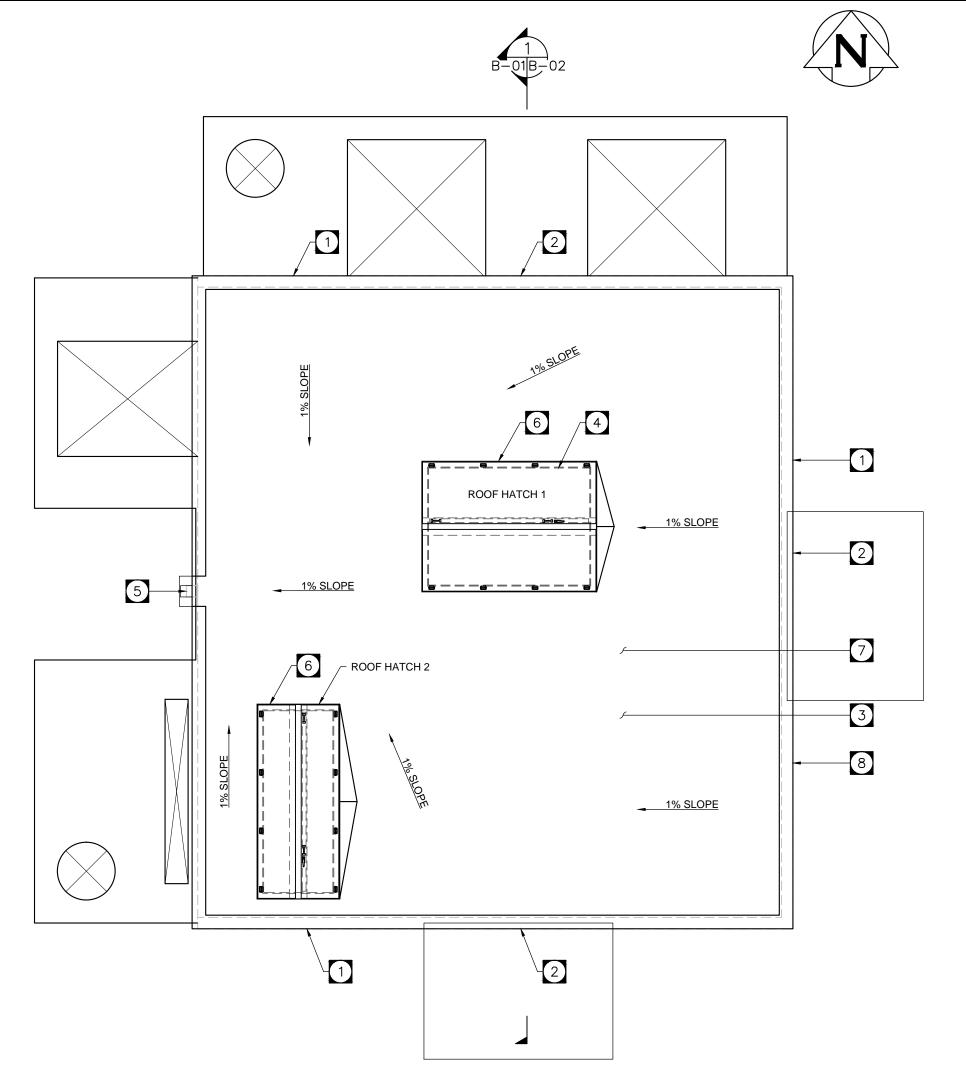

# ROOF NOTES:

- REMOVE EXISTING WOOD PARAPET INSTALL NEW WOOD PARAPET AS PER DETAILS
- REMOVE EXISTING WOOD SOFFIT AND FASCIA INSTALL NEW WOOD SOFFIT AND FASCIA AS PER DETAILS
- REMOVE EXISTING ROOF COVER DOWN TO DECKING INSPECT DECKING AND REPLACE SUB STANDARD
- DECK MATERIAL AS REQUIRED REMOVE EXISTING ROOF HATCH AND CURB
- REMOVE EXISTING DOWNSPOUT INSTALL NEW SCUPPER AND OPEN FACE 125mm

CONFIRM DIMENSIONS

- DOWNSPOUT 6 FRAME NEW CURB TO ACCEPT NEW MANUFACTURED ROOF HATCH (SEE DETAIL), CONTRACTOR TO FIELD
- INSTALL NEW MODIFIED BITUMINOUS ROOFING SYSTEM AS PER THE DRAWINGS AND SPECIFICATIONS
- 8 USE NRCA ROOFING AND FLASHING DETAILS TO ALL ROOF/CANOPY CONNECTIONS FLASH AND COUNTER FLASH

# ROOF PLAN SCALE: 1:50

# GENERAL NOTES:

- 1. USE ONLY THE LATEST ISSUES OF ANY GOVERNMENT CODES, STANDARDS, OR REGULATIONS MENTIONED IN THE FOLLOWING NOTES.
- 2. EXCEPT WHERE NOTED OTHERWISE, PROVIDE ALL MATERIALS AND WORKMANSHIP IN ACCORDANCE WITH THE REQUIREMENTS OF THE CURRENT EDITIONS OF THE NATIONAL BUILDING CODE OF CANADA (NBC).
- 3. CHECK ALL DIMENSIONS, LEVELS, AND ELEVATIONS PROVIDED BY THE STRUCTURAL DRAWINGS WITH OTHER CONTRACT DOCUMENTS AND REPORT ANY INCONSISTENCIES TO THE ENGINEER BEFORE PROCEEDING WITH THE WORK.
- 4. READ THE DRAWINGS IN CONJUNCTION WITH SPECIFICATIONS AND OTHER CONTRACT DRAWINGS.
- 5. SPECIFIC NOTES AND DETAILS SHOWN ON THE DRAWINGS TAKE PRECEDENCE OVER THE GENERAL NOTES AND TYPICAL DETAILS.
- 6. FOR SIZE AND LOCATIONS OF MECHANICAL AND ELECTRICAL EQUIPMENT AND OPENINGS, EQUIPMENT BASES, AND TRENCHES NOT INDICATED ON BUILDING DRAWINGS, SEE STRUCTURAL, MECHANICAL, AND ELECTRICAL DRAWINGS. VERIFY ALL DIMENSIONS WITH THE MECHANICAL AND ELECTRICAL CONTRACTORS.
- 7. COORDINATE WITH ALL OTHER TRADES WHERE SUCH TRADES AFFECT THE STRUCTURE.
- 8. TYPICAL FIRE SEPARATION WALLS ASSEMBLIES SHALL BE EXTENDED FROM FLOOR LEVELS AND TERMINATED AT UNDERSIDE OF CEILING/ROOF MEMBRANES.

#### QUANTITY NO. DOOR SIZE HARDWARE CODES MATERIAL **FINISH** ELEVATION \*\*\*ALL DOOR SWINGS ARE AS SHOWN ON DRAWING\*\*\* DOOR CLOSER SELF-LATCHING HARDWARE D100 1830x2030x45 METAL, INSULATED PAINTER STEEL STIFFENED. WELDED FRAME A, B, C, D, F, G, I, J, K, L, M, N, P, LOCKABLE 1 D101 1067x2030x45 METAL, INSULATED PAINTED 2 STEEL STIFFENED, WELDED FRAME A, B, C, D, F, G, I, J, K, L, M, N, P, PASSAGE SET PANIC HARDWARE NOTES: PUSH/PULL BARRÍER FREE HARDWARE 1. PASSAGE HARDWARE INSTALLED AT 1000mm AFF. KICK PLATE 2. ALL EXTERIOR DOORS AND FRAMES TO BE INSULATED. DOOR STOP 3. ALL STEEL FRAMES TO BE WELDED. WEATHER STRIPPING 4. ALL DOORS LOCATED IN A FIRE SEPARATION ARE TO BE EQUIPPED WITH A POSITIVE LATCHING MECHANISM THRESHOLD DESIGNED TO HOLD THE DOOR CLOSED AFTER EACH USE IN ACCORDANCE TO NATIONAL BUILDING CODE. SWEEP 5. AFFIX BARRIER-FREE SIGNAGE TO DOORS AS PER NATIONAL BUILDING CODE. KEY ACCESS FROM EXIT 6. DOUBLE DOOR TO INCLUDE LOCKING THUMB LATCH ON EXTERIOR OF LEFT LEAF, SELF CLOSER ON LEFT LEAF WASHROOM SET (PRIVATE) DOOR ELEVATIONS WITH HOLD OPEN. SWING LIMITING HOLD OPEN ON RIGHT LEAF. WIND LIMITER - CHECK CHAIN UNIVERSAL BARRIER FREE SIGNAGE POWER DOOR OPERATOR FULL LENGTH ASTRAGAL

### WALL SCHEDULE EXISTING EXTERIOR WALL PRE-FINISHED FIBER CEMENT CLADDING AND TRIM (COLOUR: PEARL GRAY) TYPAR BUILDING WRAP EXISTING 19mm SHIPLAP EXISTING 38mm x 89mm FIR WOOD STUDS @ 400mm o/c CLOSED CELL SPRAY FOAM INSULATION R20 13mm GOOD ONE SIDE PLYWOOD PAINTED (COLOUR: WHITE) CAULK JOINTS AND FILL SCREW HOLES EXTERIOR INFILL WALL PRE-FINISHED FIBER CEMENT CLADDING AND TRIM (COLOUR: PEARL GRAY) TYPAR BUILDING WRAP 19mmPLYWOOD SHEATHING 38mm x 89mm WOOD STUDS @ 400mm o/c CLOSED CELL SPRAY FOAM INSULATION R20 13mm GOOD ONE SIDE PLYWOOD PAINTED (COLOUR: WHITE) CAULK JOINTS AND FILL SCREW HOLES PARTITION WALL 13mm GOOD ONE SIDE PLYWOOD PAINTED (COLOUR: WHITE) CAULK JOINTS AND FILL SCREW HOLES 38mm x 89mm WOOD STUDS @ 600 o/c ON 89mm WIDE x 140mm HIGH CONCRETE CURB CLOSED CELL SPRAY FOAM INSULATION R20 13mm GOOD ONE SIDE PLYWOOD PAINTED (COLOUR: WHITE) CAULK JOINTS AND FILL SCREW HOLES

DOOR SCHEDULE

**METRIC** WHOLE NUMBERS INDICATE MILLIMETRES DECIMALIZED NUMBERS INDICATE METRES

ENGINEERS GEOSCIENTISTS Certificate of Authorization Neegan Burnside Ltd. No. 3051

WARNING IF POWER EQUIPMENT OR EXPLOSIVES ARE TO BE USED FOR EXCAVATION ON THIS PROJECT THE CONTRACTOR MUST: 1) NOTIFY THE GAS COMPANY OF THE

PROPOSED LOCATION OF EXCAVATION. 2) TAKE PRECAUTION TO AVOID DAMAGE TO GAS COMPANY INSTALLATIONS. SEE PROVINCIAL REGULATION 210/72 FOR DETAILS

LOCATION APPROVED UNDERGROUND STRUCTURES SUPV. U/G STRUCTURES COMMITTEE DATE NOTE: LOCATION OF UNDERGROUND STRUCTURES AS SHOWN ARE BASED ON THE BEST INFORMATION AVAILABLE BUT NO GUARANTEE IS GIVEN THAT ALL

LOCATIONS ARE EXACT. CONFIRMATION OF

EXISTENCE AND EXACT LOCATION OF ALL

ENGINEER'S SEAL Neegan Burnside Limited ELEV. 307 Commerce Drive **NEEGAN**BURNSIDE Winnipeg, Manitoba, R3P 1B3 CONSTRUCTION COMPLETION DATE: YYYY MM DD telephone (204) 949-7110 fax (204) 949-7111 web www.neeganburnside.com DESIGNED CHECKED GP MS APPROVED CT 3 ISSUED FOR TENDER 2019 05 31 CT | SCALE: AS NOTED RELEASED FOR CONSTRUCTION EXISTING UTILITIES ARE SHOWN OR THAT THE GIVEN 2 ISSUED FOR 99% REVIEW 2019 05 09 CT | HORIZONTAL CONSULTANT DRAWING NUMBER 2019 04 17 CT VERTICAL 1 ISSUED FOR 66% REVIEW SERVICES MUST BE OBTAINED FROM THE INDIVIDUAL UTILITIES BEFORE PROCEEDING WITH CONSTRUCTION. REVISIONS DATE BY DATE 2019 05 30 PLOT DATE: 2019 05 30

Winnipeg

# THE CITY OF WINNIPEG

WATER AND WASTE DEPARTMENT **ENGINEERING DIVISION** 

MISSION FPS UPGRADES SHEET OF CITY DRAWING NUMBER BUILDING 1-0163F-B0001-001 MAIN FLOOR PLAN, ROOF PLAN AND NOTES

TENDER No.: 269-2019 CONTRACT NUMBER: X

B-01

FILE NAME: 043882 B-01.dwg

FILE PATH: X:\Land Desktop\300043882 City of Winnipeg Mission Flood Pumping Station\Dwg\Contr