


1 MAIN FLOOR PLAN - TRACK 13-24 - NEW CONSTRUCTION - HYDRONICS
SCALE: 1/8" = 1'-0"
M2.5

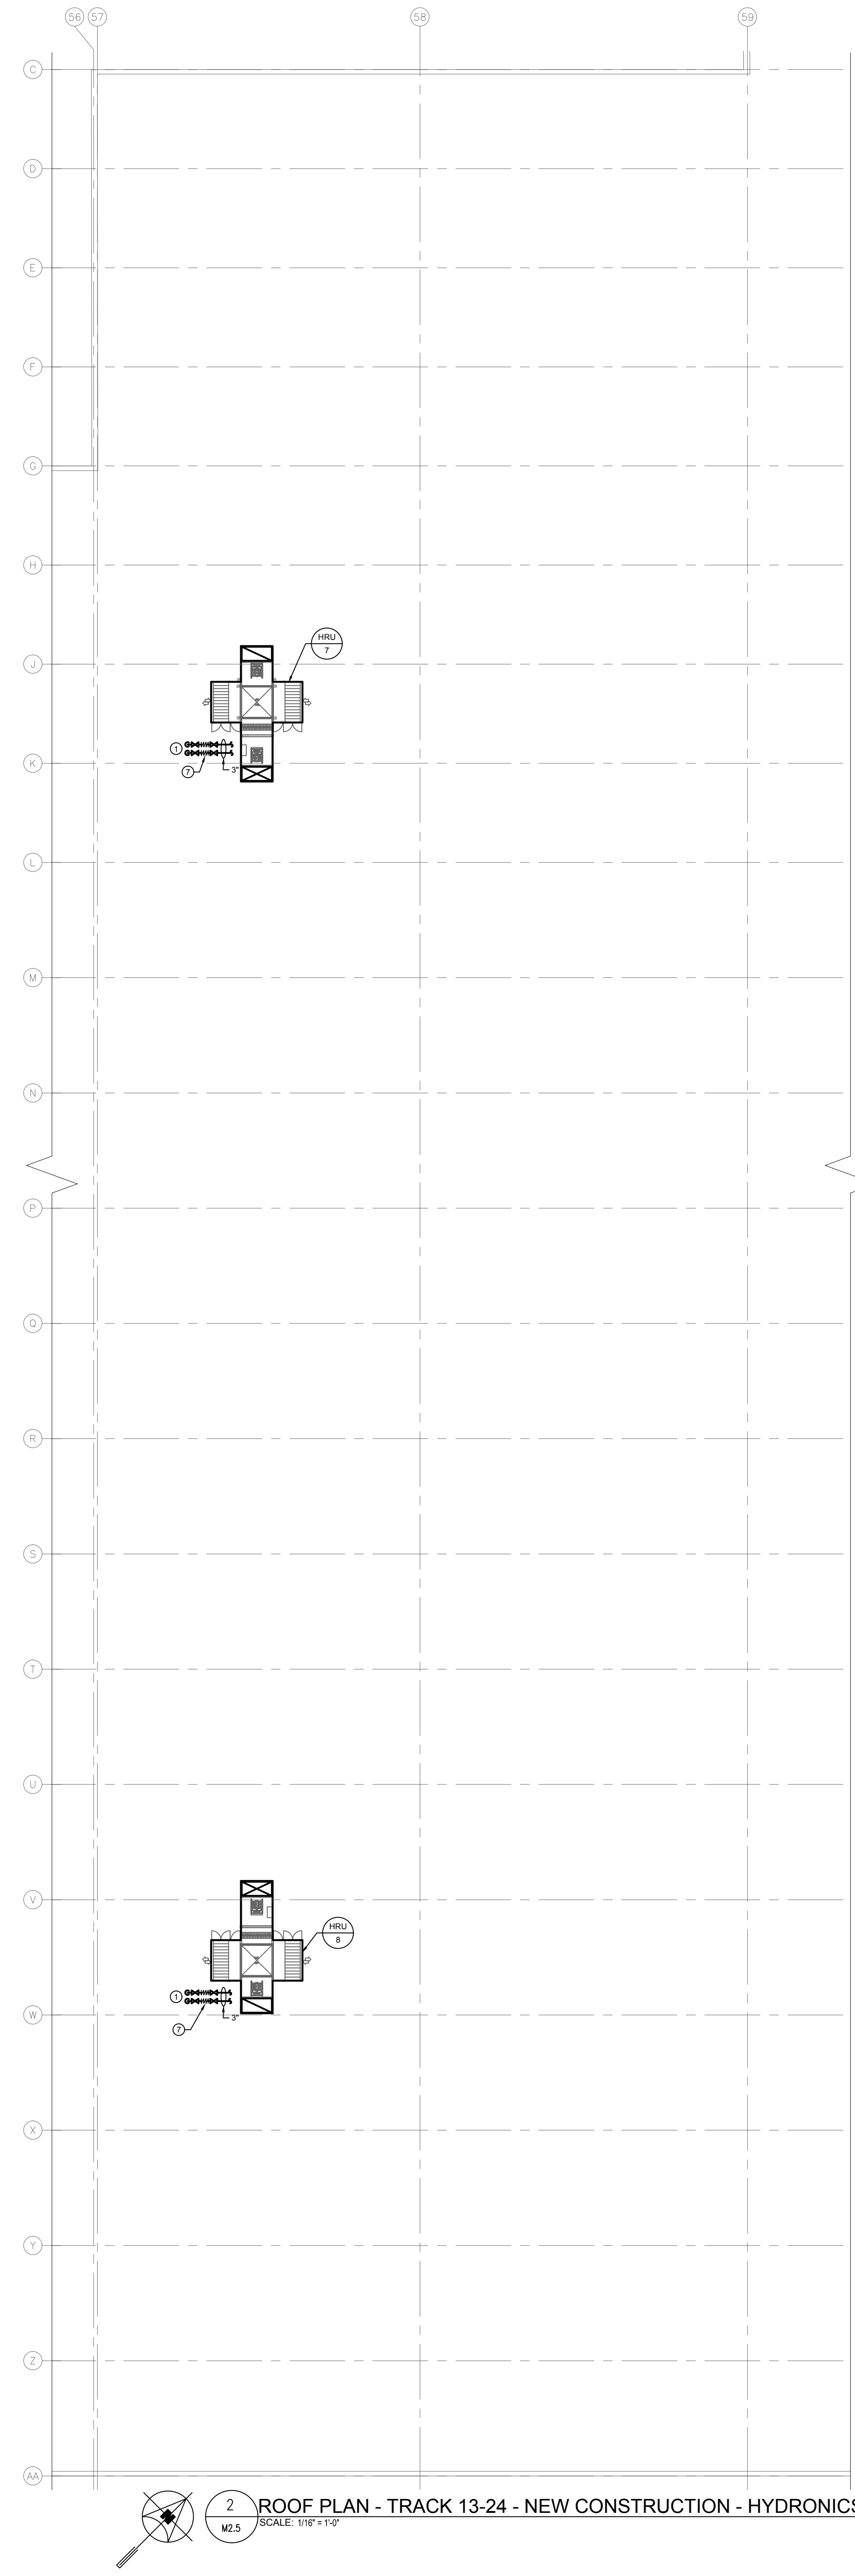


2 ROOF PLAN - TRACK 13-24 - NEW CONSTRUCTION - HYDRONICS
SCALE: 1/8" = 1'-0"
M2.5

GENERAL NOTES

- A. THIS BUILDING MAY CONTAIN ASBESTOS. REFER TO FRONT END SPECIFICATIONS FOR FURTHER INFORMATION.
- B. REFER TO ROOF DETAILS AND SPECIFICATIONS FOR ALL NEW AND CAPPED OPENINGS.

KEY NOTES

1. CONNECT GHS AND GHR TO NEW HRUS ON ROOF.
2. EXISTING CONOX CONTROLLER BESIDE FIRE ALARM PANEL.
3. CONOX DETECTORS TIED INTO EXISTING CONTROLLER.
4. HEAT RECOVERY UNITS THERMOSTATS.
5. CAP LINES FOR FUTURE.
6. CONNECT NEW 4" GHS AND GHR PIPING TO EXISTING.
7. NEW FLEX CONNECTIONS TO ACCOMMODATE UP TO 2" OF LATERAL MOVEMENT OF STEEL STANDING.
8. FIRESTOP ALL NEW AND EXISTING PENETRATIONS THROUGH WALL AT GRIDLINE 59. WORK SHALL INCLUDE ALL MECHANICAL AND ELECTRICAL PENETRATIONS.
9. EXISTING JCI METABSYS CONTROL PANEL/AUTOMATION ENGINE.

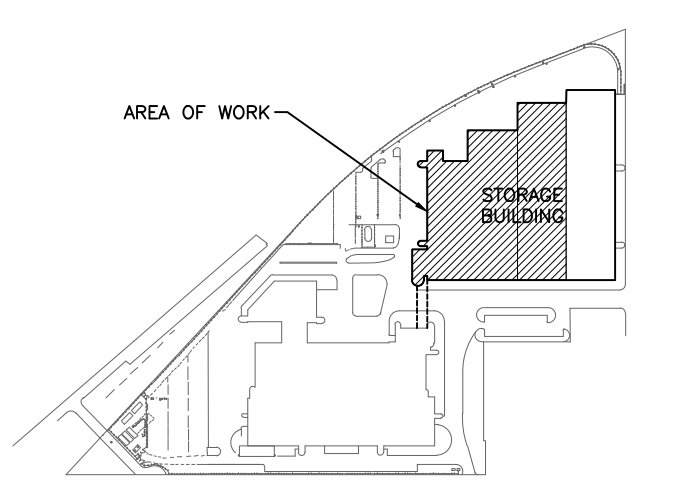

KEY PLAN
NTS

NO.	Description	BY	DATE
0	ISSUED FOR CONSTRUCTION	JH	09/11/18
		BY	DDMMYY

ENGINEERS
GEOSCIENTISTS
MANITOBA
 Certificate of Authorization
SMS Engineering Ltd.
 No. 166

770 Bradford Street
 Winnipeg, Canada
 T 204 775 0352
 SMSeng.com

Project Title
CITY OF WINNIPEG FORT ROUGE TRANSIT BASE - STORAGE TRACK 13-24 - MECHANICAL UPGRADE

WINNIPEG MANITOBA
 Drawing Title
MAIN FLOOR AND ROOF PLAN - TRACK 13-24 - NEW CONSTRUCTION - HYDRONICS

Drawn By JC/AS	Checked By XZ	Approved By JH
Scale AS NOTED	Date NOVEMBER, 2018	Project No. 18-240-01
Revision Number 0	Drawing Number M2.5	Sheet Order 10 of 12