
GYPSUM BOARD: **BUILDING CODE ANALYSIS: BUILDING DESCRIPTION (GENERAL):** INDOOR POOL WITH SPECTATOR SEATING AND THICKNESS. SHEETS TO BE OF LARGEST PRACTICAL SIZE WITH CIVIC ADDRESS: 25 POSEIDON BAY BEVELED EDGES FOR TAPING. WINNIPEG, MANITOBA **BUILDING CLASSIFICATION (NBC 2010):** CODE AND GOOD STANDARD PRACTICE. OCCUPANCY CLASSIFICATION: GROUP A, DIVISON 3 ANY HEIGHT, ANY AREA, SPRINKLERED NON-COMBUSTIBLE CONSTRUCTION FLOOR ASSEMBLIES: 2 HR F.R.R. MEZZANINES: 1 HR. F.R.R. LOAD BEARING ELEMENTS: F.R.R. TO MATCH SUPPORTED ASSEMBLY 3.2.2.29 NBC CONSTRUCTION ARTICLE: SPACE, MINIMUM. **BUILDING AREA:** NUMBER OF STOREYS: BASEMENT: RECEIVE FINISH. SPRINKLER: NON-COMBUSTIBLE CONSTRUCTION TYPE: PAINTING: NEW SERVICE ROOM PLATFORM CONSTRUCTION: SERVICE ROOM AREA: NON-COMBUSTIBLE CONSTRUCTION TYPE: FOR EXTERIOR SURFACES. NO - NBC 3.2.2.1.(6) PLATFORM IS INTENDED ONLY FOR PERIODIC INSPECTION. FLOOR ASSEMBLY F.R.R. NONE - NBC 3.2.2.1.(6) FLOOR IS CONSIDERED A PLATFORM AND NOT A STOREY OR MEZZANINE. FIRE SEPARATION: NO - NBC 3.6.2.1.(8) REGULATIONS. ROOM CONTAINS LIMITED EQUIPMENT AND DOES A FIRE HAZARD AND IS NOT ESSENTIAL TO THE OPERATION OF THE FIRE SAFETY SYSTEMS IN THE BUILDING. YES - NBC 3.3.1.14.(2) EGRESS STAIR: STAIRWAY SERVING THE SERVICE ROOM DOES NOT NEED TO CONFORM TO EXIT STAIR REQUIREMENTS UNDER NBC 3.3.1.14.(2). CURED. DEMOLITION: ALL DEMOLITION WORK SHALL BE DONE IN ACCORDANCE WITH THE REQUIREMENTS OF ALL PERTINENT BUILDING CODES, THE MANITOBA DEPARTMENT OF LABOUR, AND ANY OTHER PROVINCIAL AND LOCAL TO LEAVE FULL, NEAT, WELL DEFINED TERMINATIONS. BY-LAWS, REGULATIONS AND ORDINANCES. DEMOLITION SHALL INCLUDE THE SAFE REMOVAL, HAULING AND DUMPING AND FINISH COATS UNLESS SPECIFIED. OF ALL DEBRIS, ETC. TO AN APPROVED SITE. ALL COSTS ASSOCIATED WITH THIS OPERATION, INCLUDING TRANSPORT, LICENSES AND FEES SHALL BE THE RESPONSIBILITY OF THE CONTRACTOR. COMPLETE PROTECTION AND SMOOTH FINISH. COORDINATE THE MOVING AND STORAGE OF SALVAGED ITEMS. MATERIALS, EQUIPMENT, ETC. WITH THE CONTRACT ADMINISTRATOR. ACCEPTABLE PRODUCTS: BENJAMIN MOORE, INTERNATIONAL, PITTSBURGHPAINTS, PRATT & LAMBERT, DULUX, AND AS NOTED STEEL STUD FRAMING (NON-LOADBEARING): PAINTING: **GENERAL** FORMULAE: THE THICKNESS SPECIFIED REFERS TO THE NOMINAL BASE STEEL GYPSUM BOARD THICKNESS EXCLUSIVE OF ANY COATINGS. 1 COAT PRIMER SEALER 2 COATS SEMI-GLOSS ACRYLIC LATEX INSTALL ALL FRAMING PLUMB, LEVEL, AND SQUARE. STEEL DOORS/FRAMES (BOTH SIDES) PROVIDE WOOD AND/OR METAL BLOCKING/BACKING AT ALL TOILET 1 COAT UNIVERSAL METAL PRIMER PARTITIONS, CABINETWORK, PLUMBING FIXTURES, LOCKERS, ETC., AND - 2 COATS SEMI-GLOSS ACRYLIC LATEX ANY LOCATION WHERE OTHER TRADES REQUIRE SOLID BACKING. MISCELLANEOUS STEEL AND FRAMING (SHOP PRIMED) INTERIOR WALL FRAMING 1 COAT UNIVERSAL METAL PRIMER - 1 COAT SPOT PRIMER (APPLY TO ALL EXPOSED, DAMAGED, SCRATCHED INTERIOR WALL STEEL STUDS, TRACK, FURRING BARS, ETC. TO BE 0.455mm OR RUSTED AREAS) (25 GA.) SECTIONS ROLL FORMED FROM ZINC COATED SHEET STEEL TO - 2 COATS SEMI-GLOSS ALKYD ENAMEL ASTM C645-14. SEE DRAWINGS FOR SECTION SIZES AND SPACING. PROVIDE DOUBLE FULL HEIGHT 20 GA. STUDS AT ALL DOORS, AND OTHER HARDWARE: OPENINGS REQUIRED A STUD TO BE INTERRUPTED. PROVIDE 20 GA. (1.0mm) THICK HEAD AND SILL FRAMING AT THESE OPENINGS. PATCHING - GENERAL DOORS. PATCH EXISTING FLOOR, WALL, CEILING ASSEMBLIES, ETC. WHERE REQUIRED DUE TO DEMOLITION/RENOVATION WORK TO MATCH EXISTING EXISTING DOOR HARDWARE IN EXISTING BUILDING. CONSTRUCTION, MATERIALS, TEXTURES AND FINISHES UNLESS NOTED OR PERMITTED OTHERWISE. 3. KICKPLATES TO BE STANDARD METAL STAINLESS STEEL UNITS. SIZE TO SUIT REQUIREMENTS. USE ONLY NEW MATERIALS TO BLEND WITH EXISTING EXCEPT WHERE THE USE OF SALVAGED EXISTING MATERIALS WOULD BE DESIRABLE AND IS PERMITTED BY THE CONTRACT ADMINISTRATOR. EXISTING ASSEMBLIES THAT ARE DAMAGED OR WEAKENED IN ANY WAY DUE TO DEMOLITION AND RENOVATION WORK, SHALL BE RESTORED TO THEIR FORMER STATE BY REINFORCING, REBUILDING, OR REPLACEMENT, TO THE SATISFACTION OF THE CONTRACT ADMINISTRATOR. PATCHED WALL AREAS SHALL BE PAINTED TO INCLUDE THE ENTIRE SURFACE PLANE TO THE NEAREST CORNERS AND WALL AND CEILING INTERFACES UNLESS PERMITTED OTHERWISE. ADDRE

1. GYPSUM BOARD IN ACCORDANCE WITH CAN/CSA-82.27 (LATEST). BOARD TO BE STANDARD TYPE, REGULAR AND TYPE 'X', EXTERIOR SHEATHING GRADE, AND SOFFIT GRADE AS NOTED. ALL PRODUCTS AS MANUFACTURED BY CGC, GP GYPSUM, CERTAINTEED OR EQUAL. SEE DRAWINGS FOR TYPES

- INSTALL ALL GYPSUM BOARD SQUARE, PLUMB AND LEVEL, IN ACCORDANCE WITH MANUFACTURER'S RECOMMENDATIONS, THE NATIONAL BUILDING
- 3. FASTEN BOARD TO STEEL FRAMING USING S-12 DRYWALL SCREWS. USE CORROSION-RESISTANT SCREWS FOR ALL EXTERIOR OR WET AREA APPLICATIONS. ALL SCREWS MUST PROVIDE 13mm MINIMUM THREAD ENGAGEMENT IN STEEL FRAMING. SPACE FASTENERS FOR INTERIOR WORK AT 300mm O/C MAXIMUM ALONG ALL SUPPORTS FOR ALL LAYERS OR AS REQUIRED FOR TESTED ASSEMBLY. INSTALL BOARD PARALLEL OR PERPENDICULAR TO FRAMING, STAGGERING ALL JOINTS BY ONE FRAMING
- PROVIDE CORNER BEADS, FILL TYPE 'J' TRIM (REGULAR AND SELF-MASKING) AND OTHER ACCESSORIES AS REQUIRED AND NOTED. FINISH ALL JOINTS WITH 3 COAT SYSTEM: TAPE EMBEDDED WITH JOINT COMPOUND, AND 2 COATS OF FINISHING COMPOUND. SAND SMOOTH. PROVIDE SKIM COAT OVER ENTIRE GYPSUM BOARD SURFACE AND SAND SMOOTH, READY TO
- ALL COMPONENTS FOR INDIVIDUAL PAINTING FORMULAE TO BE PRODUCTS OF A SINGLE MANUFACTURER AND SHALL BE COMPATIBLE WITH EACH OTHER. ALL MATERIALS TO BE PREMIUM GRADE. USE EXTERIOR GRADE
- STORE, HANDLE, AND APPLY ALL PAINTS AND ASSOCIATED MATERIALS IN ACCORDANCE WITH MANUFACTURER'S RECOMMENDATIONS. DO NOT DILUTE PAINT UNLESS RECOMMENDED BY MANUFACTURER OR OTHERWISE APPROVED OR NOTED. DISPOSE OF UNUSED PAINTING MATERIALS IN A SAFE MANNER AND IN ACCORDANCE WITH ALL PERTINENT GOVERNMENTAL
- 3. IN GENERAL, PROTECT ALL ADJACENT AREAS, SURFACES, FIXTURES, EQUIPMENT, SERVICES, ETC. FROM OVERSPRAY, OVERLAP OR ANY OTHER CONTAMINATION RESULTING FROM PAINTING OPERATIONS. CONTRACTOR SHALL MASK, COVER, PROTECT AS APPROPRIATE, REMOVE COVER PLATES, SIGNAGE, HANGINGS, ETC. AS APPROPRIATE AND REPLACE AFTER PAINT IS
- CLEAN AND PREPARE ALL SUBSTRATES AS RECOMMENDED BY MANUFACTURER AND AS SPECIFIED BELOW TO PROVIDE FULL, UNINTERRUPTED BOND WITH PAINT SYSTEM. IN GENERAL, SAND LIGHTLY BUT THOROUGHLY BETWEEN ALL COATS. REMOVE ALL DUST AND OTHER CONTAMINANTS FROM SURFACES PRIOR TO PAINT APPLICATION, TO PRODUCE SMOOTH EVEN FINISH. NEATLY CUT OR MASK AS APPROPRIATE
- 5. PRIME ALL SURFACES WITH APPROPRIATE PRIMER TO SUIT SUBSTRATE
- 6. FIELD TOUCH UP ALL SHOP PAINTED ITEMS AS REQUIRED TO PROVIDE
- ALL COLOURS TO BE CONFIRMED BY CONTRACT ADMINISTRATOR.

- 1. HINGES TO BE STANDARD WEIGHT, FULL MORTISE, STAINLESS STEEL, BEARING HINGES. PROVIDE 1 1/2 PAIR MINIMUM PER STANDARD 914 x 2134 DOOR. PROVIDE ADDITIONAL HINGES AS REQUIRED FOR OVERSIZED
- 2. ALL EXIT DEVICES, LOCKSETS, CLOSURES, TRIMS AND FINISH TO MATCH

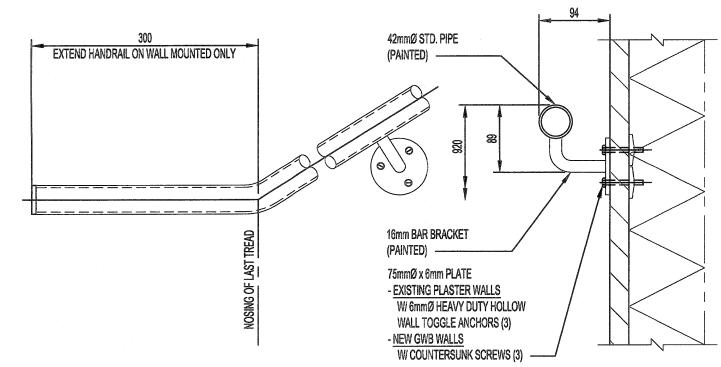

SCALE 1:5

42mmØ (DN32 XS) PIPE

16mm@ BOLTS C/W STD. NUTS

4.44.4

WALL MOUNTED HANDRAIL DETAIL

POSTS, TYP. —

& FLAT WASHERS

BAR 64x10mm

TYP. —

6mm PLATE

PRE-FABRICATED STEEL PAN STAIRS AND LANDINGS:

- 1. FABRICATE STEEL STAIRS AND LANDINGS WITH CLOSED RISERS AND TREADS OF METAL PAN CONSTRUCTION, READY TO RECEIVE CONCRETE.
- 2. FORM TREADS AND RISERS FROM MINIMUM 2MM THICK SHEET STEEL STOCK.
- 3. SECURE REINFORCED TREAD PANS TO STRINGERS WITH CLIP ANGLES,
- 4. FORM STRINGERS WITH ROLLED STEEL ANGLES.

WELD IN PLACE.

- FORM INTERMEDIATE LANDING WITH MINIMUM 2MM THICK SHEET STEEL STOCK.
- 6. FORM UPPER LANDING WITH CORRUGATED STEEL DECK INSTALLED WITH THE MECHANICAL PLATFORM FLOOR SYSTEM.
- 7. CONTRACTOR TO SITE VERIFY FLOOR TO FLOOR HEIGHTS AND ASSOCIATED DIMENSIONS PRIOR TO PREPARATION OF SHOP DRAWINGS.
- 8. REINFORCE UNDERSIDE OF LANDINGS WITH STEEL FRAMING AS REQUIRED TO ATTAIN DESIGN LOAD REQUIREMENTS.
- 9. GUARDRAILS AND HANDRAILS SHALL BE DESIGNED TO SUPPORT THE LOADS REQUIRED BY THE 2011 MBC (NBCC 2010) CLAUSE 4.1.5.14.
- 10. STAIRS AND LANDING SHALL BE DESIGNED TO SUPPORT THE WEIGHT OF THE STAIR ASSEMBLY INCLUDING CONCRETE PLUS A SPECIFIED UNIFORMLY DISTRIBUTED LOAD OF 4.8 kPa.
- 11. PRELIMINARY MEMBERS SIZES SHOWN ON THE DRAWINGS AND SUBJECT TO REVIEW AND CHANGE BY STAIR DESIGNER.
- 12. THE STAIR AND LANDING ASSEMBLY INCLUDING THE CONNECTIONS TO THE EXISTING STRUCTURE SHALL BE DESIGNED BY THE STAIR SUPPLIER. SUBMIT SHOP DRAWINGS SEALED BY A PROFESSIONAL ENGINEER REGISTERED IN THE PROVINCE OF MANITOBA FOR REVIEW PRIOR TO FABRICATION. SHOP DRAWINGS SHALL INCLUDE LAYOUT PLAN, DESIGN LOADS, CONNECTION DETAILS AND ALL OTHER PERTINENT INFORMATION.
- STEEL STAIR AND GUARDRAIL DESIGNER SHALL PROVIDE A FINAL INSPECTION AND A LETTER SEALED BY THE ENGINEER RESPONSIBLE FOR THE STAIR AND GUARDRAIL DESIGN CERTIFYING THAT THE STAIRS AND GUARDRAILS ARE CONSTRUCTED AND INSTALLED AS PER DESIGN ASSUMPTIONS AND INSTALLATION REQUIREMENTS.
- 14. STAIR, LANDINGS, GUARDRAILS AND HANDRAILS SHALL BE PRIME PAINTED WITH ONE COAT OF INTERZINC 52 SINC-RICH EPOXY (2.5 MILS DFT).

MAX. SPACES

BETWEEN POSTS

SECTION

SCALE 1:15

(DN32 STD) PIPE

TOP & MID RAILS

13mmx13mm STI

PICKETS @ 100mm O/C

- WORK LINE

CONC. FILLED STEEL PAN

13mmØ HAS ROD DRILLED &

EPOXY GROUT WITH HILTI HIT

HY-200 ADHESIVE SYSTEM

70mm MIN. EMBED.


TREAD, TYP.

C250x23 STRINGER

L38x38x4.8 TREAD

SUPPORT TYP.

HARDWARE DOOR SCHEDULE FIRE RATING DOOR NO. (HOURS) SECT. | MAT'L | FINISH REMARKS SIZE MAT'L. | CORE | FINISH REMARKS ELEV. D101 KHC TO MATCH EXIST. STL TO MATCH EXIST 900W x 2150H D102 900W x 2150H HM KHC TO MATCH EXIST. STL TO MATCH EXIST В |

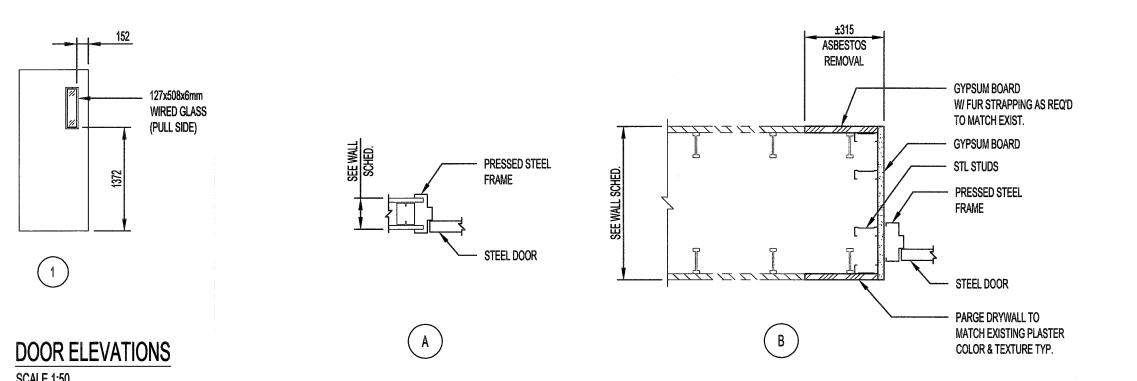

42mmØ (DN32 XS) PIPE

6x6 WELDED WIRE


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4 CONCRETE PAN TREAD DETAIL

MESH, TYP. ----

- / SCALE 1:5

POSTS, TYP.

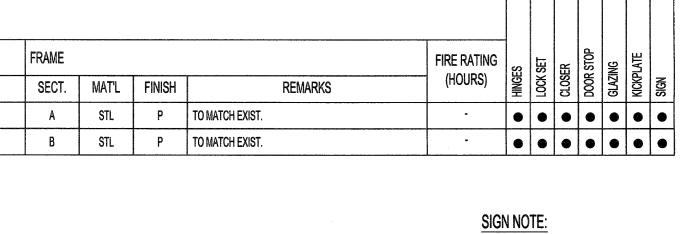

1. DOOR SIGN TO INCLUDE ROOM NAME

ABBREVIATIONS:

HOLLOW METAL INSULATION KHC KRAFT HONEYCOMB PRE-FINISHED PRESSED STEEL RUBBER

AND NUMBER TO BE COORDINATED WITH CONTRACT ADMINISTRATOR

STEEL

CONSTRUCTION AFFECTED BY THE REMOVAL OF ALL ITEMS FORMING THE PART OF THE RENOVATION WORK. WHERE NEW FLOORING AND BASE IS TO BE INSTALLED IN EXISTING AREAS (REFER TO

MANUFACTURER'S SPECIFICATIONS & APPLICABLE CODES.

NOTES:

SHOWN ON DRAWINGS.

THESE DRAWINGS SHALL NOT BE SCALED.

AND DETAILED INFORMATION SHOWN ARE CORRECT.

FLOOR PLAN AND ROOM SCHEDULE) THE EXISTING FLOORING SURFACE AND BASE MUST BE REMOVED, UNLESS OTHERWISE NOTED. ALL FLOOR SURFACES SHALL BE PREPARED IN ACCORDANCE TO MANUFACTURER'S RECOMMENDATIONS FOR INSTALLATION OF NEW

THE CONTRACTOR SHALL VISIT THE SITE AND SATISFY ONESELF ALL DIMENSIONS, DATUM,

THE CONTRACTOR IS TO REVIEW AND COORDINATE ALL ARCHITECTURAL, MECHANICAL,

ELECTRICAL AND STRUCTURAL DRAWINGS FOR ADDITIONAL OPENINGS THROUGH FLOORS

WALLS, AND CEILINGS FOR DUCT, PIPE & ELECTRICAL RISERS AND ALL OPENINGS NOT

ALL OPENINGS THROUGH THE FIRE SEPARATIONS AS A RESULT OF THE WORK OF THIS

CONTRACT ARE TO BE FIRE STOPPED AND SEALED WITH ULC APPROVED FIRE STOPPING

TO MAINTAIN THE INTEGRITY OF THE FIRE SEPARATION, AND PROVIDE AND SMOKE-TIGHT


ALL PRODUCTS AND MATERIALS TO BE USED AND INSTALLED SHALL CONFORM WITH


THE CONTRACTOR SHALL BE RESPONSIBLE TO PATCH AND MAKE GOOD ALL EXISTING

WHERE PAINTING OF EXISTING WALLS IS INDICATED ON THE ROOM SCHEDULE, THESE WALLS MUST BE CLEANED OF ANY EXISTING WALL COVERING, PATCHED & PREPARED TO ACCEPT NEW MATERIAL, UNLESS OTHERWISE NOTED.



FRAME SECTIONS

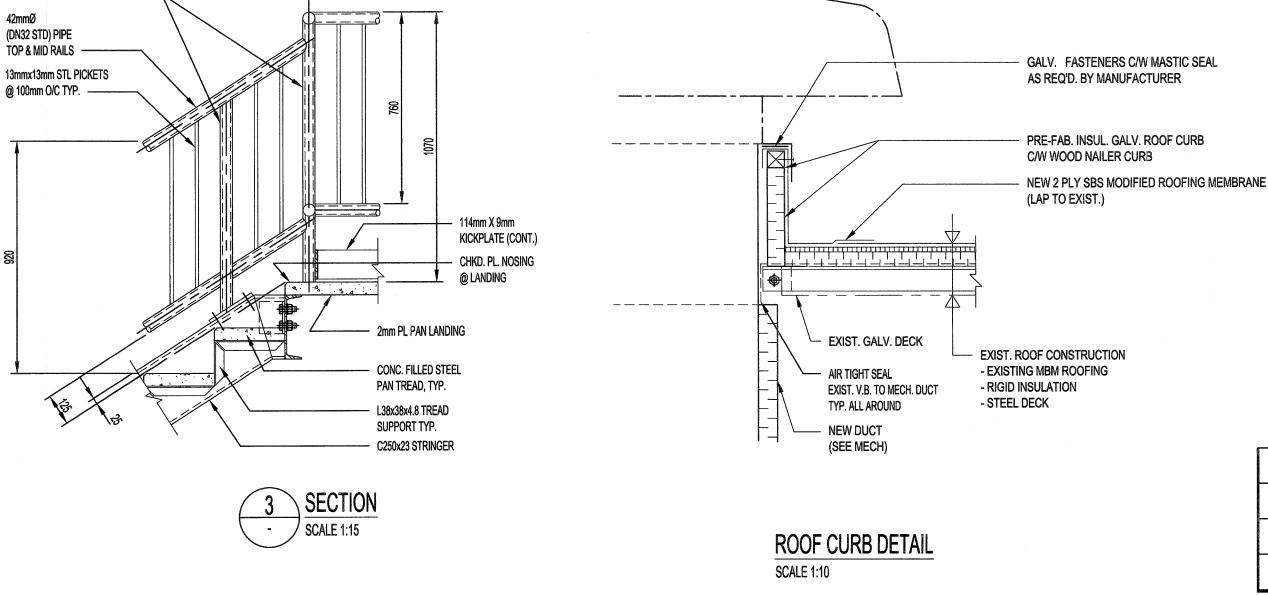

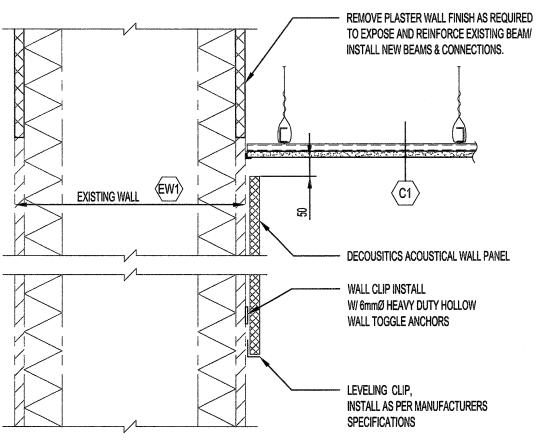

\ SECTION


SCALE 1:10

ENGINEERS GEOSCIENTISTS MANITOBA Certificate of Authorization KGS Group

No. 245



ISSUED FOR TENDER REVISION/DESCRIPTION

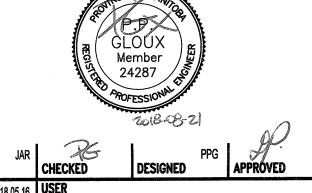

DATE 2018.05.16 USER **APPROVAL**



PROJECT BOILER ROOM COMBUSTION AIR UPGRADE

AT PAN AM POOL 25 POSEIDON BAY

SHEET TITLE

SCALE

BUILDING MECHANICAL EQUIPMENT SUPPORT DOOR SCHEDULE, SECTIONS & NOTES

SHEET No:

18-0107-006

DRAWING SHEET SIZE: A1 (841mm x 594mm) PLOT 1:1