




LAST SAVE: 2018/06/26 4:58 PM
 PATH: I:\AECOM\Projects\648484\180300\Work\0-CAD\02-SHEETS\01-0101-CRSW-Y003-01.dwg
 A1 SIZE - 594mm x 841mm

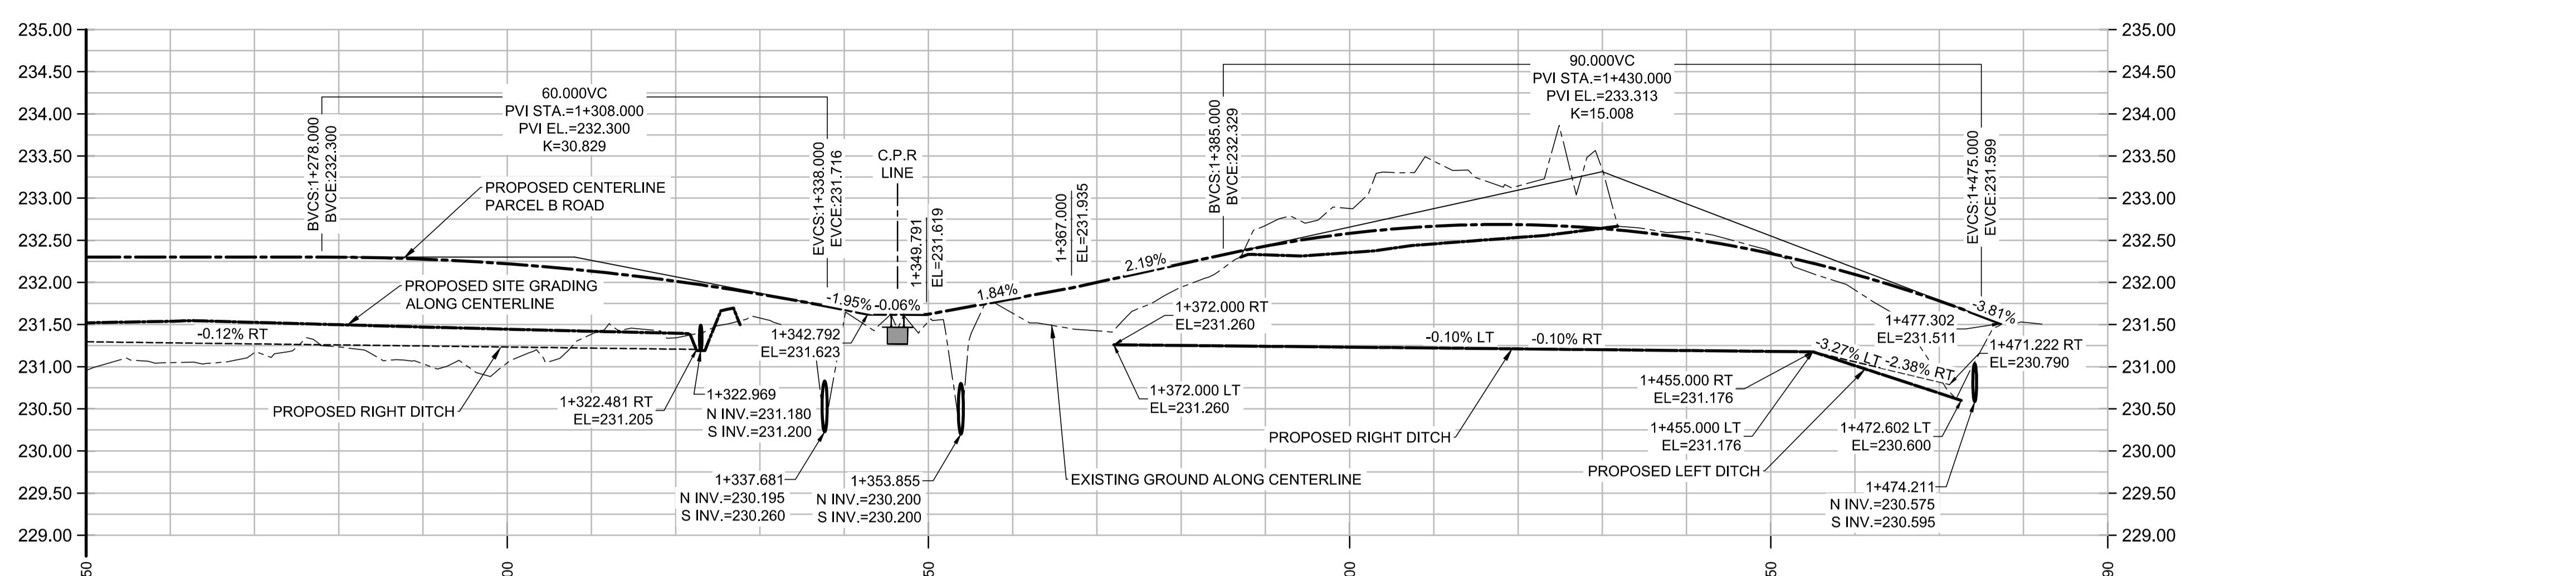


PROFILE
SCALE H 1:500 / V 1:50

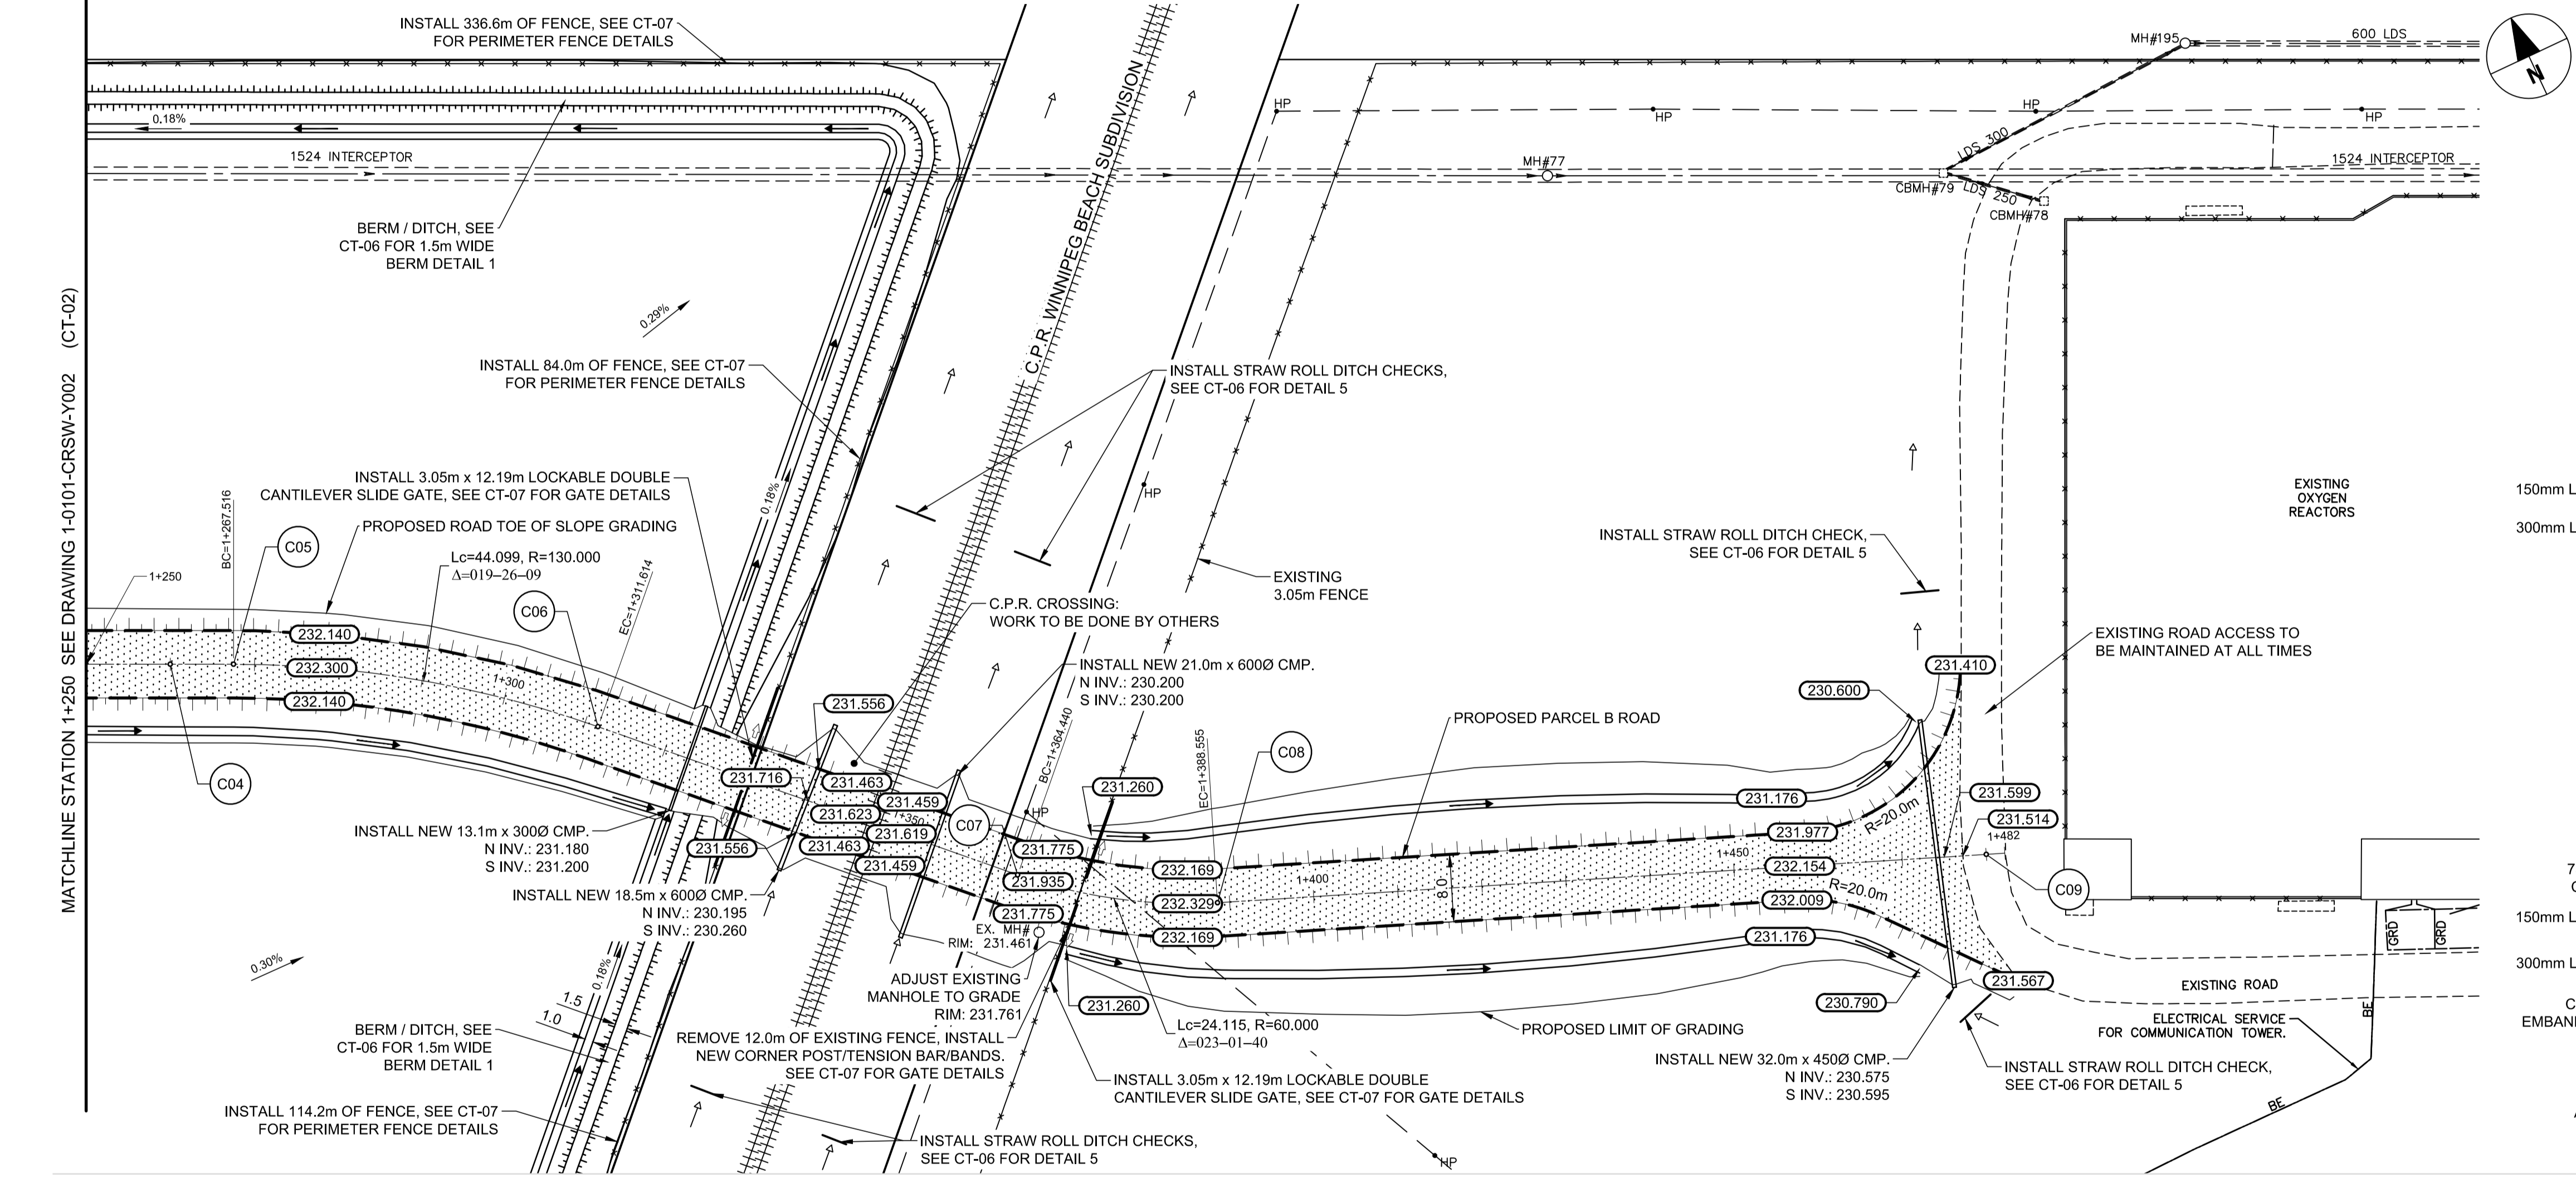


PLAN
SCALE 1:500

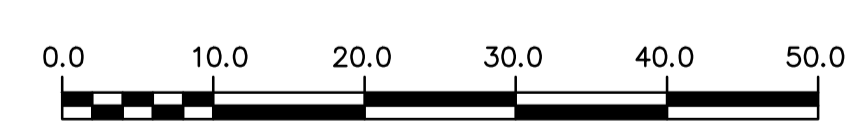

PARCEL B ROAD BASELINE UTM COORDINATES			
POINT I.D.	DESCRIPTION	NORTHING	EASTING
C04	PT = 1+260.000	5535343.176	635172.335
C05	BC = 1+267.516	5535339.977	635179.136
C06	EC = 1+311.614	5535314.859	635215.125
C07	BC = 1+364.440	5535277.748	635252.719
C08	EC = 1+388.555	5535264.661	635272.781
C09	PT = 1+480.000	5535230.995	635357.803

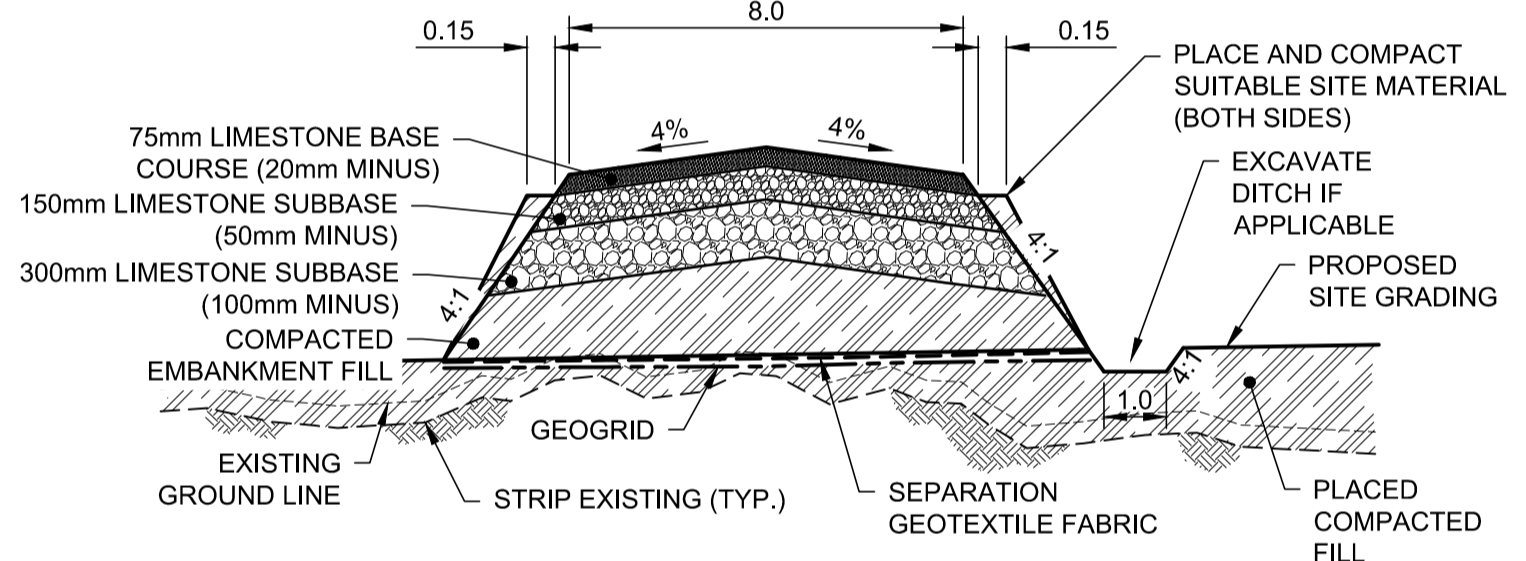

**TYPICAL CROSS SECTION
PARCEL B ROAD**
N.T.S.

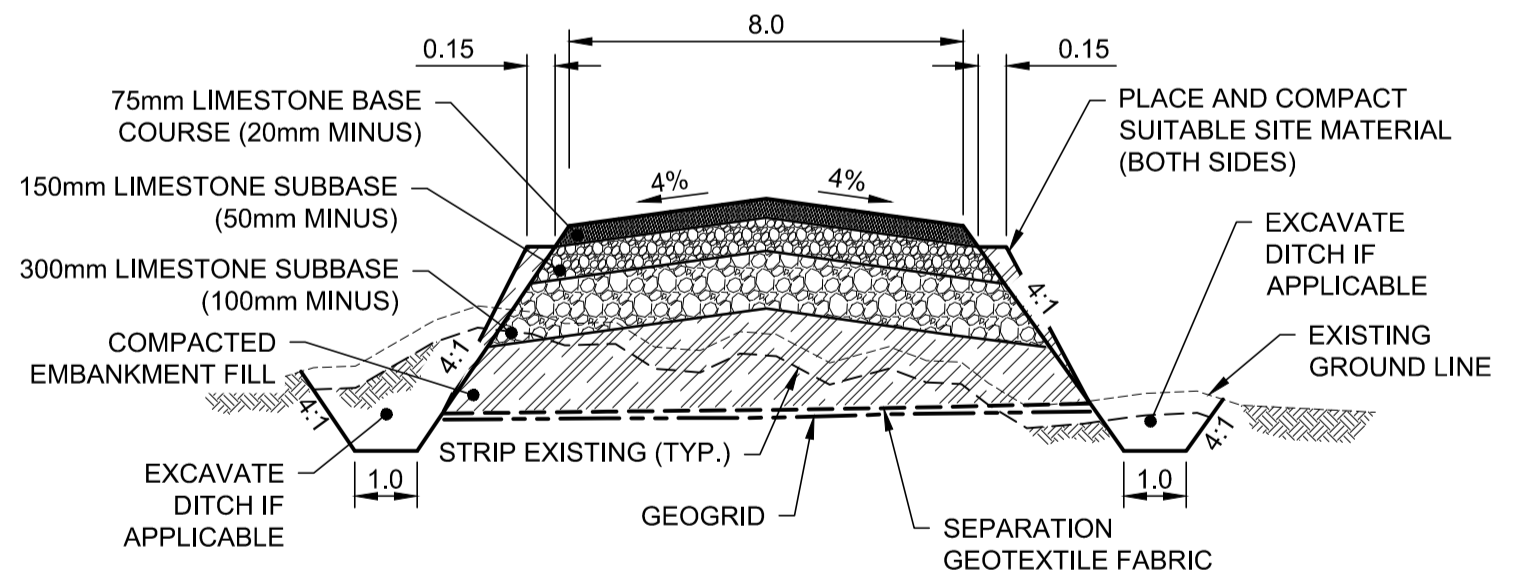

**TYPICAL CROSS SECTION
PARCEL A ROAD**
N.T.S.

- DRAWING NOTES**
- ALL COORDINATES ARE NAD 83 UTM ZONE 14
 - ALL WORK AND MATERIALS IN ACCORDANCE WITH CITY OF WINNIPEG STANDARD CONSTRUCTION SPECIFICATIONS.
 - LOCATION OF UNDERGROUND STRUCTURES AS SHOWN ARE BASED ON THE BEST INFORMATION AVAILABLE BUT NO GUARANTEE IS GIVEN THAT ALL EXISTING UTILITIES ARE SHOWN OR THAT THE GIVEN LOCATIONS ARE EXACT.
 - CONFIRMATION OF EXISTENCE AND EXACT LOCATION OF ALL SERVICES MUST BE OBTAINED FROM THE INDIVIDUAL UTILITIES BEFORE PROCEEDING WITH CONSTRUCTION.
 - ALL BERMS, DITCHES AND SIDE SLOPES OF DESIGN ROADWAY SHALL HAVE TOPSOIL AND BE SEEDED.
 - EROSION CONTROL BLANKET TO BE INSTALLED ON ALL BERMS, DITCHES AND SIDE SLOPES OF DESIGN ROADWAY.

150mm W.M.	WATERMAIN		HYDRO POLE		PROPOSED SITE GRADING
○	HYDRANT		GRAVEL		PROPOSED RIGHT DITCH
○	VALVE		ASPHALT		PROPOSED LEFT DITCH
○	LAND DRAINAGE SEWER		PROPERTY LINE		
○	WASTEWATER SEWER		SURVEY BAR		
○	MANHOLE		TESTHOLE		
○	CATCH BASIN		ELEVATION (235.750)		
○	CATCH PIT		TREE		
○	JUNCTIONS		BUSH LINE		
○	CULVERT		DITCH		
○	GAS		FENCE		
○	BELL M.T.S.				
○	HYDRO				
○	EXISTING	LEGEND - PLAN	PROPOSED	EXISTING	LEGEND - PROFILE
○	PROPOSED	EXISTING	LEGEND - PLAN	PROPOSED	EXISTING

NO.	REVISIONS	DATE	DESIGN	CHECK
0	ISSUED FOR TENDER	2018-06-27	CS	BC
B	ISSUED FOR 90% REVIEW	2018-05-30	CS	BC
A	ISSUED FOR 30% REVIEW	2018-05-02	CS	BC

AECOM

DESIGNED BY: CS
 CHECKED BY: BC/RC
 DRAWN BY: CS
 APPROVED BY: RC

SCALE: HORIZONTAL 1:500
 VERTICAL 1:50
 DATE: 2018-06-27
 RELEASED FOR CONSTRUCTION BY: _____

CONSULTANT NO.: CT-03

APEGM
 Certificate of Authorization
 AECOM Canada Ltd.
 No. 4671 Date: JUNE 27, 2018

METRIC
 WHOLE NUMBERS INDICATE MILLIMETRES
 DECIMALIZED NUMBERS INDICATE METRES

THE CITY OF WINNIPEG
 WATER AND WASTE DEPARTMENT

NEWPPC UPGRADE SITE PREPARATION WORKS
 PARCEL B ROAD AND ASSOCIATED WORKS
PARCEL B ROAD
 STATION 1+250 TO STATION 1+481

CITY DRAWING NUMBER: 1-0101-CRSW-Y003
 SHEET: 001
 REV: 0
 SIZE: A1

