



## **NOTES:**

- 1. STATION IN CENTRE OF McGREGOR RIGHT-OF-WAY UNLESS OTHERWISE NOTED. BASELINE IS CENTRELINE OF McGREGOR RIGHT-OF-WAY.
- 3. NORTH PROPERTY LINE OF SELKIRK AVENUE IS STA 1+00.0
- 4. ALL MEASUREMENTS TO BACK OF CURB.
- 5. ALL EXISTING TREES TO BE PROTECTED AND MAINTAINED THROUGHOUT CONSTRUCTION.
- 6. ALL BUS STOPS WITHIN LIMITS OF CONSTRUCTION TO BE TEMPORARILY
- RELOCATED BY OTHERS DURING WORKS. 7. HAND OR SOFT DIG METHODS REQUIRED OVER ALL UTILITIES AT INTERVALS
- DETERMINED BY THE ENGINEER TO DETERMINE DEPTH OF COVER. 8. NO WORKS, INCLUDING CONCRETE CUTTING OR BREAKING, TO BE UNDERTAKEN
- NEAR GAS LINES UNTIL DEPTH OF COVER IS DETERMINED AND A MB HYDRO SAFETY WATCH IS ON SITE. 9. ANY GAS MAINS OR SERVICES EXPOSED IN THE EXCAVATION AREA TO BE ROCK
- WRAPPED IN ACCORDANCE WITH MB HYDRO STANDARDS PRIOR TO WORK PROCEEDING ON SITE.
- 10. NO VIBRATORY COMPACTION PERMITTED WITHIN 1M OF GAS MAINS.
- 11. INSTALL MODIFIED BARRIER CURB AT ALL INTERSECTION RADII, ALLEY RADII, AND BULLNOSES. 12. CONSTRUCT NEW MONOLITHIC CURB RAMP (10mm HEIGHT INTEGRAL)
- 13. REMOVE EXISTING SD-024 CATCHBASIN AND INSTALL NEW BARRIER CURB AND
- GUTTER INLET FRAME (AP-008) AND AND INLET COVER (AP-008) AND 250 LEAD @ 2% MINIMUM GRADE.
- 14. TRANSVERSE JOINTS SPACED AT 5.0 INTERVALS UNLESS OTHERWISE NOTED.
- 15. ADJUST ALL WATER VALVES, MANHOLES AND CATCH BASINS TO GRADE. 16. INSTALL DETECTABLE WARNING SURFACE TILE (SD-229AB) IN ALL CORNERS OF
- STREET INTERSECTIONS. 17. INSTALL 6.0-150¢ SUBDRAIN (SD-245) BOTH SIDES OF ALL PROPOSED
- CATCHBASINS.
- 18. REMOVE EXISTING SIGN
- 19. INSTALL MOUNTING SLEEVE AT LOCATIONS INDICATED
- 20. REMOVE EXISTING CATCHBASIN AND ABANDON LEAD

SCALE: 1:10m (A1)

- 21. APPROACH GRADES SHOWN REPRESENT AVERAGE SLOPES. CROSSFALL ACROSS
- SIDEWALK TRAVEL PATH TO BE 5% OR LESS. 22. INSULATE ALL WATERMAINS AND SERVICES UNDER NEW PAVEMENT IN ACCORDANCE WITH SD-018.

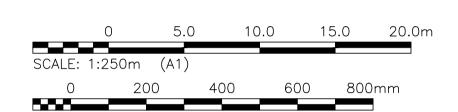

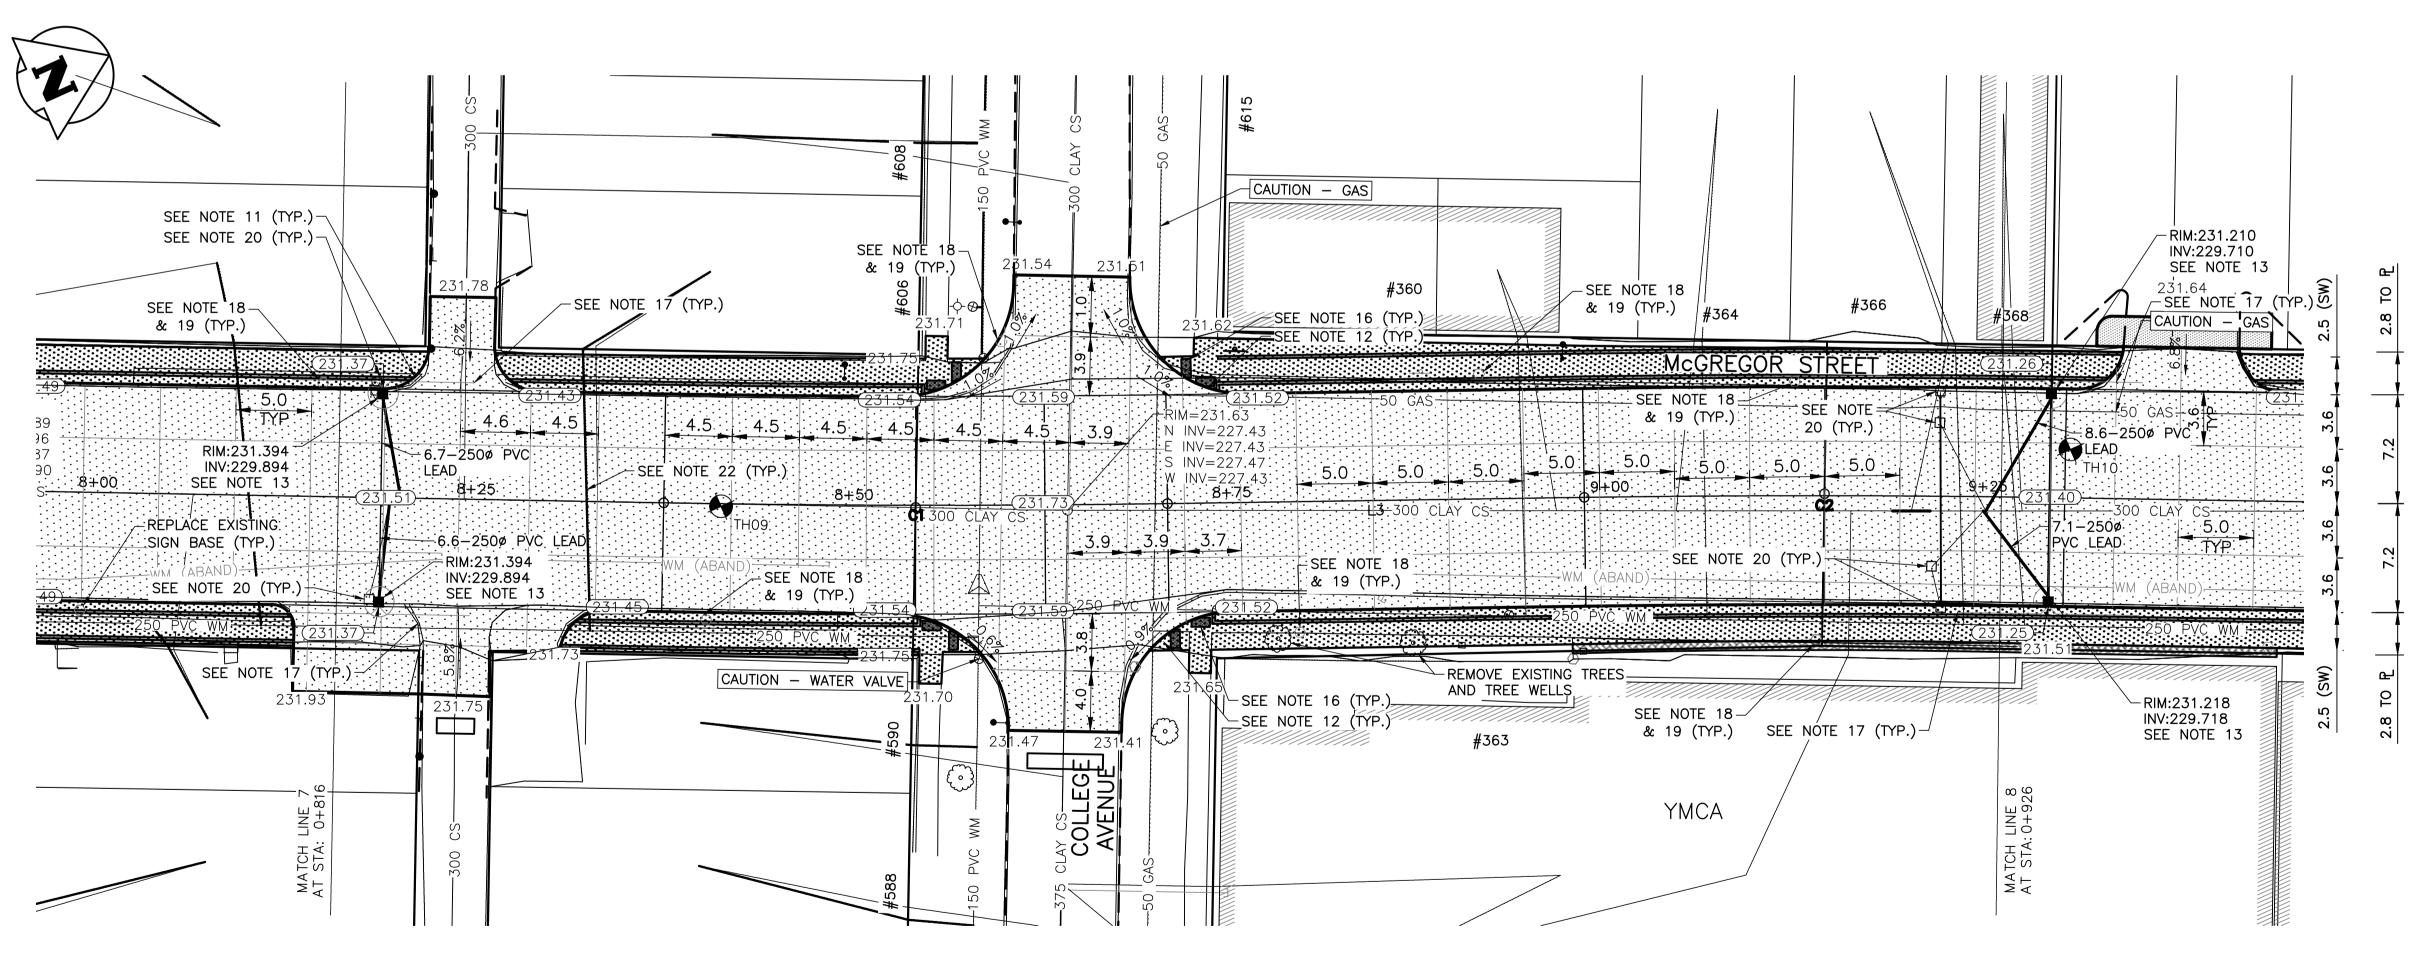

LOCATIONS OF UNDERGROUND STRUCTURES AS SHOWN ARE BASED ON THE BEST INFORMATION AVAILABLE. BUT NO GUARANTEE IS GIVEN THAT ALL EXISTING UTILITIES ARE SHOWN OR THAT THE GIVEN LOCATIONS ARE EXACT. CONFIRMATION OF THE EXISTENCE AND EXACT LOCATION OF ALL SERVICES MUST BE OBTAINED FROM INDIVIDUAL UTILITIES BEFORE PROCEEDING WITH CONSTRUCTION.

## PROPERTY LIMITS DELINEATION

DELINEATION OF PROPERTY LIMITS AS SHOWN ON THIS DWG DOES NOT REPRESENT A "LEGAL SURVEY". KGS GROUP MAKES NO REPRESENTATION OR WARRANTY AS TO THE ACCURACY OF PROPERTY LIMITS DELINEATED ON THIS DWG, NOR ON THE DIMENSIONAL ACCURACY OF DWG FEATURES RELATIVE TO THOSE PROPERTY LIMITS.

## WARNING

NOTIFY THE GAS COMPANY OF THE PROPOSED LOCATION OF EXCAVATION.

TAKE PRECAUTION TO AVOID DAMAGE TO GAS COMPANY INSTALLATIONS.

SEE PROVINCIAL REGULATION 210/72 FOR DETAILS.

## **METRIC**

WHOLE NUMBERS INDICATE MILLIMETRES DECIMALIZED NUMBERS INDICATE METRES



No. 245

SHEET

OF

13

<u>©</u>	THE CITY OF WINN	IIPEG
TYY	PUBLIC WORKS DEPARTME	NT
Winnipeg	ENGINEERING DIVISION	
		OUEET

2018 REGIONAL STREET PACKAGE

COMPUTER FILE NAME McGREGOR STREET 17-0107-022\_CALL.DW0 CITY DRAWING NUMBER P-3491-09

<u>250 WWS</u>

<u> 300 lds</u> Land Drainage sewer

WASTE WATER SEWER

<u> 300 LDS</u>

<u>250 WWS</u>

LOCATION APPROVED B.M. KGS\_BASE GAS GUY WIRE UNDERGROUND STRUCTURES HYDRO LIGHT STANDARD ••• \_\_\_\_ M.T.S BACK OF CURB WATERMAIN PROFILE <u> 150 WM</u> CONCRETE **HYDRANT** WEST GUTTER **ASPHALT** EAST GUTTER  $\otimes$ VALVE  $\otimes$ SIDEWALK  $\circ$ MANHOLE PROPERTY LINE N/W LANE F CATCH BASIN S/E MEDIAN PL SURVEY BAR CURB INLET PARKING/DRIVEWAY  $\nabla$ SEODETIC BENCHMARK POLES T-MTS H-HYDRO 231.334 (32.231) 77777 WINDOW/DOOR SILL ELEVATION BEFORE PROCEEDING WITH CONSTRUCTION. LEGEND-PROFILE **EXISTING** LEGEND-PLAN PROPOSED **EXISTING** LEGEND-PLAN **EXISTING** PROPOSE

TEST HOLE

SUPV. U/G STRUCTURES COMMITTEE LOCATION OF UNDERGROUND STRUCTURES AS SHOWN ARE BASED ON THE BEST INFORMATION AVAILABLE BUT NO GUARANTEE IS GIVEN THAT ALL EXISTING UTILITIES ARE SHOWN OR THAT THE GIVEN LOCATIONS ARE EXACT.
CONFIRMATION OF EXISTENCE AND EXACT LOCATION OF ALL SERVICES MUST BE OBTAINED FROM THE INDIVIDUAL UTILITIES

DESIGNED CHECKED APPROVED DRAWN HOR. SCALE: 1:250 RELEASED FOR CONSTRUCTION: VERTICAL: 1:10 A ISSUED FOR TENDER 18/04/05 NO. REVISIONS DATE BY DATE 2018/01/08

**KGS** 

GROUP

CONSULTING ENGINEERS

COORDINATE SYSTEM: CGVD28

CONSULTANT DRAWING NO. C108

ENGINEER'S SEAL

PLAN AND PROFILE 08+10.00 TO 09+20.00