


**PARTIAL MAIN FLOOR PLAN - MECHANICAL DEMOLITION**  
3/16" = 1'-0"

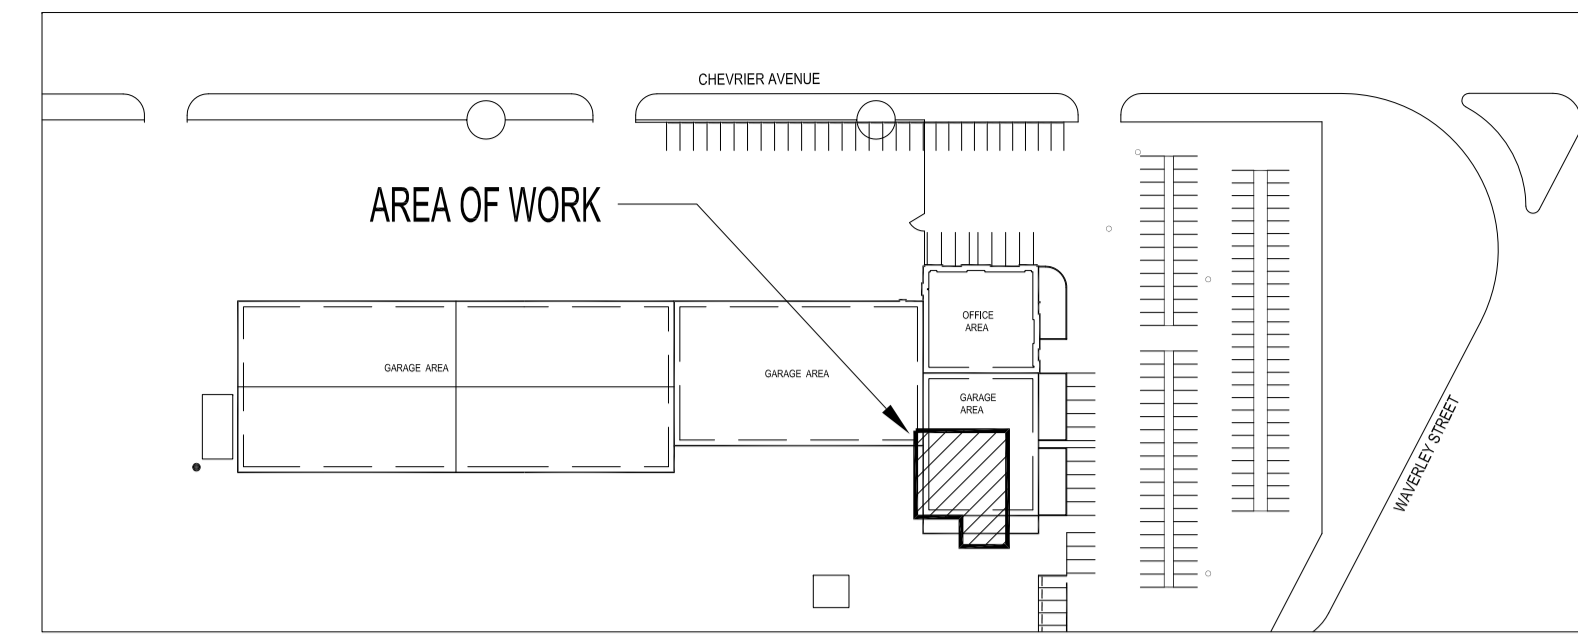

**KEY PLAN**  
SCALE: NTS

MECHANICAL LEGEND	
	EXISTING CONSTRUCTION TO REMAIN
	TO BE DEMOLISHED

**PARTIAL MAIN FLOOR PLAN - MECHANICAL DEMOLITION NOTES:**

- 1 EXISTING UNIT HEATER TO REMAIN.
- 2 EXISTING THERMOSTAT TO REMAIN.
- 3 EXISTING SEDIMENT PIT TO REMAIN.
- 4 EXISTING UNDER SLAB SANITARY LINE TO REMAIN.
- 5 EXISTING COMPRESSED AIR PIPING TO REMAIN.
- 6 EXISTING DOMESTIC HOT/COLD WATER LINE TO REMAIN.
- 7 EXISTING COMPRESSED AIR BRANCH TO REMAIN.
- 8 EXISTING FLOOR DRAIN TO REMAIN.
- 9 REMOVE EXISTING DUCTWORK.
- 10 CAP OFF DUCT OPENING WITH SHEET METAL.
- 11 REMOVE EXISTING NATURAL GAS PIPING.
- 12 CAP OFF NATURAL GAS PIPING OPENING AT THIS LOCATION.
- 13 REMOVE EXISTING COMPRESSED AIR BRANCH AND CAP OFF COMPRESSED AIR PIPE OPENING BACK TO MAIN AT HIGH LEVEL.
- 14 REMOVE EXISTING HOT/COLD WATER PIPE INSULATION.
- 15 REMOVE EXISTING SPRINKLER HEADS AND ASSOCIATED PIPING. CAP OFF SPRINKLER PIPING BACK TO MAIN AT HIGH LEVEL.
- 16 REMOVE EXISTING SINK. CAP OFF EXISTING DOMESTIC HOT/COLD WATER LINE AND VENT BACK TO MAIN AT HIGH LEVEL. CAP OFF THE SINK DRAIN AT FLOOR LEVEL.
- 17 REMOVE EXISTING HOT WATER TANK. CLEAN AND RETURN TO OWNER FOR FUTURE RE-INSTALLATION.
- 18 REMOVE EXISTING MAKE UP AIR UNIT.
- 19 REMOVE EXISTING EXHAUST FAN.

**NOTES:**

THESE DRAWINGS SHALL NOT BE SCALED.  
 THIS DRAWING IS DIAGRAMMATIC ONLY. CONTRACTOR TO COORDINATE EXACT LOCATIONS OF AND ROUTING ON SITE WITH ALL NEW AND EXISTING SYSTEM.  
 THE CONTRACTOR SHALL VISIT THE SITE AND SATISFY HIMSELF ALL DIMENSIONS, DATUM, AND DETAILED INFORMATION SHOWN ARE CORRECT.  
 THE CONTRACTOR IS TO REVIEW AND COORDINATE ALL ARCHITECTURAL, MECHANICAL, ELECTRICAL AND STRUCTURAL DRAWINGS FOR ADDITIONAL OPENINGS THROUGH FLOORS, WALLS, AND CEILINGS FOR DUCT, PIPE & ELECTRICAL RISERS AND ALL OPENINGS NOT SHOWN ON DRAWINGS.  
 ALL OPENINGS THROUGH FIRE ASSEMBLIES ARE TO BE FIRE STOPPED AND SEALED WITH ULC APPROVED FIRE STOPPING TO MAINTAIN THE INTEGRITY OF THE FIRE SEPARATION, AND PROVIDE A SMOKE-TIGHT BARRIER.  
 ALL PRODUCTS AND MATERIALS TO BE USED AND INSTALLED SHALL CONFORM WITH MANUFACTURER'S SPECIFICATIONS & APPLICABLE CODES.  
 NEW DUCT SHALL BE CONSTRUCTED AS RECOMMENDED BY SMACNA.  
 PLUMBING INSTALLATION SHALL CONFORM TO NATIONAL PLUMBING CODE OF CANADA.  
 ELECTRICAL WIRING SHALL BE PERFORMED BY A QUALIFIED ELECTRICAL SUBTRADE.  
 THE CONTRACTOR SHALL BE RESPONSIBLE TO PATCH AND MAKE GOOD ALL EXISTING CONSTRUCTION AFFECTED BY THE REMOVAL OF ALL ITEMS FORMING THE PART OF THE RENOVATION WORK.  
 THE CONTRACTOR IS RESPONSIBLE FOR INSTALLING RISERS, SWING JOINTS AND DEEP CUP ESCUTCHEONS AS REQUIRED.  
 MECHANICAL SYSTEM DEMOLITION SHALL BE PERFORMED BY QUALIFIED MECHANICAL SUB-CONTRACTOR.  
 ALL MECHANICAL EQUIPMENT, PIPING AND DUCTWORK, WHICH IS NOT INDICATED IN THE DEMOLITION PLAN, SHALL REMAIN.

No.	REVISION/DESCRIPTION	BY	DATE

DRAWN	CHECKED	DESIGNED	APPROVED
EAG			
DATE: 2018.10.30	USER APPROVAL		

**Winnipeg** THE CITY OF WINNIPEG  
 PLANNING, PROPERTY AND  
 DEVELOPMENT DEPARTMENT  
 MUNICIPAL ACCOMMODATIONS DIVISION  
 3-65 GARRY STREET, R3C 4K4

**PROJECT**  
 PUBLIC WORKS SOUTH YARD  
 INTERIOR RENOVATIONS

1539 WAVERLEY STREET

**SHEET TITLE**  
 PARTIAL FLOOR PLAN  
 MECHANICAL SYSTEM  
 DEMOLITION

SCALE	PROJECT No:	SHEET No:
AS SHOWN	2018-018	M2