

NOTE: NOT ALL SYMBOLS SHOWN ON THIS LEGEND ARE NECESSARILY USED ON THIS PROJECT. ELECTRICAL SYMBOL LEGEND ARE NECESSARILY USED ON THIS PROJECT.						ELECTRICAL DI	RAWII	NG	<u>LIST</u>
	LIGHTING		FIRE ALARM SYSTEM	E.	1.0	ELECTRICAL SYMBOL LEGEND &	DRAWING L	.IST	
	LINEAR FLUORESCENT LUMINAIRE, TYPE 'A' AS SPECIFIED. HATCHING DENOTES CONNECTED TO EMERGENCY/NIGHT LIGHTING CIRCUIT		PULL STATION	E.	1.1	SITE PLAN — ELECTRICAL RENO	VATION LAY	OUT	
AO	CEILING MOUNTED LUMINAIRE, TYPE 'A' AS SPECIFIED) HS	HORN STROBE	E	D2.0	BASEMENT - ELECTRICAL DEMO	LITION LAY	DUT	
AQ	WALL MOUNTED LUMINAIRE, TYPE 'A' AS SPECIFIED	 	AUTOMATIC COMBINATION FIXED TEMPERATURE/RATE OF RISE HEAT DETECTOR — CEILING MOUNTED	E	D2.1	MAIN FLOOR — ELECTRICAL DEN	OLITION LA	YOUT	
	DOUBLE SURFACE MOUNTED EMERGENCY LIGHTING REMOTE HEADS, TYPE 'BU-1'	•	CO DETECTOR C/W SOUNDER BASE	E	EL2.0 BASEMENT — ELECTRICAL LIGHTING RENOVATION LAYOUT				
	INDICATES BATTERY BANK FED FROM EMERGENCY LIGHTING BATTERY UNIT C/W DUPLEX RECEPTACLE AND DOUBLE REMOTE	 	SMOKE DETECTOR — CEILING MOUNTED	E	L2.1	MAIN FLOOR — ELECTRICAL LIGHTING RENOVATION LAYOUT			
. B U-1	HEADS. TYPE 'BU-1' AS SPECIFIED.		GENERAL POWER	E	P2.0	BASEMENT - ELECTRICAL POWE	R & SYSTE	MS REN	OVATION LAYOUT
<i>BU−1</i>	WALL MOUNTED DOUBLE FACED EXIT LIGHT AND DIRECTIONAL ARROWS AS INDICATED. SHADED AREAS DENOTE DIRECTION OF FACE OF EXIT SIGN. 'BU-1' INDICATES BATTERY UNIT FED FROM.	Ф	15A, U-GROUND DUPLEX RECEPTACLE	E	P2.1	MAIN FLOOR - ELECTRICAL POV	/ER & SYS	TEMS RI	ENOVATION LAYOUT
⊗	WALL MOUNTED SINGLE FACED EXIT LIGHT AND DIRECTIONAL ARROWS AS INDICATED.	Ф	20A, U-GROUND DUPLEX RECEPTACLE	E.	5.0	PANELBOARD SCHEDULES			
⊗	SHADED AREAS DENOTE DIRECTION OF FACE OF EXIT SIGN. CEILING MOUNTED SINGLE FACED EXIT LIGHT AND DIRECTIONAL ARROWS AS INDICATED. SHADED AREAS DENOTE DIRECTION OF FACE OF EXIT SIGN.	#	15A, U-GROUND DUPLEX RECEPTACLE C/W GROUND FAULT CIRCUIT INTERRUPTER - MOUNTED ABOVE COUNTER	A55		BREVIATIONS			
60	COMBINATION CEILING MOUNTED SINGLE FACED EXIT LIGHT, DIRECTIONAL ARROWS & DOUBLE REMOTE HEAD AS INDICATED. SHADED AREAS DENOTE DIRECTION OF FACE OF EXIT SIGN.	Ö	(5-20R) T-SLOT U-GROUND DUPLEX RECEPTACLE C/W GROUND FAULT CIRCUIT INTERRUPTER	AFF AFG BB	- - -	ABOVE FINISHED FLOOR ABOVE FINISHED GRADE BASEBOARD HEATER	MIC MV MW	- - -	MICROWAVE EXISTING TO BE MOVED MOUNTED IN MILLWORK
	EQUIPMENT CONNECTIONS AND CONTROLS	Ш	15A, U-GROUND DUPLEX RECEPTACLE - FLUSH FLOOR MOUNTED UNLESS NOTED OTHERWISE	BU CH CP	_	BATTERY UNIT CHILDPROOF COPY MACHINE	NIC NL		NOT IN CONTRACT NIGHT LIGHT
0	DIRECT CONNECTION - 120 OR 208V AS SPECIFIED		MISCELLANEOUS	CSTE	_	CUSTOMER SERVICE TERMINATION ENCLOSURE	NTS PA		NOT TO SCALE PUBLIC ADDRESS
ģ¤.	MOTOR CONNECTION C/W UNFUSED DISCONNECT SWITCH	\bigoplus_{E}	INDICATES EXISTING DEVICE TO REMAIN	D E	- -	DELETE EXISTING	PR QP	<u>-</u>	QUAD PLEX
•	POWER ACTIVATED DOOR EXIT BUTTON SUPPLIED BY DOOR HARDWARE SUPPLIER, WRED BY ELECTRICAL	₹7 _{w∧}	INDICATES EXISTING DEVICE TO BE MOVED	FA FC	- -	FAN COIL (WHEN USED WITH	R TYP	_	RELOCATE(D) TYPICAL
SP	RECESSED MOUNTED ELECTRICAL PANEL — 'SP' DENOTES PANEL DESIGNATION	∰ _K	INDICATES EXISTING DEVICE IN RELOCATED POSITION	FF FR	_	MOTOR SYMBOL) FORCE FLOW FRIDGE	UC WG WP	-	UNDER COUNTER WIRE GUARD WEATHERPROOF
SP	SURFACE MOUNTED ELECTRICAL PANEL - 'SP' DENOTES PANEL DESIGNATION	1 D	INDICATES EXISTING DEVICE TO BE DEMOLISHED	FX MD	_ _ _	FAX MACHINE MAIN DISTRIBUTION	TP	_	CHILD PROOF
	LIGHTING CONTROL		- INDICATES CONDUIT	MFC	_	MULTI-FUNCTION COPIER			
\$\$\$	ONE, TWO AND THREE GANG SINGLE POLE TOGGLE SWITCHES	(TYP.)	ELECTRICAL DRAWING NOTES	USB	_	DUPLEX RECEPTACLE C/W USB CHARGING PORT			
^A	SWITCH MOUNTED OCCUPANCY SENSOR, TYPE 'A' AS SPECIFIED		COMMUNICATIONS		<u>BR</u>	ANCH CIRCUITING LEGEND			
(8)	CEILING MOUNTED OCCUPANCY SENSOR, TYPE 'A' AS SPECIFIED	A	COMBINATION VOICE/DATA OUTLET — WALL MOUNTED	2EP1-3-	— '3' — 'P1'	 DENOTES CIRCUIT NUMBER DENOTES LOCATION OF PANEL (P1 LE' DENOTES EMERGENCY PANEL 	/EL)		
A D	DIMMER SWITCH, TYPE 'A' AS SPECIFIED		TELEPHONE OUTLET - FLUSH FLOOR MOUNTED		— '2' — '6'	- DENOTES EMERGENCY PANEL - DENOTES 120/208V OR - DENOTES 347/600V			
	SECURITY AND ACCESS SYSTEMS								
MD	MOTION DETECTING	Arriv	ELECTRIC HEATING						
DC	DOOR CONTACT		RECESSED MOUNTED - ELECTRIC FORCE FLOW HEATER, TYPE 'FFH1' AS SPECIFIED						
	ROUGH IN FOR CCTV		ELECTRIC BASEBOARD HEATER, TYPE 'BB' AS SPECIFIED						

FEEDER SCHEDULE									
TYPE	DESCRIPTION	AMPACITY							
1	4 #1/0 RW90 IN 53mm C	150							
2	4 #3 RW90 IN 35mm C	100							
3	2X (4#3/0 RW90 IN 53mm C AS PER DIAGRAM D11, DETAIL 2, TABLE 2	400							
4	4#4/0 RW90 IN A 63MM C.	200							
5	3C #8 MI	50							
М	REFER TO MOTOR SCHEDULE	100							

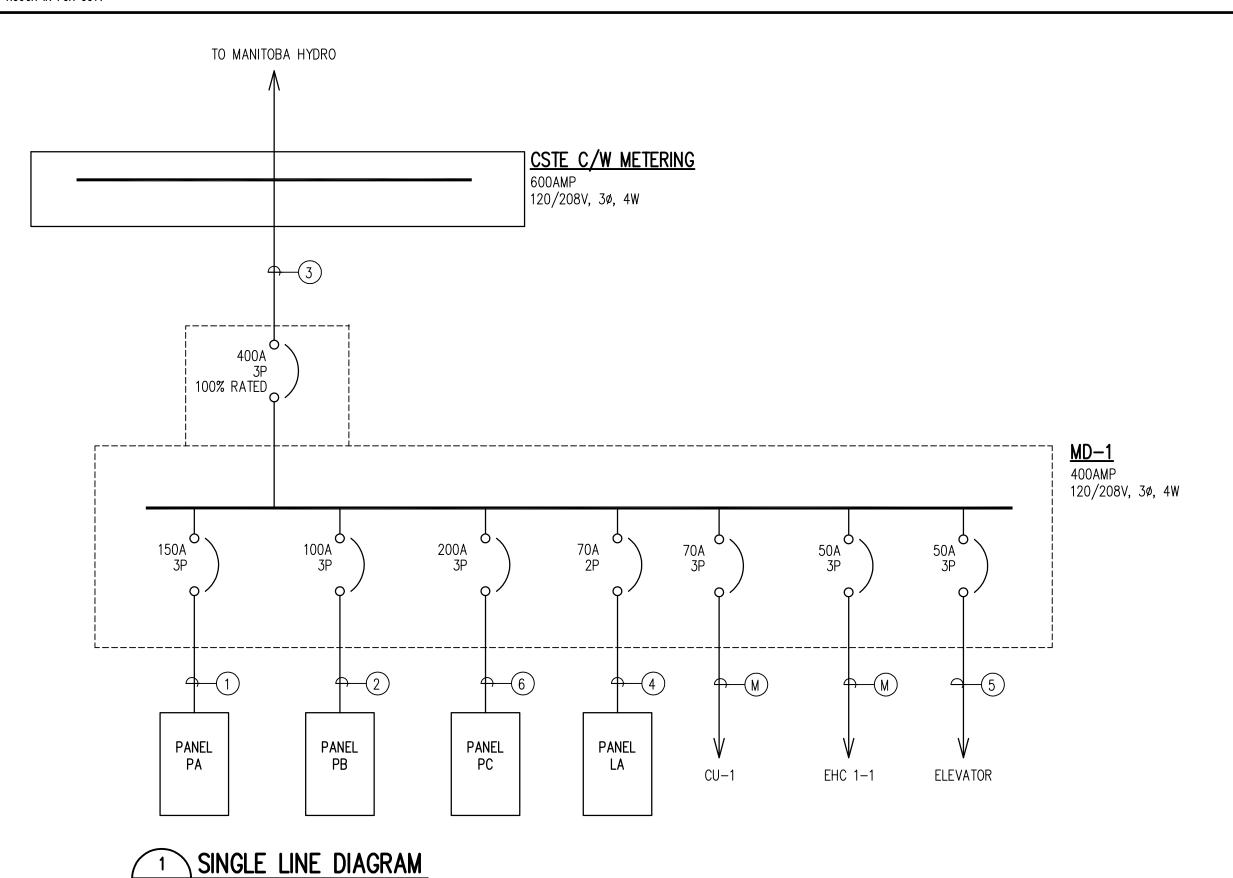

E1.0 SCALE: NTS

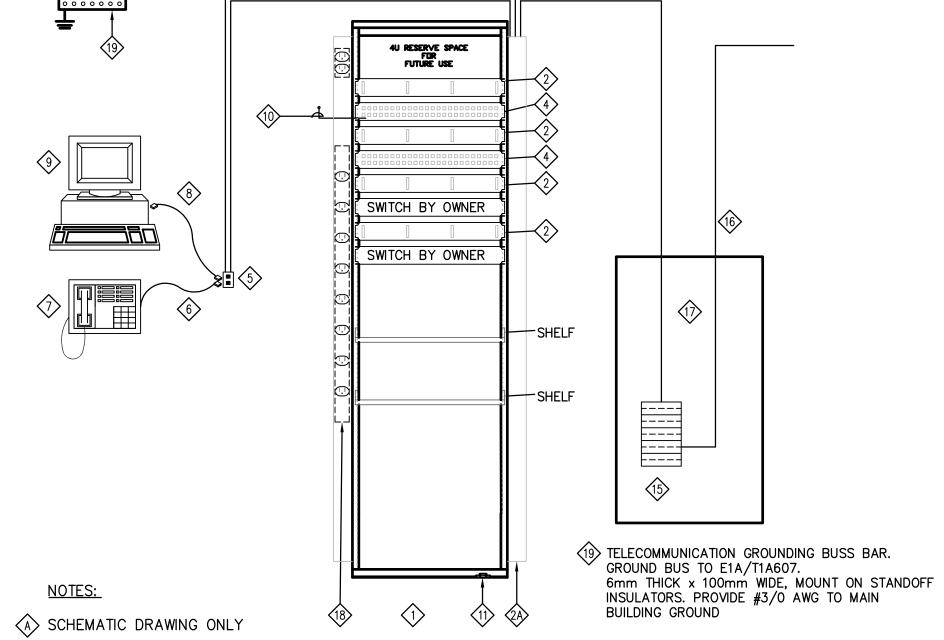

3

(12)

- B EQUIPMENT SHOWN IS TYPICAL. SEE DRAWINGS AND SPECIFICATIONS FOR DETAILS.
- © CABLING CONTRACTOR SHALL BE RESPONSIBLE FOR ALL ITEMS EXCEPT THOSE MARKED "BY OWNER" OR "EXISTING".



- 1) NEW RACK FOR WORKSTATION CABLING 2 2U HORIZONTAL WIRE MANAGEMENT GUIDE C/W HINGED FRONT COVERS
- 4" VERTICAL WIRE MANAGEMENT
- WORKSTATION HORIZONTAL CABLE
 UTP CAT 6
- HORIZONTAL CABLING PATCH PANEL
 CAT 6 48 PORT
- 5 COMMUNICATION OUTLET
- 6 LINE CORD CAT 3 PATCH CABLE (BY OWNER)
- 7> TELEPHONE (BY OWNER)
- 8 PATCH CORD CAT 6 PROVIDE 50% OF TOTAL DROPS
- 9 PC (BY OWNER) PATCH CORD - CAT 6 - PROVIDE 100% OF TOTAL DROPS
- GROUND LUG. #6 AWG GREEN GROUND WIRE TO SUITABLE GROUNDING POINT
- CABLE TO PBX OUT TIE 1 x 25 PAIR CAT 3
- 13 NOT USED
- 14 NOT USED
- (15) EXISTING TELECOMMUNICATION SUPPLIER DEMARC. DEMARC.
- 16 TELECOMMUNICATION BUILDING ENTRANCE CONDUIT EXISTING
- 17) EXISTING BACKBOARD
- PROVIDE 6'-0" WIREMOLD POWER STRIP TO LEFT HAND REAR VERTICAL -INSULATE FROM FRAME



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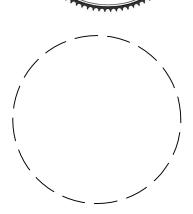
No. Date **Revision Notes** 1. 2017.05.02 Issued for Construction

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This drawing must not be scaled. The contractors shall verify all dimensions and other data on site prior to commencement of work. Discrepancies, errors, and omissions are to be reported to the Architect prior to proceeding with the Work.

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St. John's Library Renovation

SYMBOL LEGEND

Drawn By Reviewed By Drawing No. Scale Date Revision No.

2017.05.02 1503b