
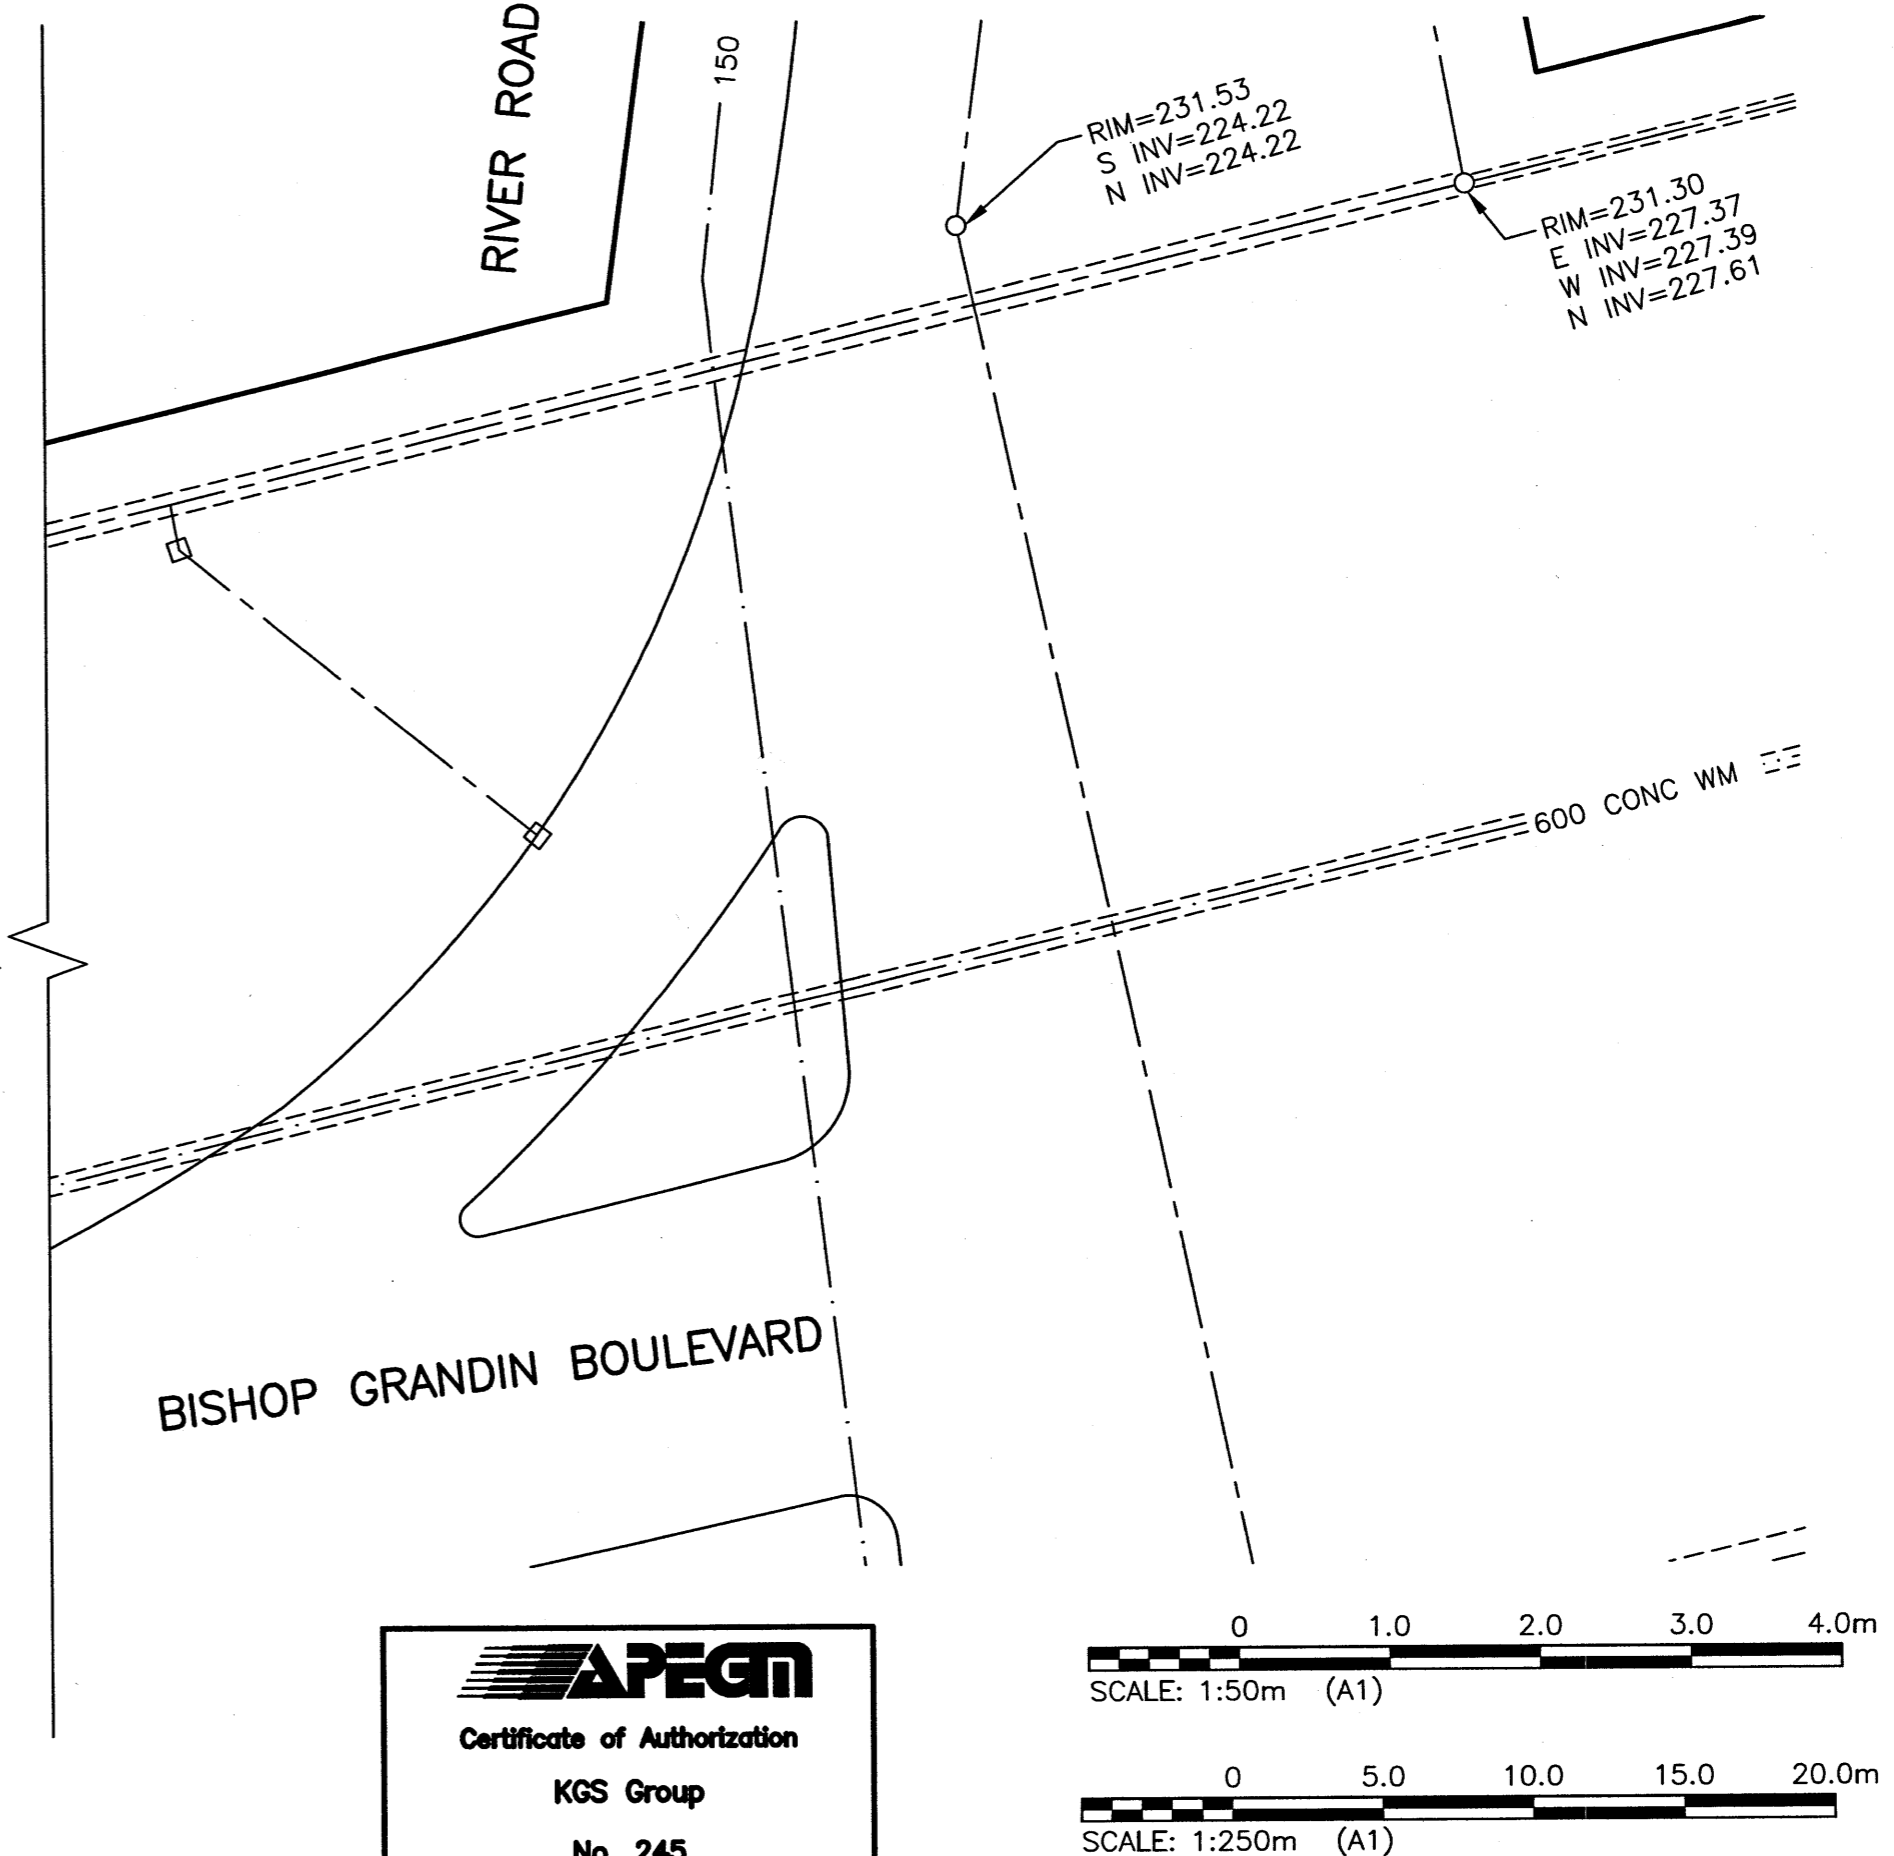
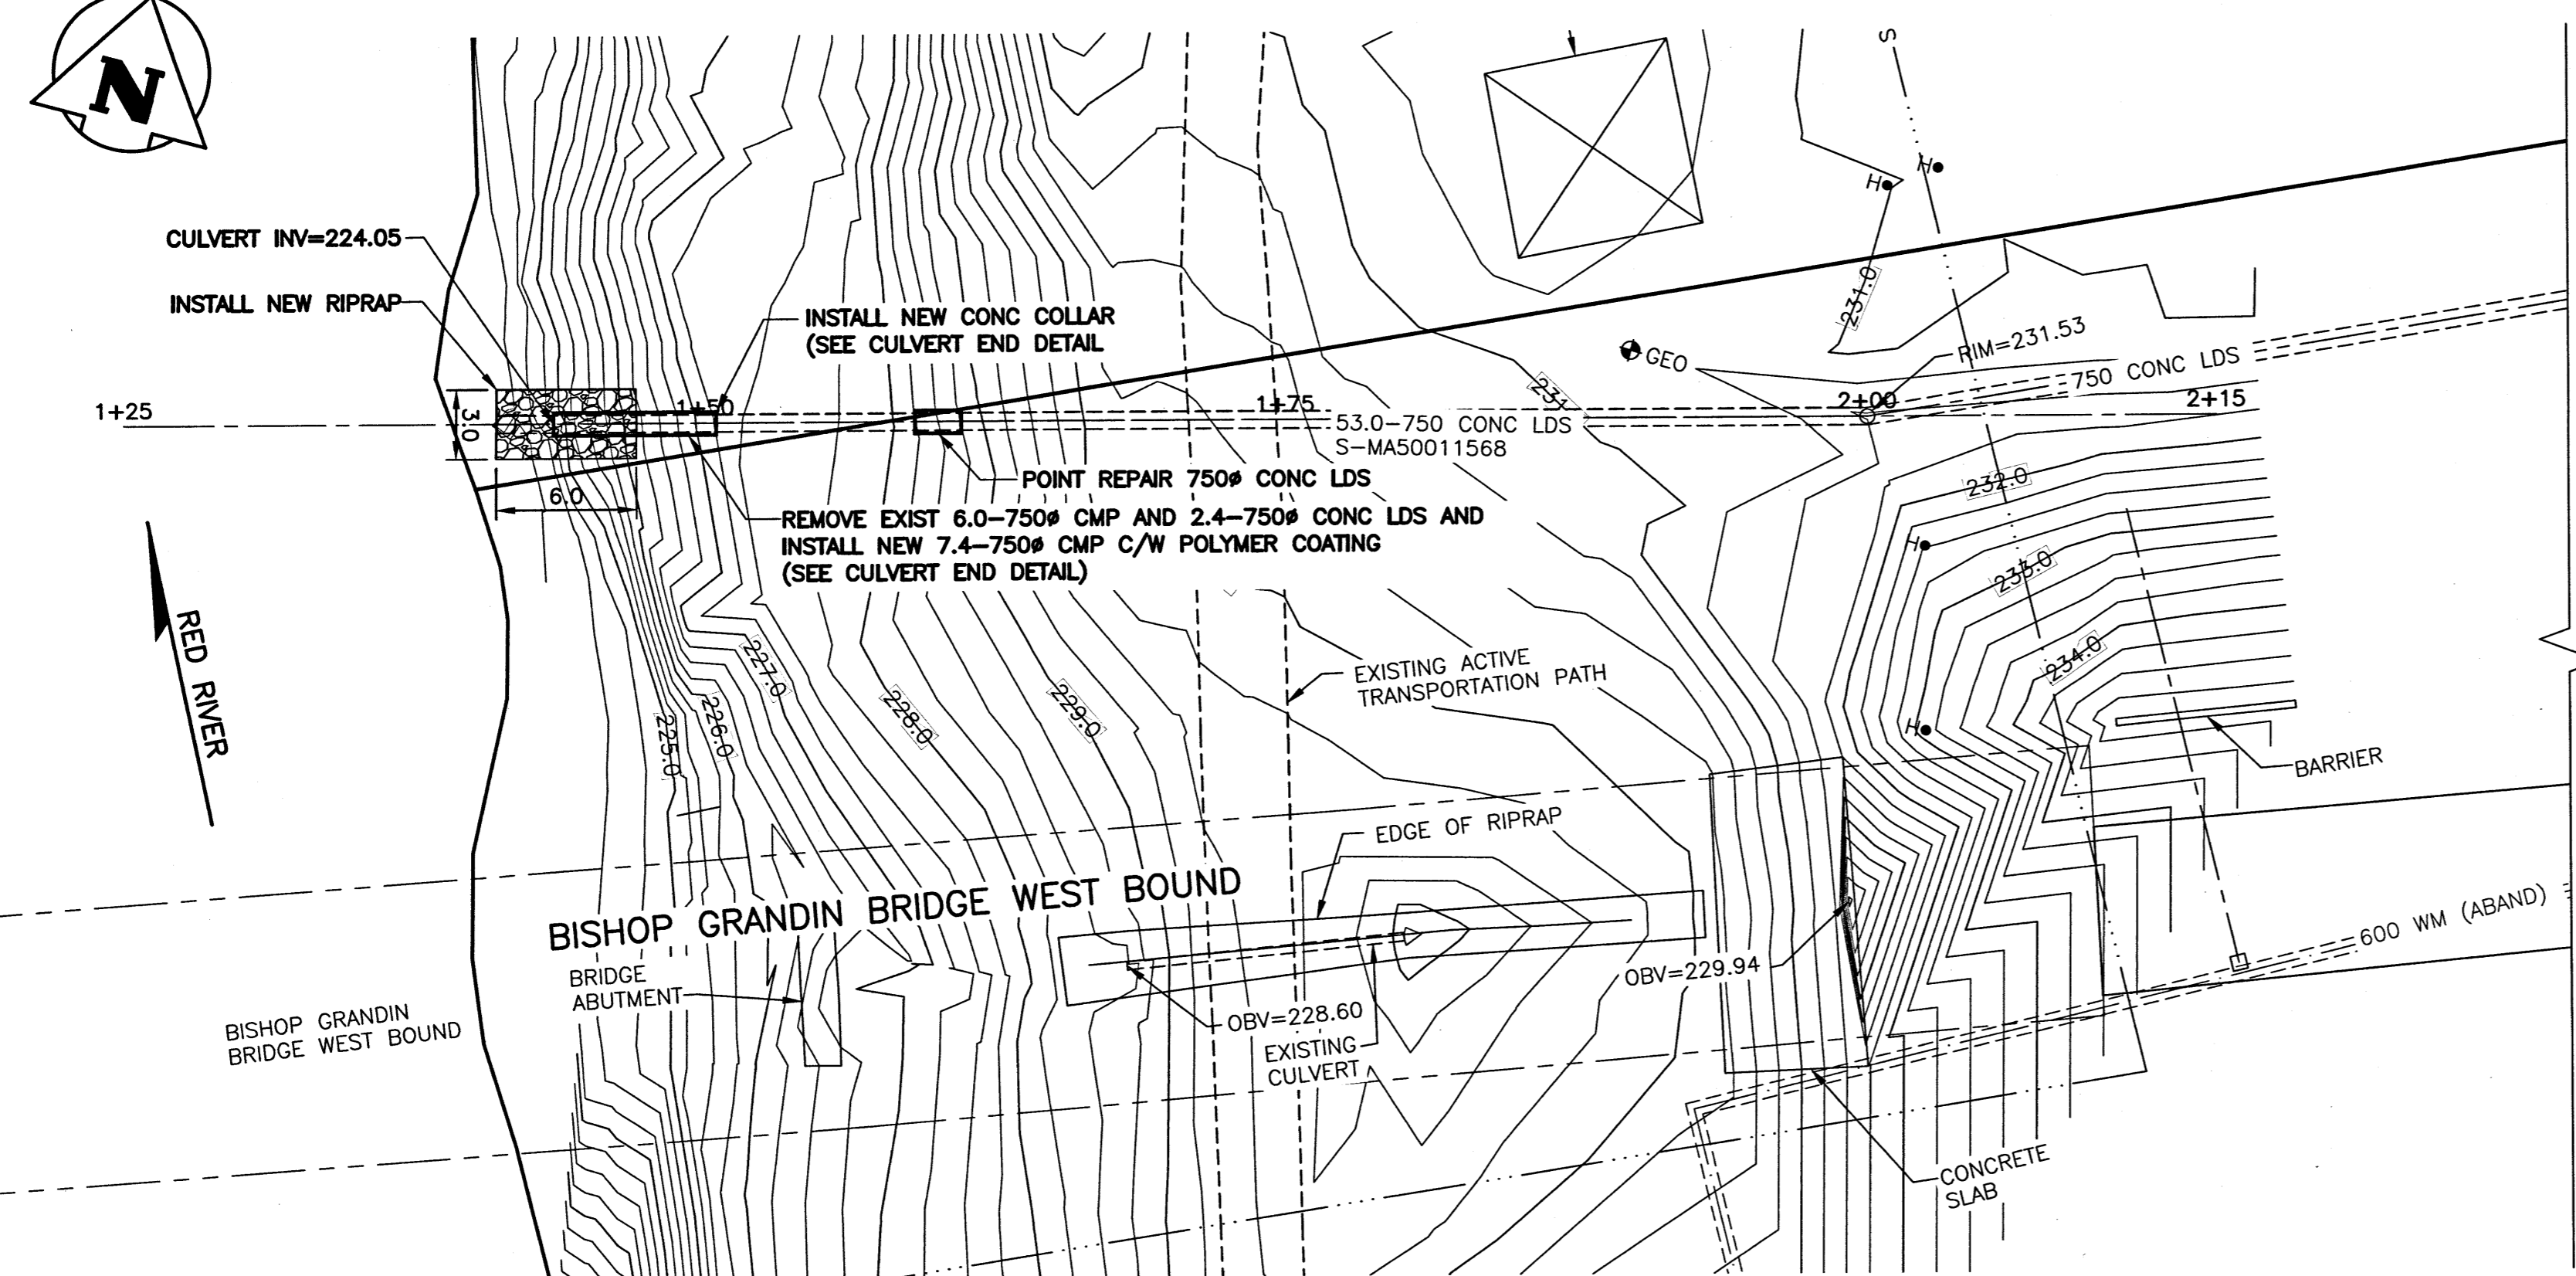
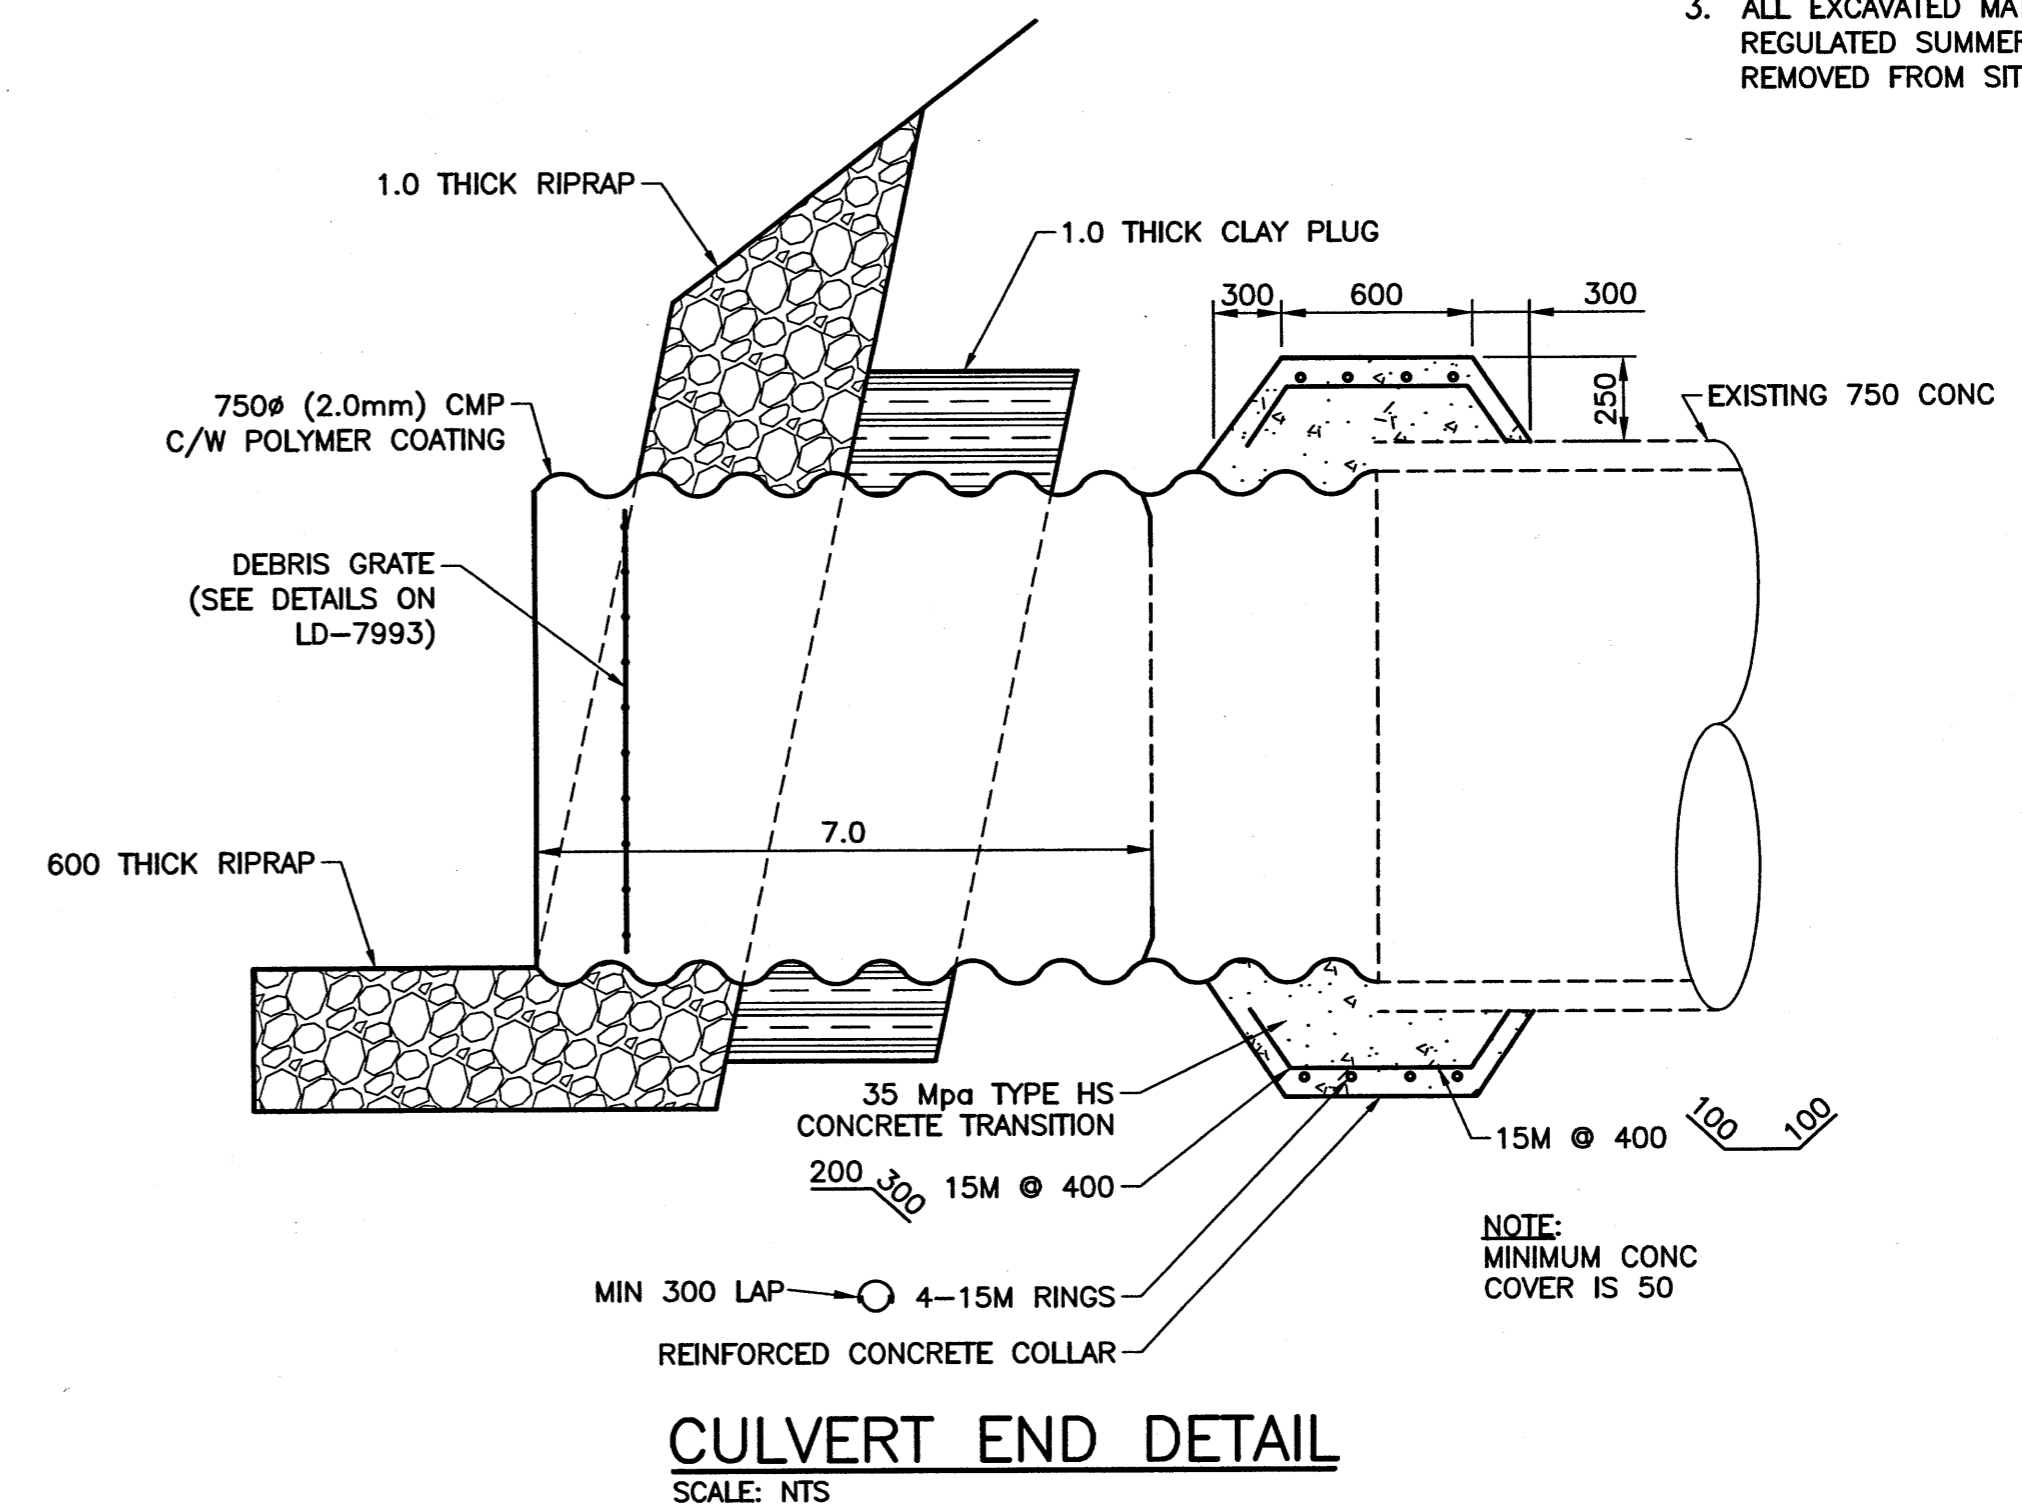


**NOTES:**

1. WINTER WATER MAIN BREAKS MAY RESULT IN OVER TOPPING WEIR AND ENTIRE OUTFALL.
2. CONTRACTOR TO PROVIDE PROPER WARNING SIGNS ALONG PEDESTRIAN PATH CONCERNING WORK SITE.
3. ALL EXCAVATED MATERIAL WITHIN 107.0 OF THE REGULATED SUMMER RIVER LEVEL (RSRL) MUST BE REMOVED FROM SITE (NO STOCKPILING).

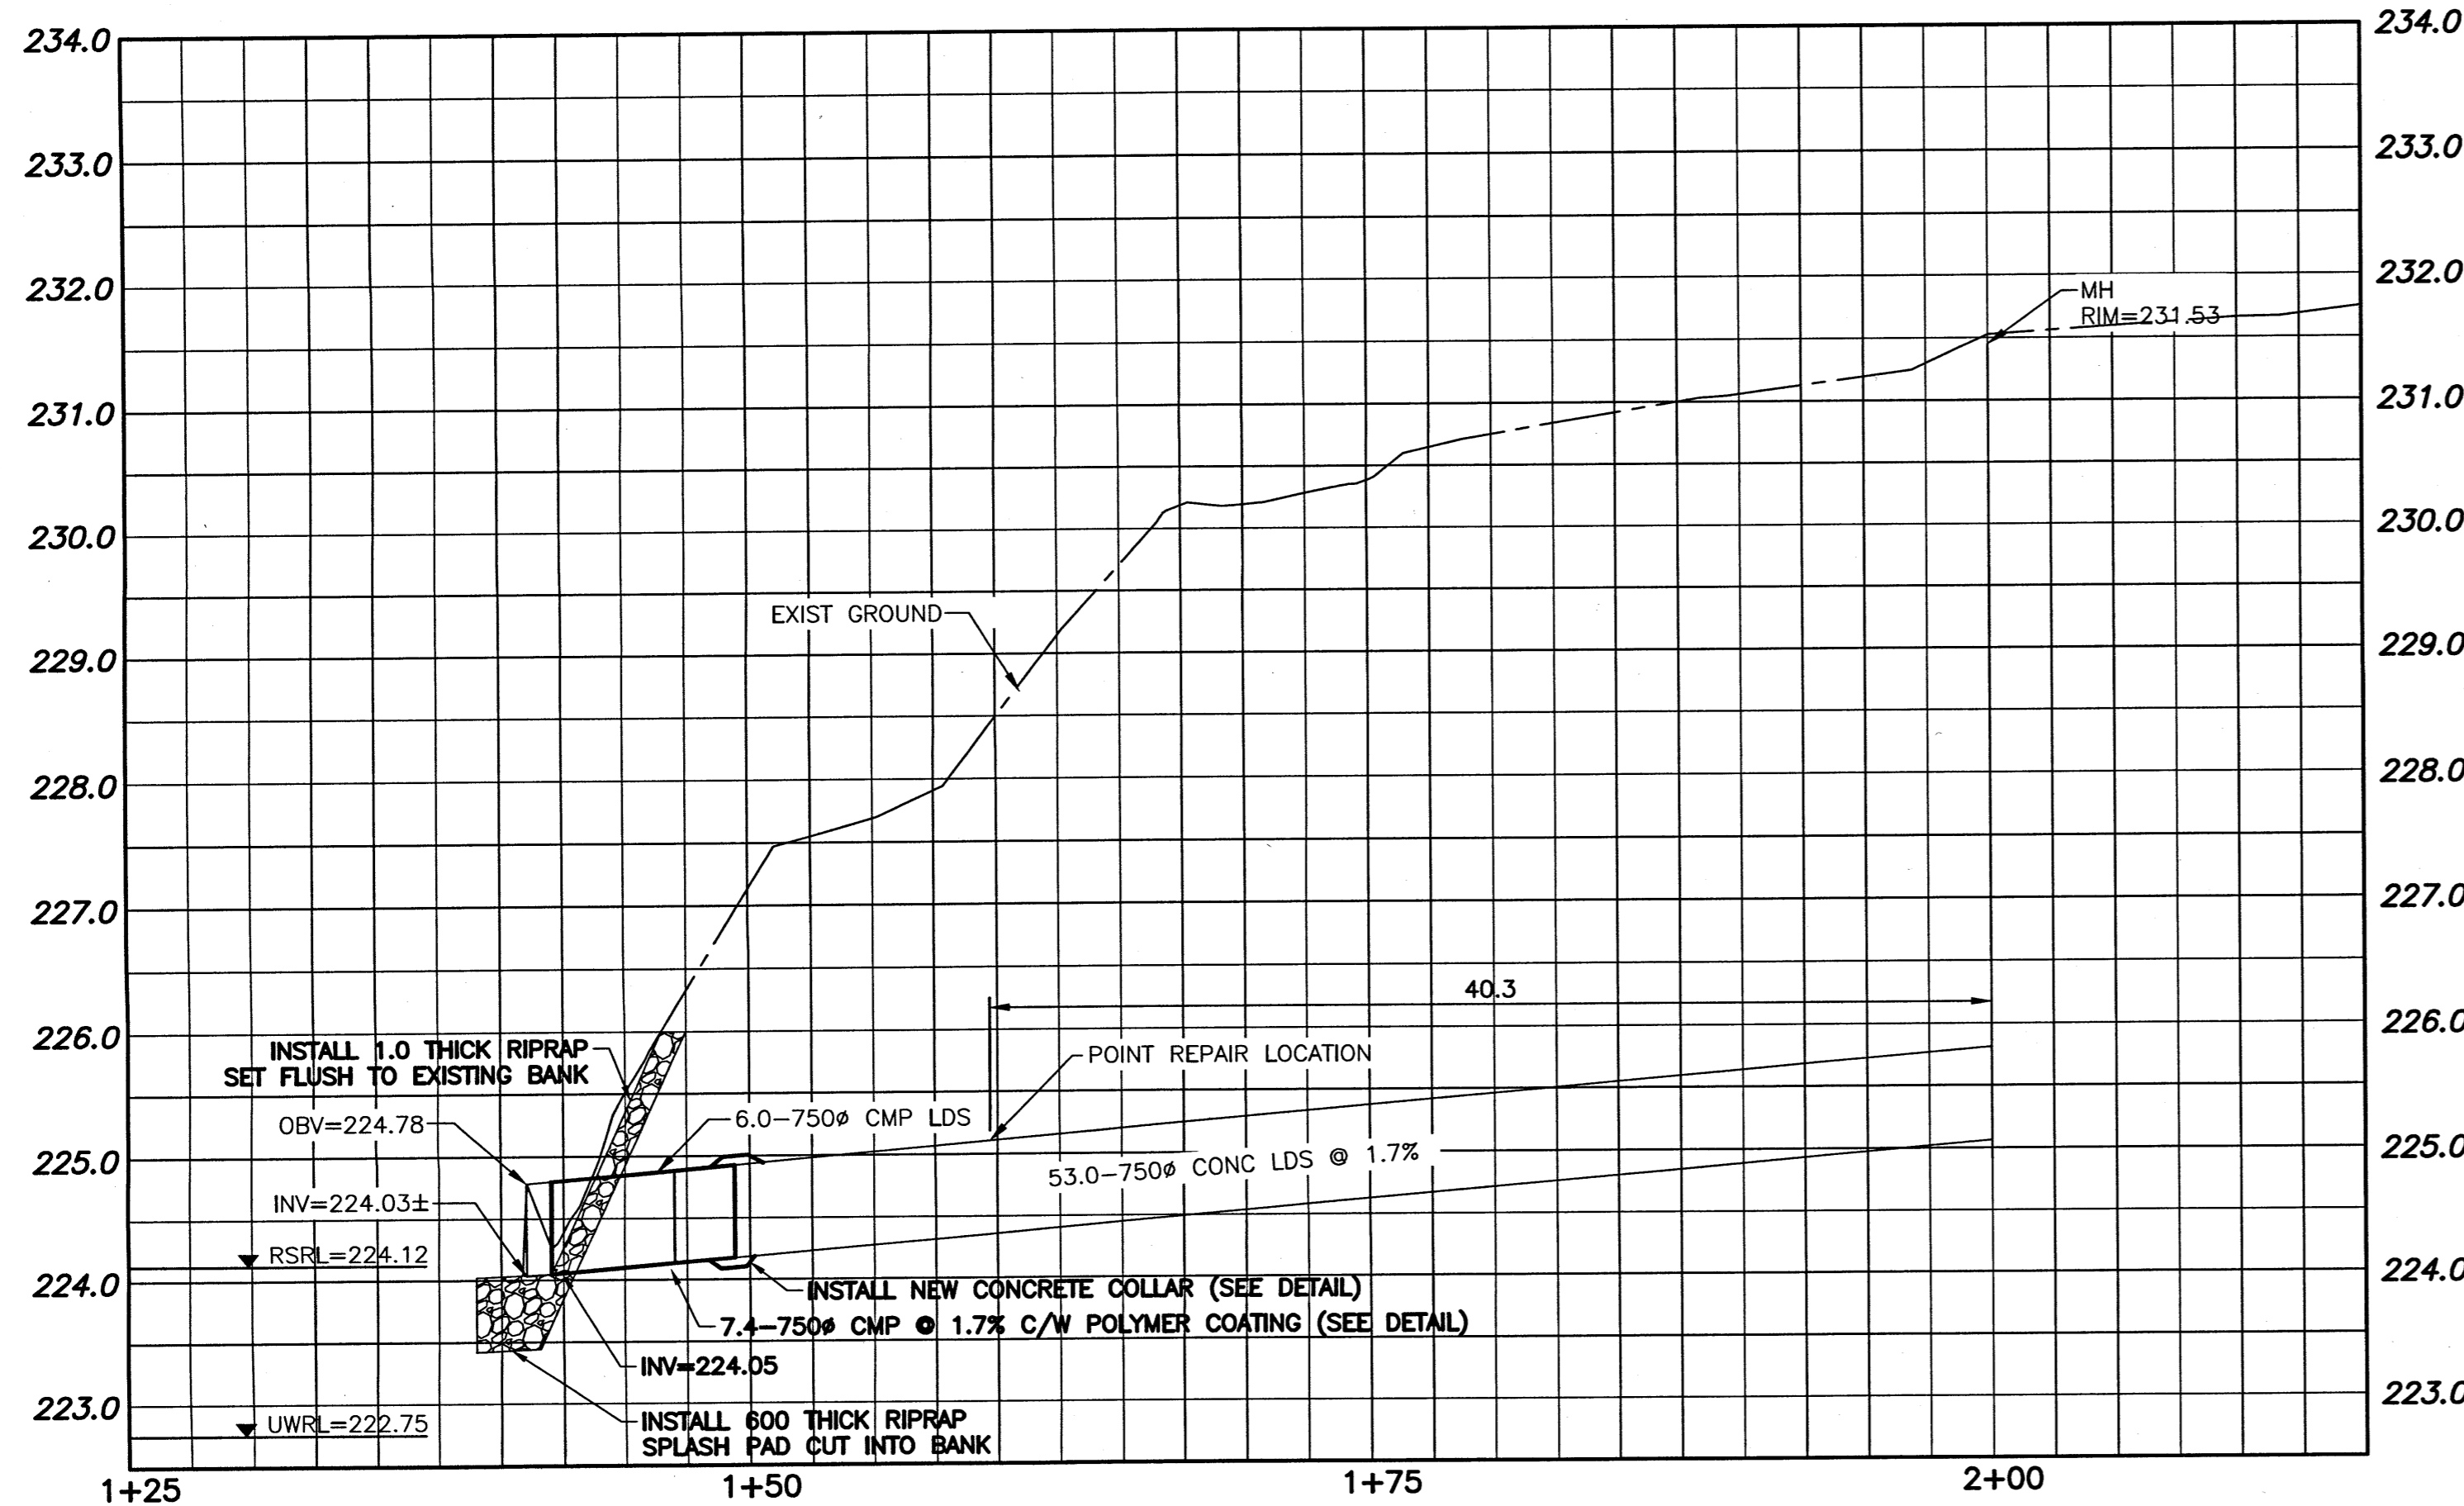

**APEGM**  
Certificate of Authorization  
KGS Group  
No. 245

**WARNING**  
1. NOTIFY THE GAS COMPANY OF THE PROPOSED LOCATION OF EXCAVATION.  
2. TAKE PRECAUTION TO AVOID DAMAGE TO GAS COMPANY INSTALLATIONS.  
3. SEE PROVINCIAL REGULATION 210/72 FOR DETAILS.

**PROPERTY LIMITS DELINEATION**  
DELINEATION OF PROPERTY LIMITS AS SHOWN ON THIS DWG DOES NOT REPRESENT A "LEGAL SURVEY". KGS GROUP MAKES NO REPRESENTATION OR WARRANTY AS TO THE ACCURACY OF PROPERTY LIMITS DELINEATED ON THIS DWG, NOR ON THE DIMENSIONAL ACCURACY OF DWG FEATURES RELATIVE TO THOSE PROPERTY LIMITS.

**METRIC**  
WHOLE NUMBERS INDICATE MILLIMETRES  
DECIMALIZED NUMBERS INDICATE METRES

File Name: U:\VMS\16-0107-021\16-0107-021\_CALL.dwg - Tab: C01 Plotted By: dweber 16/11/15 [Tue 11:02am] A1/PLOT SCALE: 1=1

150 WM	WATERMAIN	150 WM	HYDRO	LOCATION APPROVED	B.M. KGS_BASE	<b>KGS GROUP</b> CONSULTING ENGINEERS	ENGINEER'S SEAL 	THE CITY OF WINNIPEG WATER & WASTE DEPARTMENT	SHEET OF 01 OF 08
300 LDS	LAND DRAINAGE SEWER	300 LDS	M.T.S.	UNDERGROUND STRUCTURES	ELEV=249.213 NAD83 CSRS CGVD28				
250 WWS	WASTE WATER SEWER	250 WWS	PROPERTY LINE	SUPV. U/G STRUCTURES		DESIGNED BY JB	CHECKED BY RBO	2017 OUTFALL RENEWAL/ REHABILITATION PROGRAM BISHOP GRANDIN OUTFALL (RR-21) PLAN AND PROFILE S-MA50011568	CAD FILE DRAWING NUMBER 16-0107-021_CALL
○	MANHOLE	●	SURVEY BAR	DATE		DRAWN BY DMW	APPROVED BY		
▽	CATCH BASIN	■	LIGHT STANDARD	NOTE:	LOCATION OF UNDERGROUND STRUCTURES AS SHOWN ARE BASED ON THE BEST INFORMATION AVAILABLE BUT NO GUARANTEE IS GIVEN THAT ALL EXISTING UTILITIES ARE SHOWN OR THAT THE GIVEN LOCATIONS ARE EXACT. CONFIRMATION OF EXISTENCE AND EXACT LOCATION OF ALL SERVICES MUST BE OBTAINED FROM THE INDIVIDUAL UTILITIES BEFORE PROCEEDING WITH CONSTRUCTION.	HOR. SCALE: 1:250	RELEASED FOR CONSTRUCTION: ORIGINAL SIGNED BY KAS ZUREK	CITY DRAWING NUMBER LD-7986	
+	CURB INLET	○	HYDRO POLE			VERTICAL: 1:50	DATE NOV 04 2016		
+	JUNCTIONS	+	GUY WIRE	LEGEND-PLAN	EXISTING	DATE 28/09/16			
+	CULVERT	+	SIGN	PROPOSED	PROPOSED				
+	GAS	+	BUSH LINE	EXISTING	EXISTING				
+	LEGEND-PLAN	+	FENCE	LEGEND-PROFILE	PROPOSED				
+	PROPOSED	+	ELEVATION						
+	EXISTING	+	(32.231)						