



NOTES:

SEE SPECS FOR EIFS WALL SYSTEMS. WALL SYSTEM TO BE INSTALLED ACCORDING TO SPECIFICATIONS OUTLINED AND MANUFACTURERS RECOMMENDATIONS.

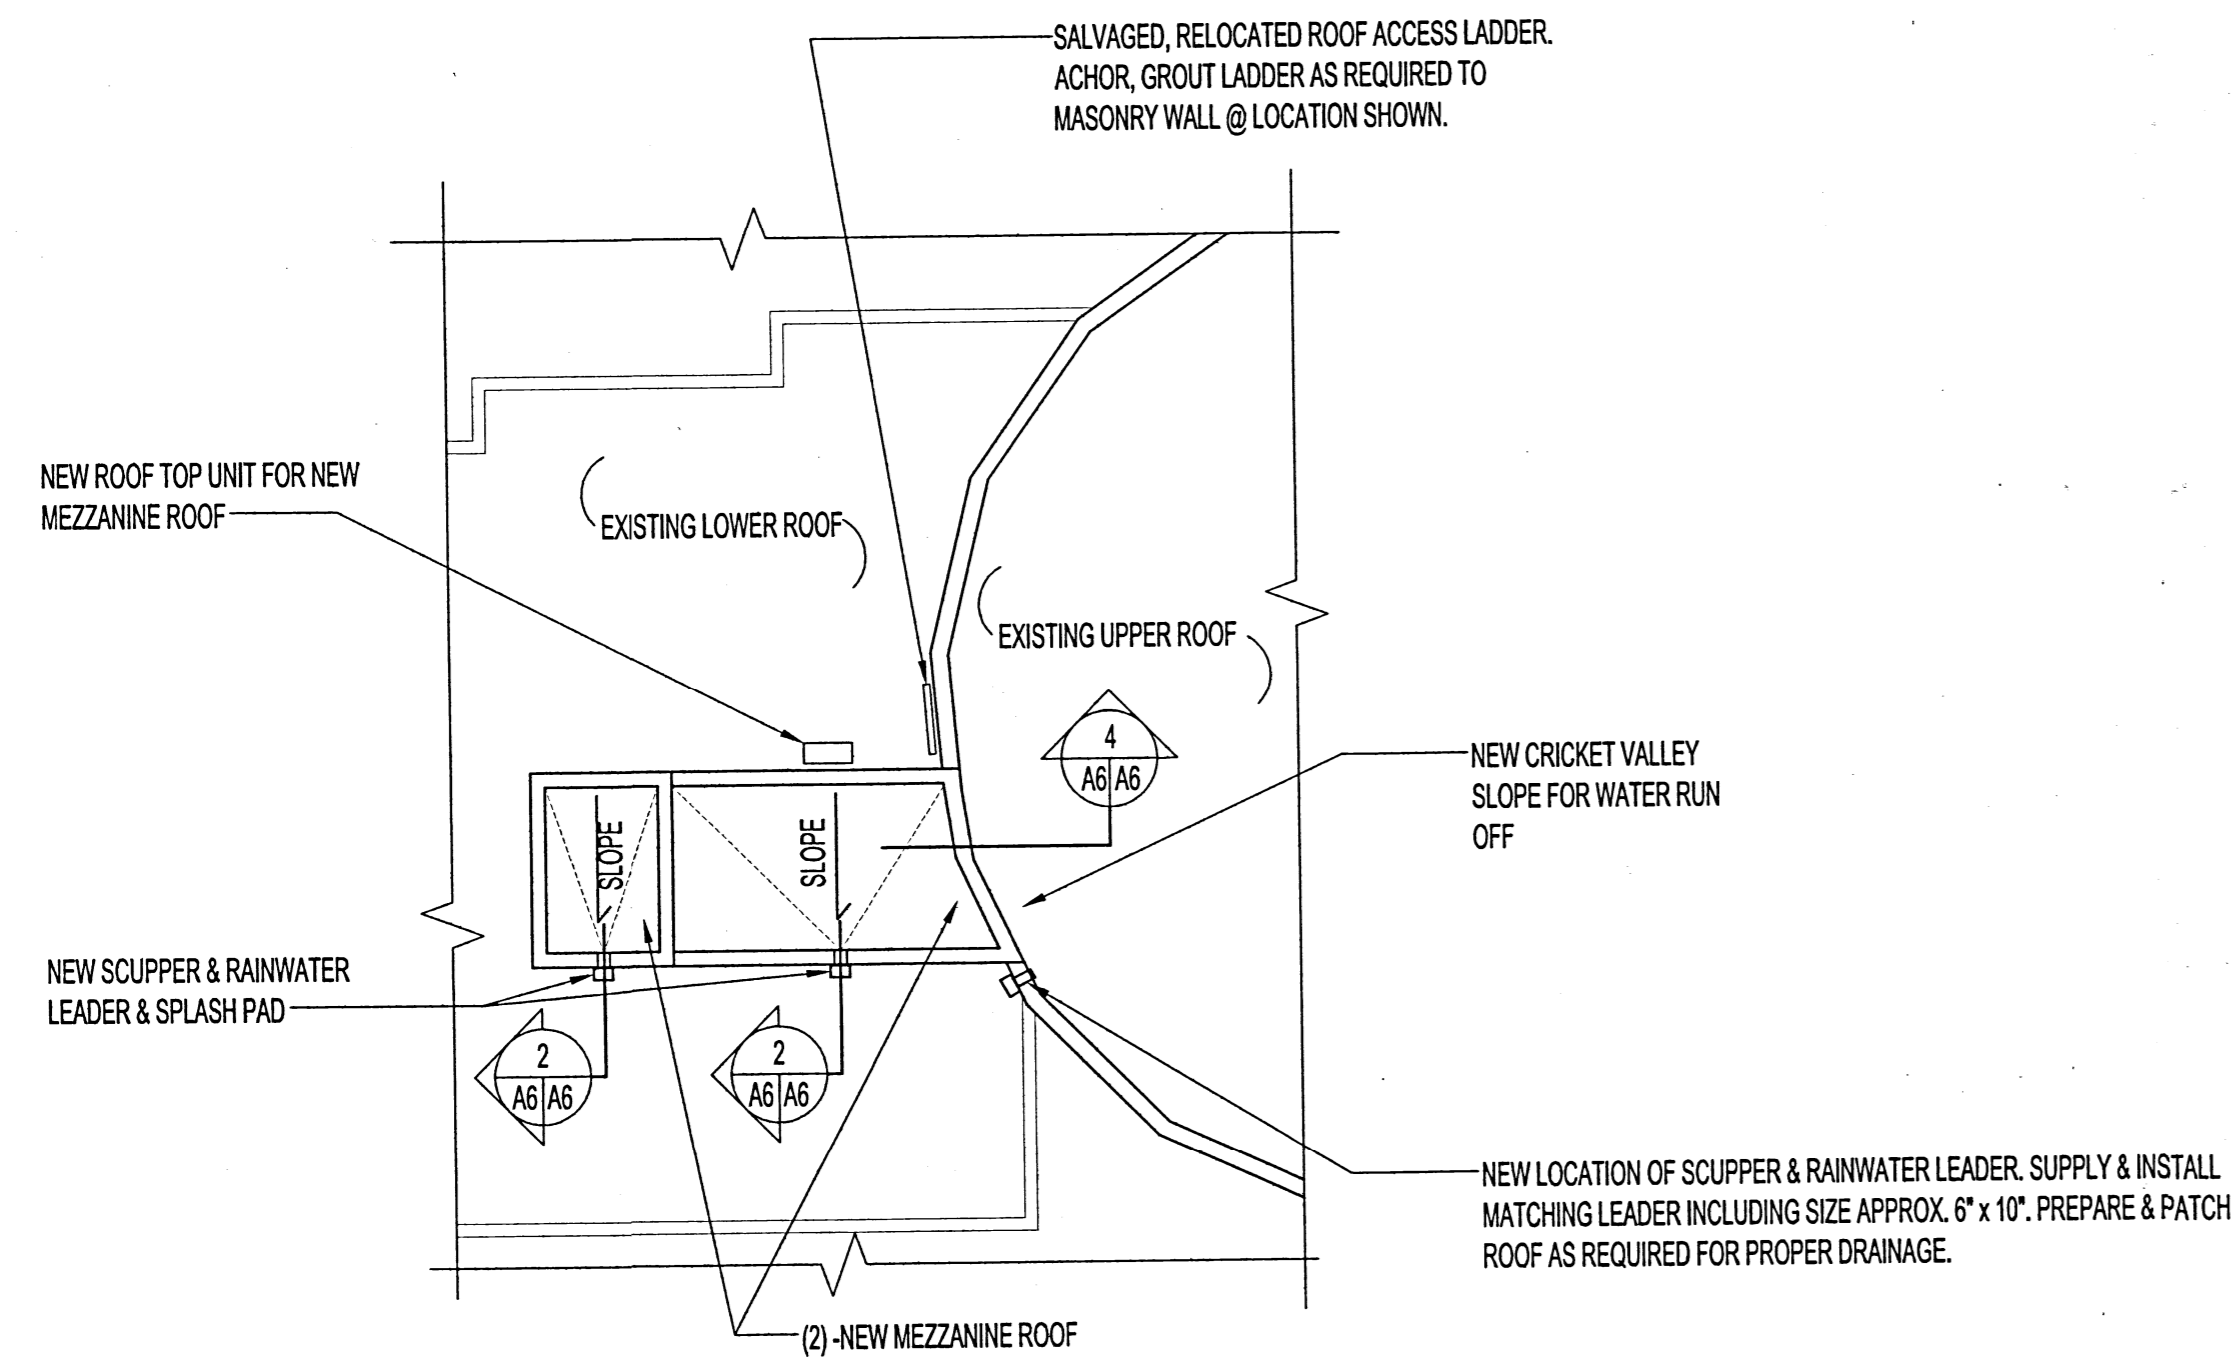


1 ROOF PLAN  
A5 | A6 SCALE 1/4" = 1'-0"

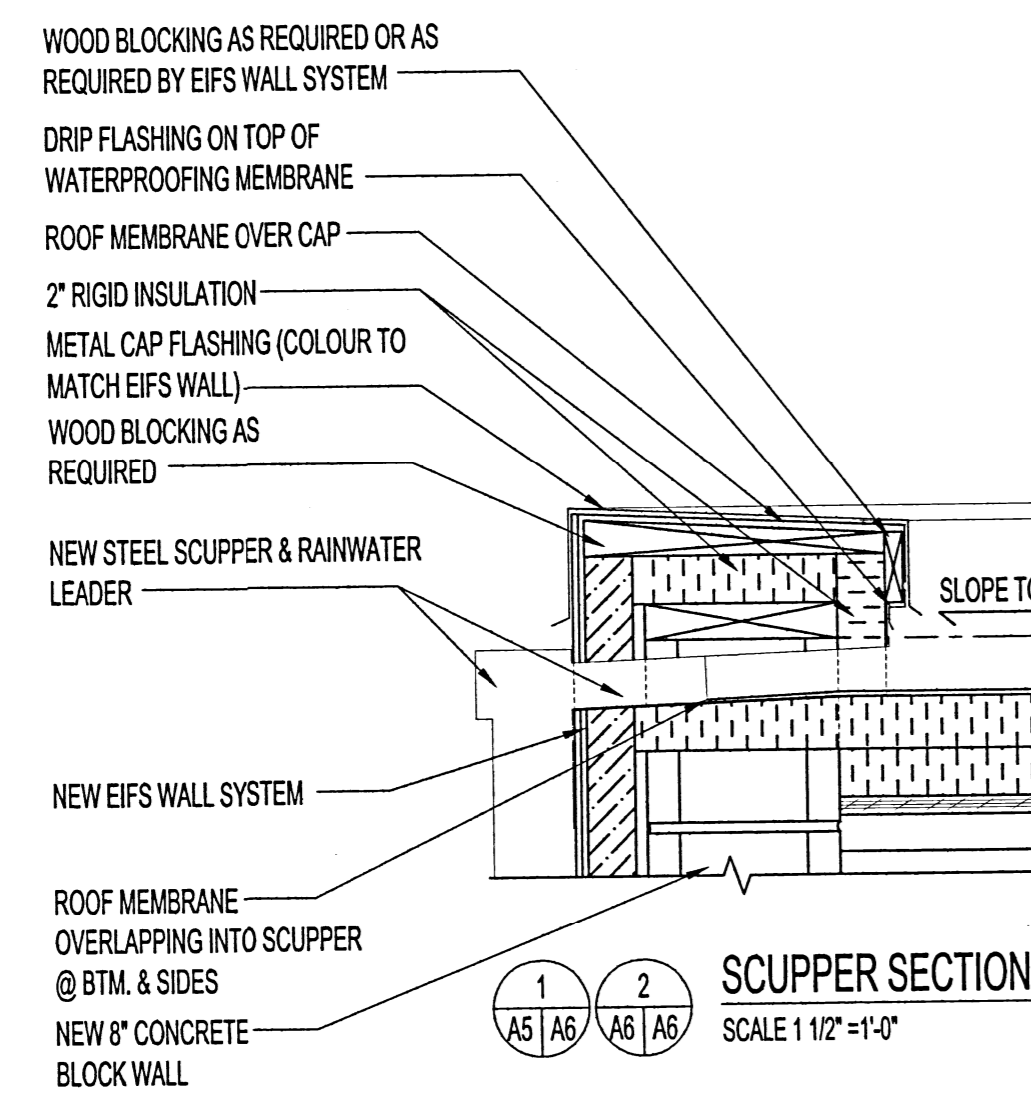


1 SCUPPER SECTION  
A5 | A6 | A6 | A6 SCALE 1 1/2" = 1'-0"


- MODIFIED BITUMEN ROOF MEMBRANE
- 2 LAYERS 2" RIGID INSULATION (SLOPE TO DRAIN)
- AIR VAPOUR BARRIER
- T & G 1/2" WOOD SHEATHING
- 1 1/2" STEEL ROOF DECKING

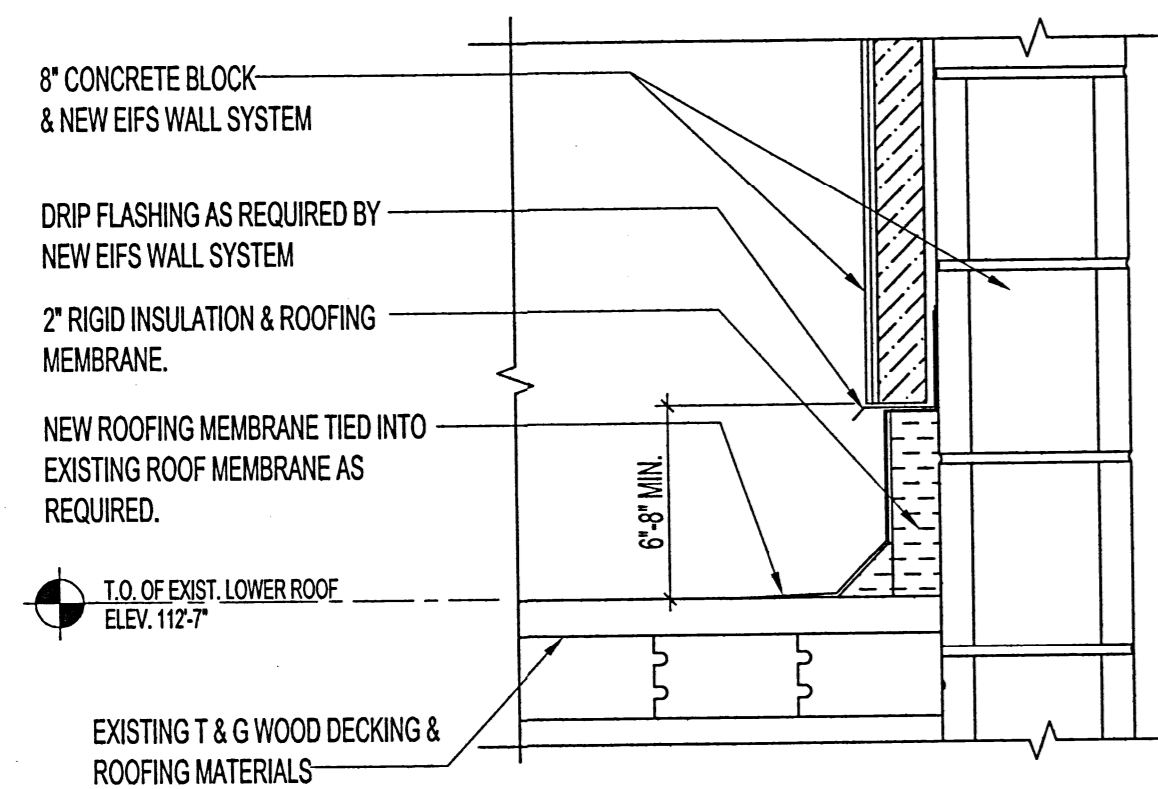

2 EXISTING ROOF & NEW WALL SECTION  
A5 | A6 SCALE 1 1/2" = 1'-0"

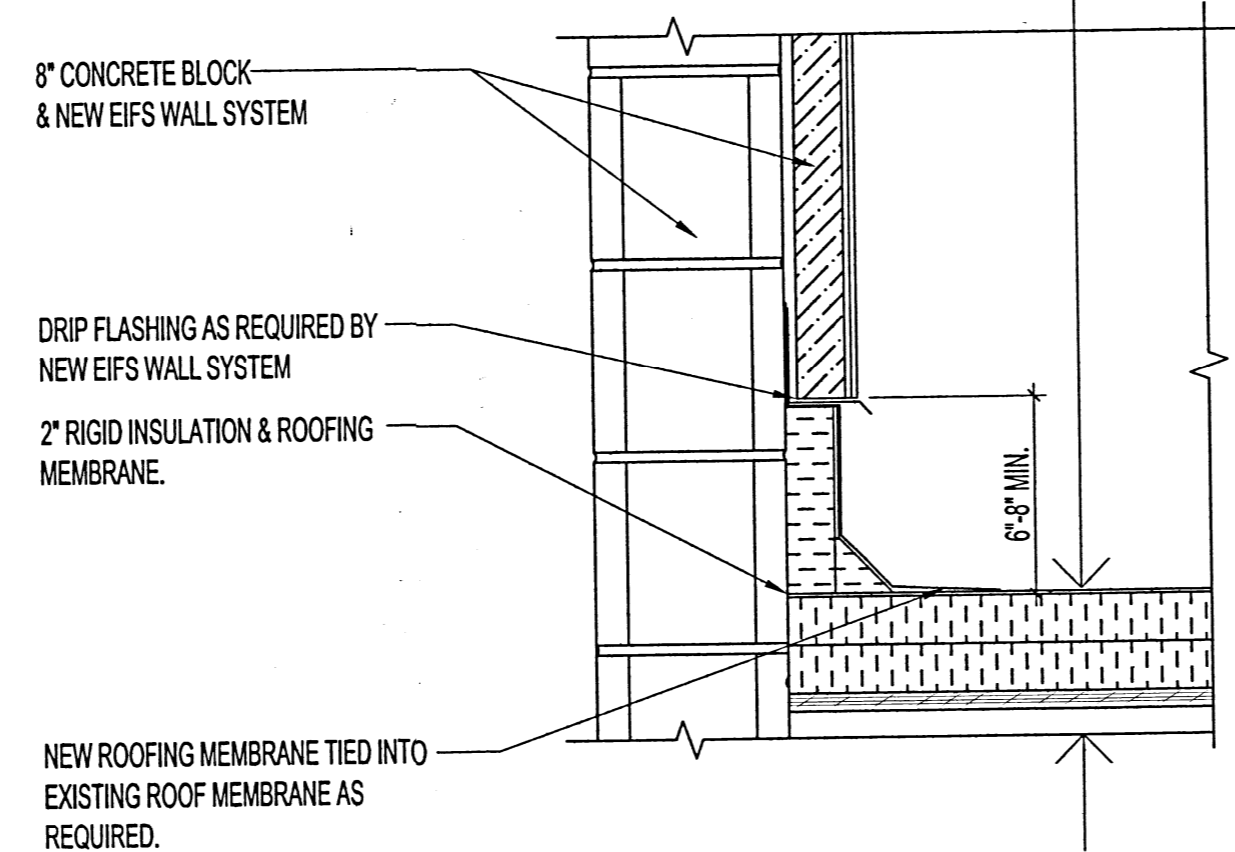

3 LOWER ROOF SECTION @ ELEVATOR SHAFT  
A5 | A6 SCALE 1 1/2" = 1'-0"

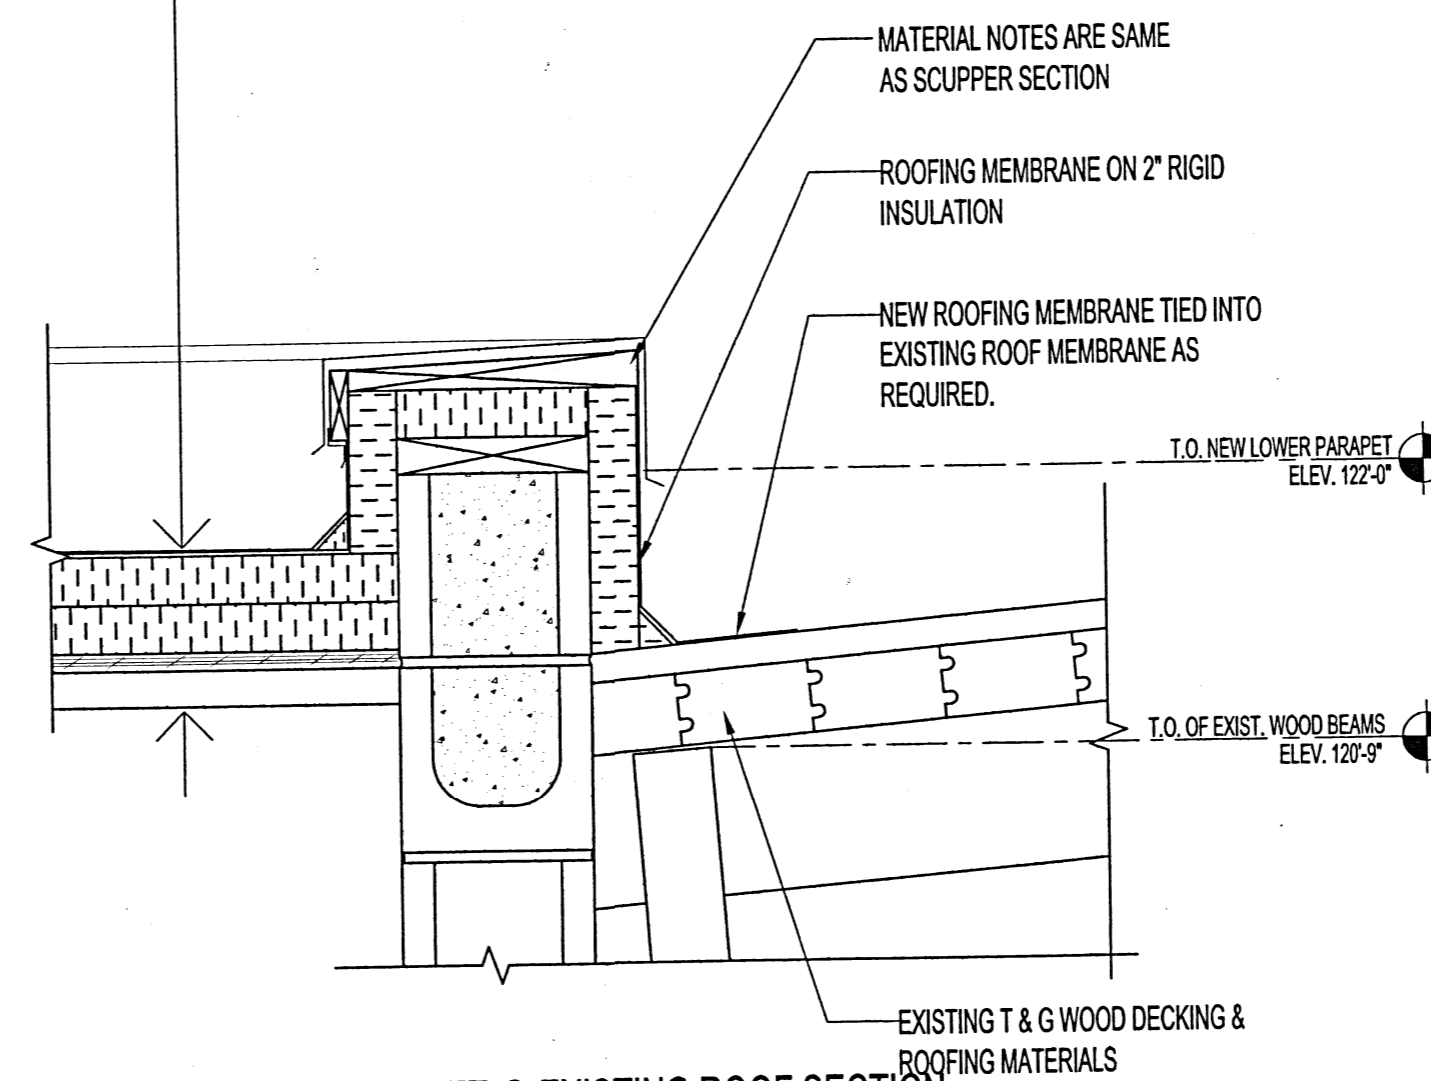

4 PARAPET @ EXISTING ROOF SECTION  
A5 | A6 | A6 | A6 SCALE 1 1/2" = 1'-0"

1	ELEVATOR SHAFT HEIGHTS (ELEVATIONS) REVISED	MMK 2014.10.06
No.	REVISION/DESCRIPTION	BY DATE
SEAL		



DRAWN	MMK	CHECKED	DESIGNED	APPROVED
DATE	2014.07.11	USER	APPROVAL	

THE CITY OF WINNIPEG  
PLANNING, PROPERTY AND  
DEVELOPMENT DEPARTMENT  
MUNICIPAL ACCOMMODATIONS DIVISION  
3-65 GARRY STREET, R3C 4K4

PROJECT  
ST. VITAL LIBRARY  
NEW ELEVATOR INSTALLATION

6 FERMOR AVENUE

SHEET TITLE  
ROOF PLAN  
ROOF & PARAPET DETAILS

SCALE	PROJECT No:	SHEET No:
AS SHOWN		A6R1

DRAWING SHEET SIZE: A1 (841mm x 594mm) PLOT 1:1