WO 101-84 **GENERAL NOTES FOR STRUCTURES:**

GENERAL

- IN METRES AND ALL OTHER DIMENSIONS ARE SHOWN IN MILLIMETRES.
- 2. CONTRACTOR MUST VERIFY ALL EXISTING AND PROPOSED GEOMETRY, DIMENSIONS, ELEVATIONS AND LAYOUT IN THE FIELD PRIOR TO FABRICATION AND CONSTRUCTION AND NOTIFY THE CONTRACT ADMINISTRATOR OF ANY CHANGES. EXISTING DIMENSIONS ARE APPROXIMATE ONLY.
- 3. CONTRACTOR MUST VERIFY, SAFEGUARD AND PROTECT ALL EXISTING UTILITIES PRIOR TO EXCAVATION OR CONSTRUCTION. ANY DAMAGE TO EXISTING STRUCTURES AND UTILITIES BY THE CONTRACTORS OPERATIONS MUST BE REPAIRED BY THE CONTRACTOR AT HIS OWN COST.
- 4. ALL REFERENCES TO CODES, STANDARDS, SPECIFICATIONS, GUIDELINES, ETC, SHALL MEAN THE LATEST EDITION.
- 5. THESE DRAWINGS TO BE READ IN CONJUNCTION WITH THE CONTRACT SPECIFICATIONS.
- 6. ALL WORK SHALL CONFORM TO THE 2010 MANITOBA BUILDING CODE.
- 7. ALL WORK TO BE PERFORMED IN ACCORDANCE WITH APPLICABLE LEGISLATION AND REGULATIONS INCLUDING, BUT NOT LIMITED TO, OCCUPATIONAL HEALTH AND SAFETY ACT AND REGULATIONS.

EXCAVATION AND BACKFILL

- 1. ALL EXCAVATIONS SHALL BE COMPLETELY DEWATERED DURING CONSTRUCTION TO PREVENT UPLIFT OF THE STRUCTURE. KEEP EXCAVATION DEWATERED TO, AT LEAST, 300 mm BELOW LOWEST ELEVATION OF EXCAVATION.
- 2. PLACE ALL CONCRETE IN THE DRY.
- 3. THE FOUNDATION SLABS SHALL BEAR ON LAYER OF WELL GRADED GRANULAR/CRUSHED ROCK COMPACTED TO 100% STANDARD PROCTOR DRY DENSITY (SPDD) UNLESS OTHERWISE INDICATED.

CAST IN PLACE CONCRETE

- 1. CONCRETE MATERIAL, QUALITY, MIXING, PLACING, FORM WORK AND OTHER CONSTRUCTION PRACTICES TO CONFORM TO CSA A23.1 / A23.2 - 2009
- 2. ALL EXPOSED CORNERS SHALL HAVE A 20 mm CHAMFER OR FILLET UNLESS OTHERWISE NOTED.

| TYPE | SUPPLY AND PLACE STRUCTURAL CONCRETE | STRENGTH (MPa) | EXP. CLASS |
|------|---|-------------------|------------|
| 1 | PILES, SCALE HOUSE FOUNDATIONS & SUSPENDED SLABS | 35 @ 56 DAYS | S-1 |
| 2 | RETAINING WALLS, STAIRS, STRUCTURAL SLABS & SCALE FOUNDATIONS | 35 @ 28 DAYS | C-1 |

ANCHOR BOLTS FOR LIGHT STANDARDS

- 1. ANCHOR BOLTS SHALL BE IN ACCORDANCE WITH ASTM F1554 GRADE 55 (380MPa), HOT DIPPED GALVANIZED.
- 2. ANCHOR BOLTS SHALL BE 25Ø x 915 LONG C/W 150 HOOK.
- 3. CONFIRM ANCHOR BOLT SIZE, B.C.D. AND PROJECTION WITH LIGHT STANDARD SUPPLIER PRIOR TO INSTALLATION.
- 4. PROTECT THREADS FROM FOULING DURING CONCRETE POUR.
- 5. ANCHOR BOLTS TO BE SET USING STEEL SETTING TEMPLATE (MIN. 10 THICK) TO BE REMOVED AFTER MIN. 24hr CURING PERIOD.
- 6. REFER TO SHEET S5 FOR ALIGNMENT OF ANCHOR BOLTS.
- 7. B.C.D. = BOLT CIRCLE DIAMETER.

POST-INSTALLED ANCHOR BOLTS

- 1. UNLESS OTHERWISE NOTED, POST-INSTALLED ANCHOR BOLTS SHALL BE HILTI KWIK BOLT TZ - SS TO THE DIAMETER AND LENGTH AS INDICATED ON THE DRAWINGS OR EQUAL AS APPROVED BY THE CONTRACT ADMINISTRATOR.
- 2. CONTRACTOR SHALL FOLLOW MANUFACTURER'S INSTALLATION INSTRUCTIONS.

HANDRAILS AND GUARDRAILS

- 1. STEEL PIPE SHALL BE IN ACCORDANCE WITH ASTM A53 TYPE S GRADE A OR B.
- 2. GALVANIZE IN ACCORDANCE WITH ASTM A123-09 TO A NET RETENTION OF 610 g/m2
- 3. GALVANIZING HANDRAIL AND GUARDRAILS SHALL RESULT IN A SMOOTH SURFACE FREE OF SHARP EDGES AND PROJECTIONS.
- 4. VENT HOLE SIZE AND LOCATIONS AS PER GALVANIZING PROCESS REQUIREMENTS.
- 5. EXPANSION JOINTS SHALL BE LOCATED TO ACCOMMODATE GALVANIZING PROCESS. _

MISCELLANEOUS METAL FABRICATIONS

- 1. STEEL SHALL BE IN ACCORDANCE WITH CSA G40.21 GRADE 300W UNLESS OTHERWISE NOTED.
- 2. ALL FABRICATIONS SHALL BE HOT-DIP GALVANIZED IN ACCORDANCE WITH ASTM A123-09 TO A NET RETENTION OF 610 g/m2
- 3. CONTRACTOR SHALL PREPARE AND SUBMIT DETAILED SHOP DRAWINGS PRIOR TO COMMENCING FABRICATION.


REINFORCING STEEL FOR CAST-IN-PLACE CONCRETE

- 1. ALL REINFORCING SHALL BE BLACK STEEL CONFORMING TO CSA G30.18-09, GRADE 400W.
- 2. ALL REBAR SHALL BE STORED ON WOOD BLOCKING AT THE SITE.
- 3. CONCRETE CLEAR COVER TO REINFORCEMENT UNLESS NOTED OTHERWISE:

| PILES | 75 mm |
|-------------------|-------|
| RETAINING WALLS | 60 mm |
| STRUCTURAL SLABS: | |
| TOP LAYER | 60 mm |
| BOTTOM LAYER | 50 mm |
| | |

| BAR SIZE | TOP BARS (mm) | |
|----------|------------------|--|
| 10 | 700 | |
| 15 | 1000 | |
| 20 | 1200 | |
| 25 | 1900 | |
| 30 | 2200 | |
| 35 | 2650 | |

- 5. LOCATE REINFORCING SPLICES NOT INDICATED ON THE DRAWINGS AT POINTS OF MINIMUM STRESS. LOCATION OF SPLICES TO BE APPROVED BY THE CONTRACT ADMINISTRATOR.
- 6. PROJECTION SHOWN SHALL BE PROVIDED AT CONSTRUCTION JOINTS UNLESS NOTED OTHERWISE.
- 7. BEFORE PLACING REBAR ENSURE IT IS CLEAN, FREE OF LOOSE SCALE, DIRT OR OTHER DELETERIOUS MATERIAL WHICH WOULD REDUCE THE BOND TO CONCRETE.
- 8. CONTRACTOR SHALL PREPARE AND SUBMIT DETAILED REINFORCING STEEL SHOP DRAWINGS AND BAR LISTS PRIOR TO COMMENCING FABRICATION.

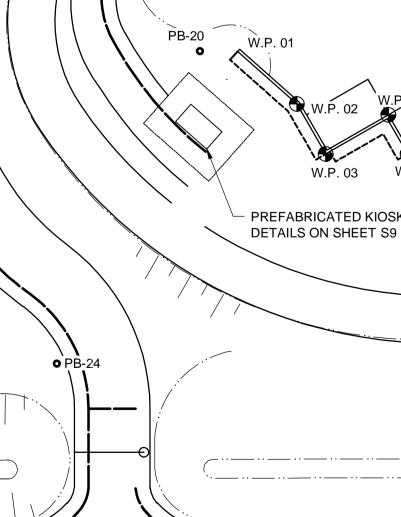


9PB-19

9PB-21

• PB-22

• PB-23

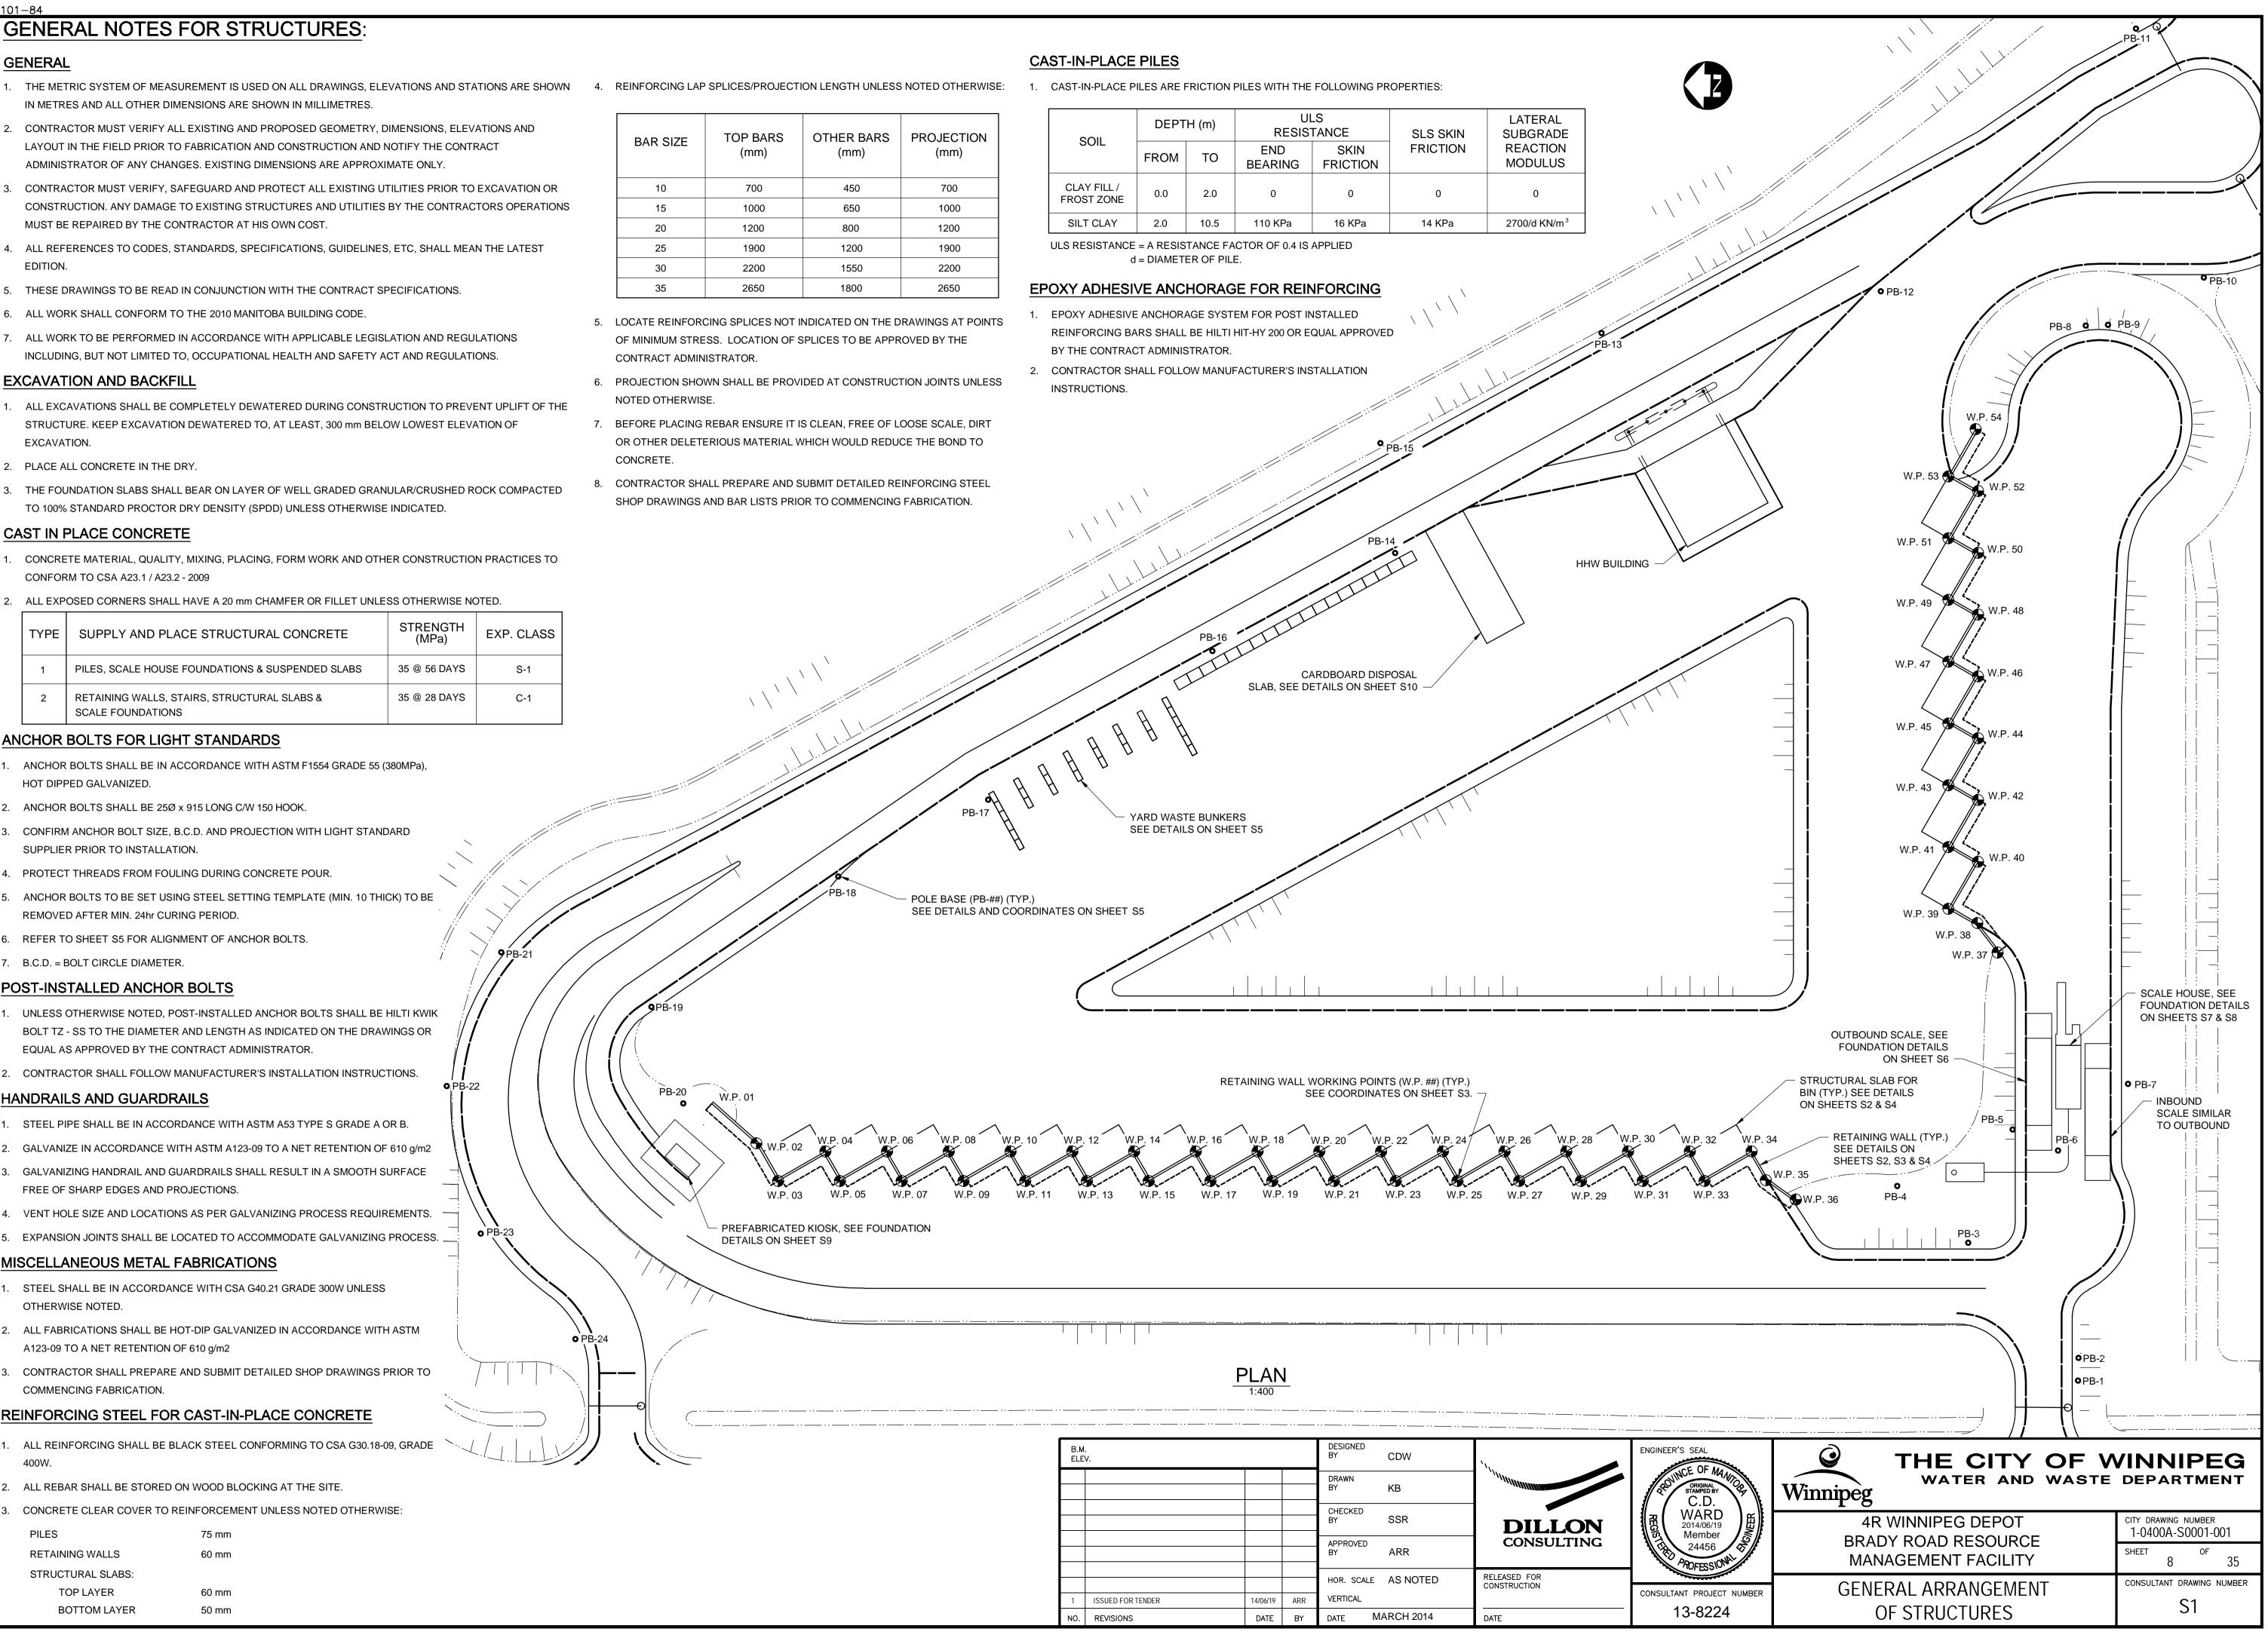

PREFABRICATED KIOSK, SEE FOUNDATION

| B.M. ELEV. | | | | DESIGNED BY CDW | 11. | ENGINEER'S SEA |
|---------------|-------------------|----------|-----|---------------------|--------------------------------|---------------------|
| | | | | DRAWN BY KB | | ORIONINCE C |
| | | | | CHECKED BY SSR | DILLON | REG 2014, Mer |
| | | | | APPROVED BY ARR | CONSULTING | Mer 24- PROF |
| | | | | HOR. SCALE AS NOTED | D RELEASED FOR CONSTRUCTION | |
| 1 | ISSUED FOR TENDER | 14/06/19 | ARR | VERTICAL | | CONSULTANT PR |
| NO. | REVISIONS | DATE | BY | DATE MARCH 2014 | DATE | 13-8 |