




12-10-67
11-3-67

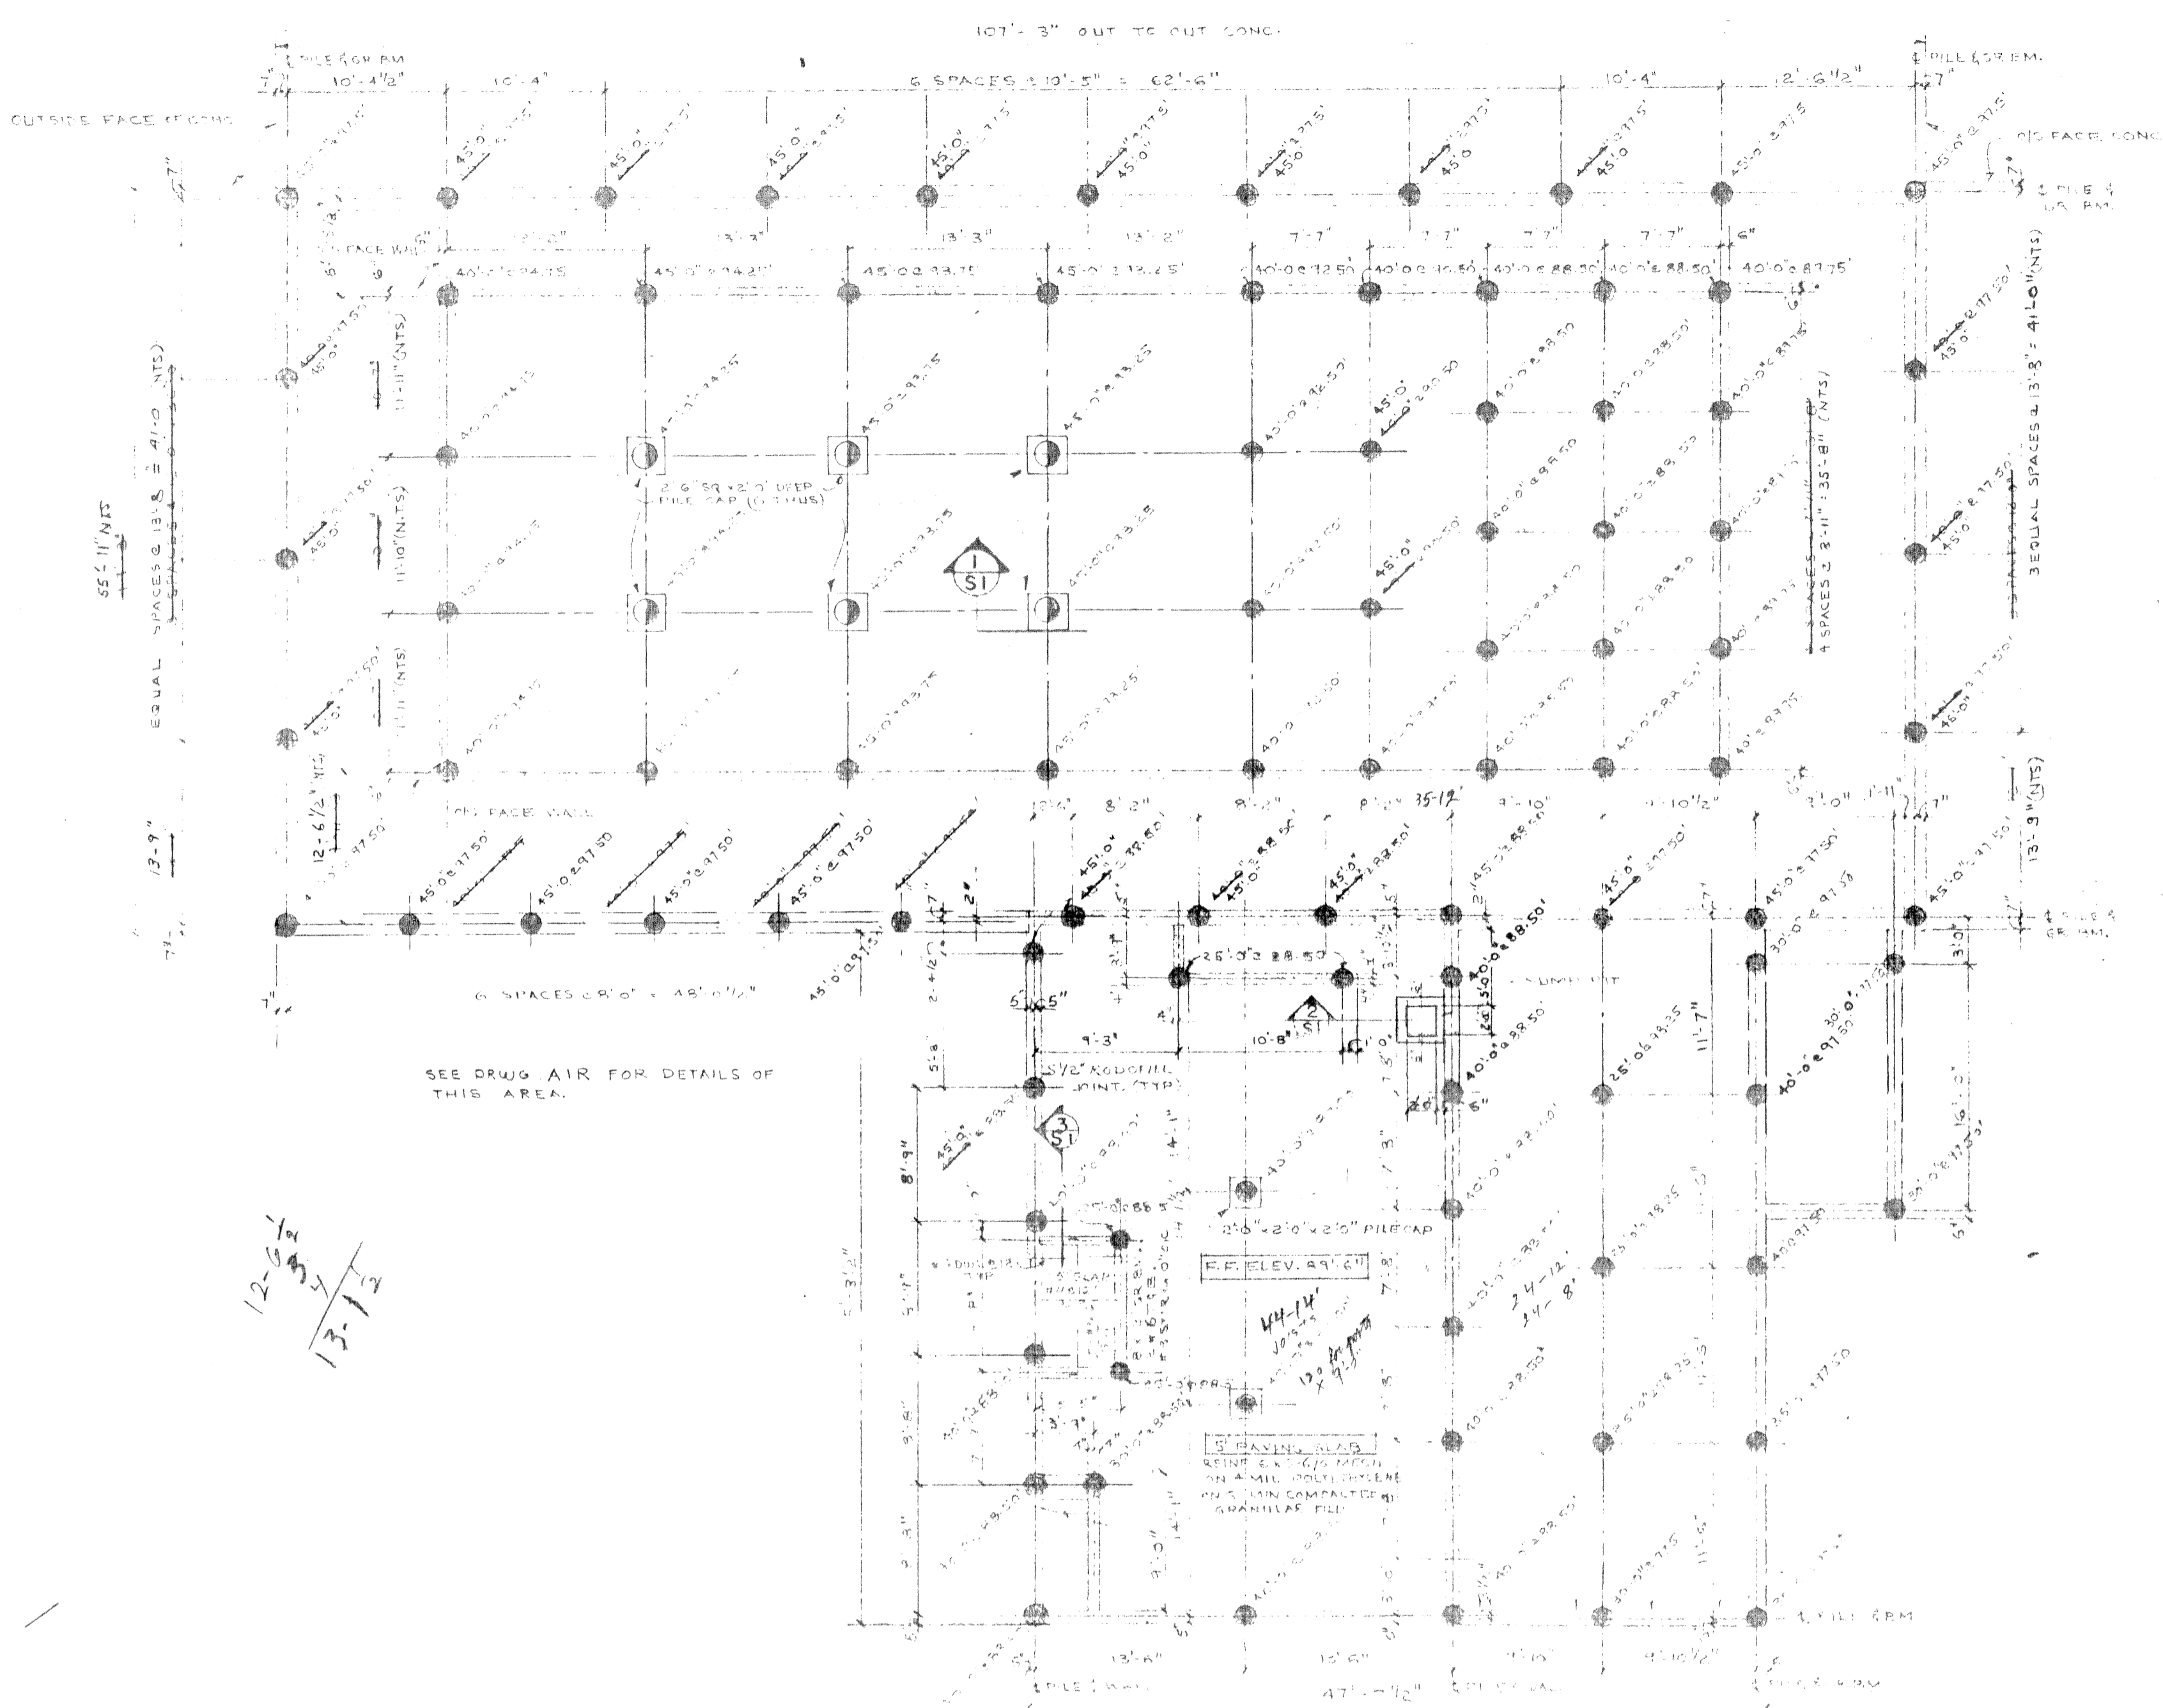

PILE LAYOUT AND FOUNDATION PLAN
SCALE: 1/4" = 1'-0"

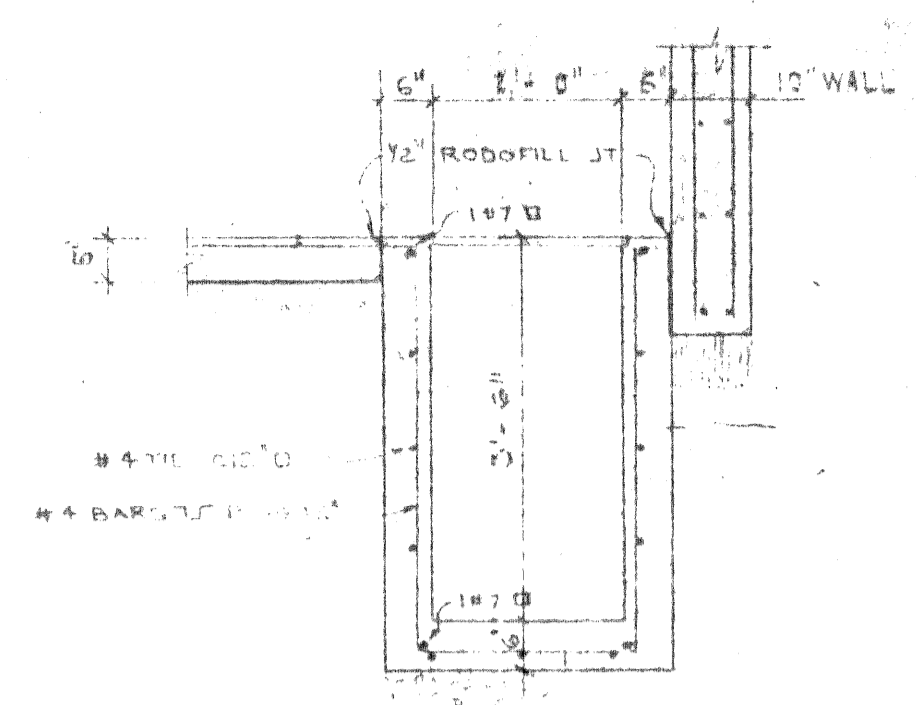

SECTION 2
SCALE: 1/4" = 1'-0"

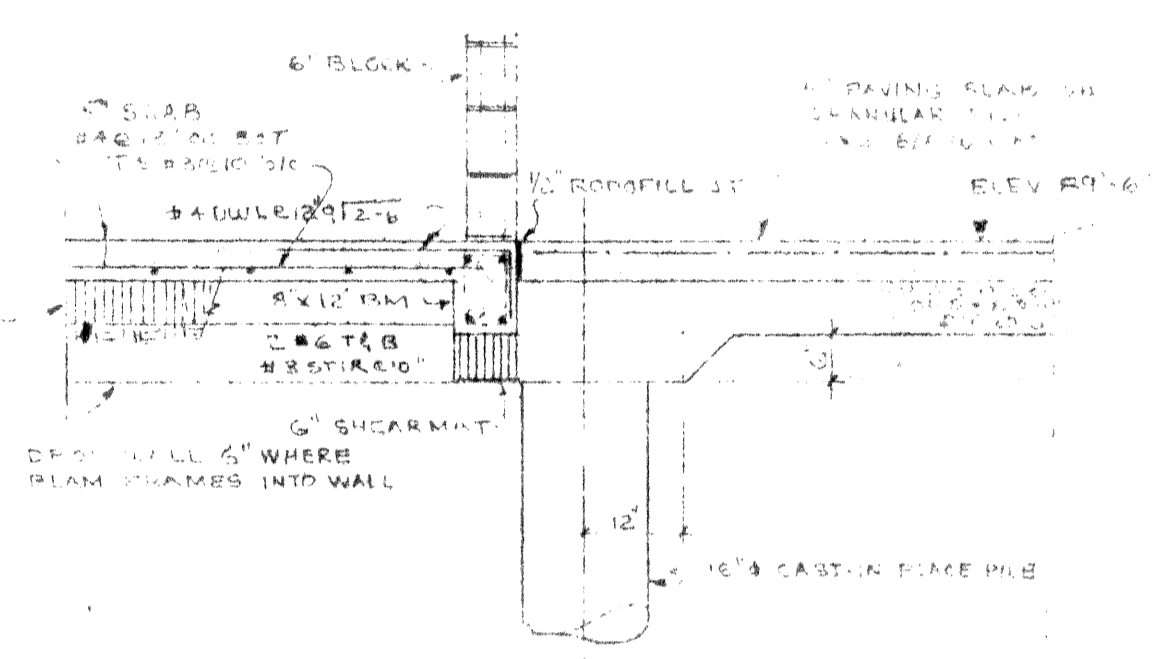


SECTION 3
SCALE: 1/4" = 1'-0"


- Notes:
1. CONCRETE FOR ALL PILES AND WALLS TO BE 3000 PSI COMPRESSIVE STRENGTH.
 2. REINFORCING BARS TO BE #5 TIES & #4 BARS.
 3. ALL REINFORCING BARS TO BE NEW DEFORMED BARS.
 4. PROVIDE MIN. 3" COVER TO REINFORCING BARS.

- LEGEND
- PILE LENGTH
 - 10" - CAST-IN-PLACE PILE
 - 20" - CAST-IN-PLACE PILE

12-6-67
13-1-67

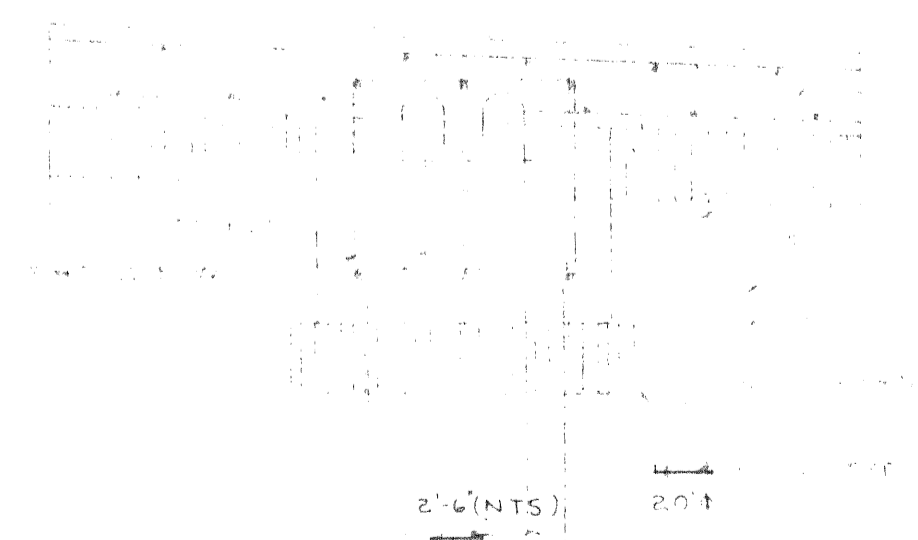


SECTION 1 SI
SCALE: 1/4" = 1'-0"

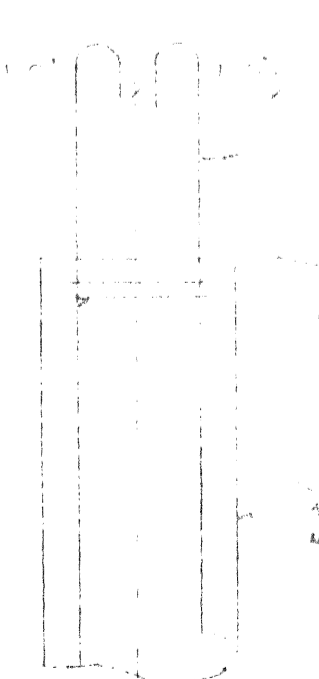

TYPICAL PILE TO WALL CONNECTION
SCALE: 1/4" = 1'-0"

NO.	DESCRIPTION	DATE	BY	CHKD.
1	GENERAL REVISION FOR POOL ADDITION	3/1/67	RJC	

B-14
FILE
RETURN TO CIVIC
PROPERTIES BUILDING
INVENTORY.
3 02 4

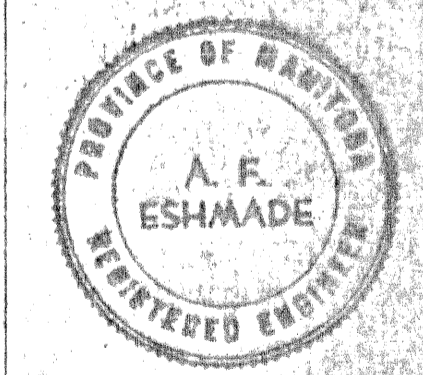

APPROVED BY: *A.F. Eshmae* DATE: 14/12/67

TRANSCONA SWIMMING POOL BUILDING

PILE LAYOUT & DETAILS
DWIGHT R. JOHNSTON M.R.A.I.C.
ARCHITECT
1854 PORTAGE AVE. ST. JAMES, MANITOBA

UNDERWOOD McLELLAN & ASSOCIATES
LIMITED

CONSULTING PROFESSIONAL ENGINEERS
MANITOBA SASKATCHEWAN ALBERTA BRITISH COLUMBIA

DRAWN BY: R.C.	DESIGNED BY: R.T.C.
CHECKED BY:	CHECKED BY:
DATE DRAWN: 31st MARCH 1967	SCALE: AS SHOWN
JOB NO: 23-723-02	DRAWING NO:
SHEET 9 OF 16	

S1A