


**WET WELL PARTIAL FLOOR PLAN**  
SCALE 1 : 20

**SPECIFIC NOTES:**

1. INSTALL BEAMS.
2. SAWCUT SLAB FOR OPENINGS.
3. DO NOT OVER CUT CORNERS.
4. CHANNELS AND ANGLE FINISH: SSPC-SP6 SURFACE PREPARATION C/W 2) COATS SELF-PRIMING EPOXY PAINT (10 MILS TOTAL DFT). (INTERNATIONAL P.C. INTERGARD 345 OR EQUIV.) COLOUR: GREY
5. BOLTS TO BE ASTM A193/A320 GRADE B8M CLASS 2 (AISI SS316) C/W ASTM A194 GRADE 8M NUTS (AISI SS316) AND AISI SS 316 WASHERS.
6. CONCRETE ANCHORS HILTI KWIK BOLTS 3, STAINLESS STEEL, EMBED MINIMUM 95 INTO CONCRETE.
7. LOCATE EXISTING REBAR IN CONCRETE BEAMS. SPACE BETWEEN CHANNELS IS ±50 TO ALLOW HILTI ANCHORS TO MISS REBAR.

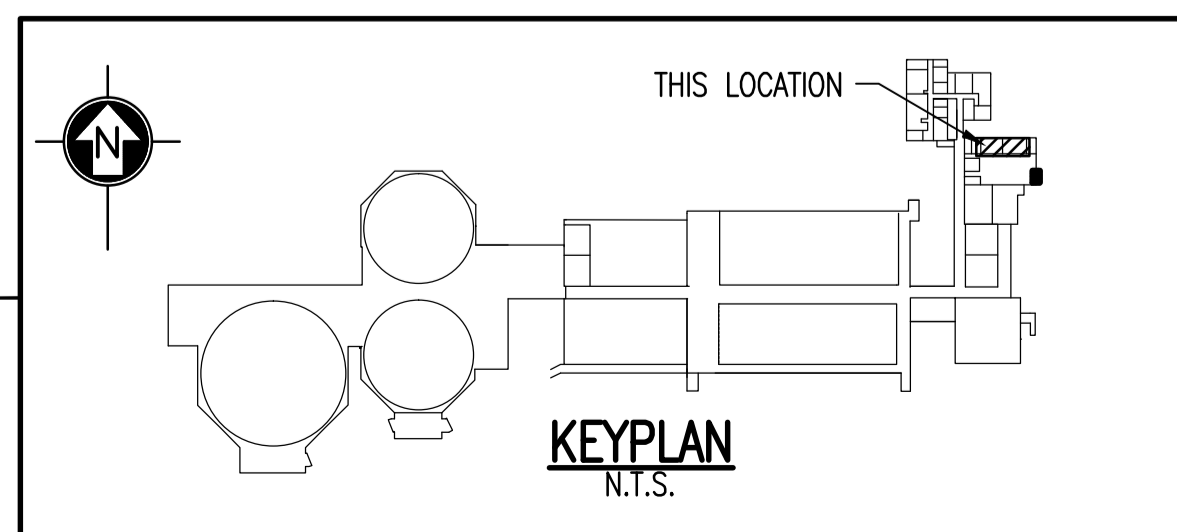

NO.	REVISIONS	DATE	DESIGN	CHECK
00	ISSUED FOR TENDER, BID OPP. 545-2012	2012/10/15	KK	RB

SNC-LAVALIN INC. 148 Nature Park Way Winnipeg, MB, Canada R3P 0X7 204-786-8080	
DESIGNED BY: K. KOTYK	CHECKED BY: R. BEAN
DRAWN BY: M. TUGADE	APPROVED BY: C. REIMER
SCALE: AS NOTED	RELEASED FOR CONSTRUCTION BY: NEIL HARRINGTON DATE: 2012/10/15
DATE: 2012/06/18	DATE: 2012/10/15
CONSULTANT NO.: 112577-0116-42DD-00045	

ENGINEER'S SEAL  
 ORIGINAL DRAWING  
 SEALED BY:  
 K. K. KOTYK  
 SNC-LAVALIN  
 MEMBER #21950  
 2012/10/18  
 REV. 00

**THE CITY OF WINNIPEG**  
 WATER AND WASTE DEPARTMENT  
 SOUTH END WATER POLLUTION CONTROL CENTRE  
 VENTILATION & MISC. UPGRADE  
 MECHANICAL OPENING & DETAILS  
 GRIT BUILDING WET WELL  
 CITY DRAWING NUMBER: 1-0102G-S0018  
 SHEET: 001  
 REV: 00  
 SIZE: A1