

PARKING LOT PANEL MOUNTING DETAIL

C/W IPLC UNIT

N.T.S

2. PROVIDE ADDITIONAL CONTROL PROGRAMMING TO OWNER'S

3. REFER TO STRUCTURAL FOR BASE MOUNT DIMENSIONS.

CURRENT DRAW TO BLOCK HEATER ONLY.

SATISFACTION. ???

DATE

HEATING SCHEDULE

TYPE	WATTS	VOLTAGE	DESCRIPTION	MANUFACTURER	CATALOGUE #	REMARK
Α	1400	347V/1PH	BASEBOARD	OUELLET	ODB140X-1952	NOTE 1
В	1600	347V/1PH	BASEBOARD	OUELLET	ODB160X-2175	NOTE 1
G	2000	347V/1PH	BASEBOARD	CHROMALOX	BL-8420W51	NOTE 1
FF4	4000	347V/1PH	FORCEFLOW	CHROMALOX	RFV-842051	NOTE 2

SPECIFIC HEATING NOTES


- 1. C/W BUILT-IN THERMOSTAT OR WIRED TO REMOTE THERMOSTAT AS SHOWN ON DRAWINGS
- 2. RECESSED UNLESS OTHERWISE INDICATED. COMPLETE WITH BUILT-IN THERMOSTAT UNLESS OTHERWISE INDICATED.
- 3. C/W BUILT-IN THERMOSTAT. MOUNT SECURELY WHERE INDICATED TO THE SATISFACTION OF THE ENGINEER.
- 4. (GENERAL) VOLTAGE TO BE AS INDICATED ABOVE UNLESS OTHERWISE NOTED ON DRAWINGS.
- 5. (GENERAL) APPROVED EQUAL: OUELLET.

GENERAL ELECTRICAL NOTES

E.C. TO SUPPLY, INSTALL, WIRE, AND CONNECT EXTERIOR FLOOD LIGHTING TO ACCOMMODATE COMPLETE SITE SIGNAGE SYSTEM, AS REQUIRED.

NOTE TO DESIGN BUILD ELECTRICAL CONTRACTOR

Include in electrical work and pricing submission all the electrical requirements indentified in the City of Winnipeg request for proposal for this project (design and construction of the public works east yard complex at the former elmwood/nairn landfill site) including all specifications, subsequent addenda, clarifications, all approved changes identified in user group meetings with the City of Winnipeg, and approved change directives as interpreted by the City of Winnipeg and their advocate professional engineers and consultants. The electrical plans outlined herein are provided as a guide to the intent of the request for proposal requirements. In the case of a conflict or omission between the drawings and specifications and the interpreted City of Winnipeg request for proposal, the installation shall be completed in conformance with the City of Winnipeg statement of requirements as interpreted by the City of Winnipeg or their project professional engineering representative.

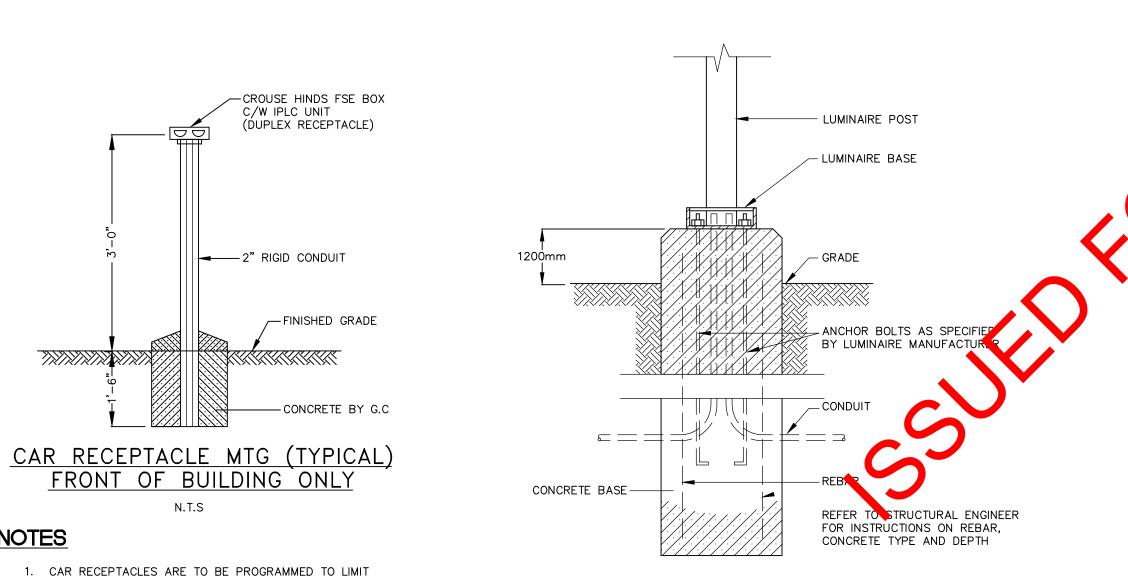

LUMINAIRE BASE DETAIL

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TYPE	DESCRIPTION	CATALOG NUMBER LITHONIA	LAMPS
A	2'x4' FLUORESCENT LUMINAIRE RECESSED IN T-BAR CEILING	2RT5-54T5HO-MVOLT-CSA	2-54W T5H
A1	2'x4' FLUORESCENT LUMINAIRE RECESSED IN T-BAR COMPLETE WITH DAYLIGHT HARVESTING SENSOR	LITHONIA 2RT5-54T5HO-347-CSA C/W DIMMING BALLAST	2-54W T5H
В	HIGH BAY FLUORESCENT LUMINAIRE	GREEN-LIGHTS INC. I-6-3-W	6-54W T5H
вос	HIGH BAY FLUORESCENT LUMINAIRE C/W BUILT IN OCCUPANCY SENSOR	-	6-54W T5H
B1	iMEK 654 1.0 4/54W T5HO FLUORESCENT HIGHBAY C/W LOW TEMP BALLAST — 347V RATED C/W BUILT—IN OCCUPANCY SENSOR	GREEN-LIGHTS INC i-4-x-347V	4-54W T5H
B2	iMEK 654 1.0 4/54W T5HO FLUORESCENT HIGHBAY C/W LOW TEMP BALLAST — 120V RATED C/W BUILT—IN OCCUPANCY SENSOR	GREEN-LIGHTS INC i-4-x-120V	4-54W T5H
С	2'-4" FLUORESCENT LUMINAIRE - RECESSED IN T-BAR CEILING	LITHONIA 2SP5-2-54T5H0-CSA	2-54W T5H
D	8'-0" FLUORESCENT LUMINAIRE - CHAIN SUSPENDED - C/W ASSYMMETRIC REFLECTOR	LITHONIA TZ 2-54T5HO-CSA-ZS5MR46	4-54W T5H
E	4'-0" FLUORESCENT LUMINAIRE - CHAIN SUSPENDED C/W WIREGUARD	LITHONIA Z-1-54T5H0-347-WGZ46	1-54W T5H
F	4'-0" FLUORESCENT LUMINAIRE - SURFACE MOUNTED IN STAIRWELLS	LITHONIA WC-1-54T5HO-47-SA	1-54W T5H
G	8'-0" FLUORESCENT LUMINAIRE CHAIN SUSPENDED C/W WIREGUARD	LITH NIA TZ-1-54T5H - CSA-W Z46	2-54W T5H
Н	4' WET LOCATION FLUORESCENT LUMINAIRE RECESSED IN DRYWALL	LIN ONIA 2WPT-1-54-) 19-347-CSA	2-54W T5H
H1	4' WET LOCATION FLUORESCENT LUMINAIRE RECESSED IN DRYWALL	LITHONIA WRT-1-4-A19-347-CSA	1-54W T5H
J	1'x4' FLUORESCENT LUMINAIRE RECESSED IN T-BAR	LITHONIA SP -G-2-54T5H0-A12-347-CSA	2-54W T5H
J1	1'X4' FLUORESCENT LUMINAIRE CHAIN SUSPENDED TO 10'A.F. T.	LITHONIA CA-2-54T5HO-347-CSA	2-54W T5H
K K1	PORCELAIN INCANDESCENT C/W WIREGUARD PORCELAIN INCANDESCENT RATED FOR EX LOSVE AREA	SMITH & STONE -	1-60W A19
L	RECESSED FLUORESCENT DOWN LIGHT NITABLE FOR WET & DAMP LOCATIONS	LITHONIA LIF6-2/13DTT-347-F6LF73	2-13W DT1
М	4' FLUORESCENT MOUNTED IN VALENCE	LITHONIA Z-1-54T5H0-347-CSA	1-54W T5H
M1	3' FLUORESCENT WALL MENN ED ABOVE MIRROR	LITHONIA WC-1-39T5HO-347-CSA	1-39W T5H
M2	4' FLUORESCENT WALL MUNTED ABOVE MIRROR	LITHONIA	1-54W T5H
N	" " "DORESSENT DOWNLIGHT	WC-1-54T5HO-347-CSA LITHONIA LF6N 2/26 DTT F602AZ	2-26W DT
 P	4'-0" SURFICE NOUN ED FLUORESCENT LUMINAIRE C/W	347 LITHONIA Z-1-54T5H0-347-CSA	1-54W T5H
•	WIREGUARD	WGZ46	1-54W 15H
Q	RONT VESTIBULE LUMINAIRE	_	-
R	6" LED DOWNLIGHT C/W DIMMING	LITHONIA 120V LITHONIA	LED
	1'-4' FLURESCENT RECESSED IN DRYWALL	SP5-F-2-54T5H0-A12-347-CSA	2-54W T5H
Т	8'-0" FLUORESCENT CHAIN SUSPENDED SUITABLE WET & DAMP LOCATIONS	LITHONIA TDMW 2-54T5HO-347-CSA	4-54W T5H
U	4' FLUORESCENT AIRCRAFT CABLE SUSPENDED TO 12'-6"A.F.F	PRUDENTIAL LIGHTING S1-1T5HO-WA-TMW-347-CSA	1-54W T5H
>	1'x4' FLUORESCENT LUMINAIRE RECESSED IN T-BAR	LITHONIA RT5-54T5HO-347-CSA C/W DIMMING BALLAST	2-54W T5H
W	4'-0" FLUORESCENT SUITABLE FOR WET LOCATIONS - CHAIN SUSPENDED	AIMLITE VP4-T5H0-54-AC-347-CSA	2-54W T5H
Х	4'-0" SURFACE MOUNTED FLUORESCENT MOUNTED AT 5'-0" A.F.F. SUITABLE FOR WET LOCATIONS	AIMLITE VP4-T5H0-54-AC-347-CSA	2-54W T5H
1	SINGLE HEAD POST MOUNTED LED COMPLETE WITH 30' HINGED POLE	LITHONIA CSX2-LED-3-30B530/40K-MVOL T-HS-SR3	1-168W LE
2	SINGLE HEAD POST MOUNTED LUMINAIRE COMPLETE WITH 30' HINGED POLE	LITHONIA AS2 400M SR4W	1-400W MH
3	POST MOUNTED LUMINAIRE COMPLETE WITH 40' HINGED POLE	LITHONIA AS2-400M-HPN	1-400W MH
4	DOUBLE HEAD POST MOUNTED LUMINAIRE COMPLETE WITH 40' HINGED POLE	LITHONIA AS2 400M SR4 SC	2-400W MI
5	EXTERIOR BUILDING MOUNTED LUMINAIRE MOUNTED ABOVE DOOR	LITHONIA TWF1-70M-347-CSA-LPI	1-70W MH
6	EXTERIOR BUILDING MOUNTED LUMINAIRE MOUNTED ON EXTERIOR OF BUILDING @ 17'-6" A.F.F.	LITHONIA TWF1-150M-MVOLT-CSA-LPI	1-150W MH
7	BUILDING MOUNTED LUMINIARE MOUNTED AT 20' A.F.F.	LITHONIA ASW2 400M SR4W	1-400W MH
8	QUAD HEAD POST MOUNTED LUMINAIRE COMPLETE WITH 40' HINGED POLE	LITHONIA AS2 400M SR4W	4-400W MI
9	EXTERIOR BUILDING LUMINAIRE MOUNTED @ 25'-4"A.F.F.	LITHONIA ASW2-400M-S-R4SC-10FT-TILT	1-400W MH
10	DOUBLE HEAD POST MOUNTED LUMINAIRE C/W 40' HINGED	LITHONIA AS2-400M-SR4W	2-400W MH
11	POLE SINGLE HEAD POST MOUNTED LUMINAIRE COMPLETE WITH 40' HINCED POLE	LITHONIA AS2 400M SR4W	1-400W MH
	HINGED POLE		

3 ISSUED FOR 99% REVIEW 2012.06.04 2012.03.06 SSUED FOR 66% REVIEW SSUED FOR 33% REVIEW 2012.01.06 ΜZ

DESCRIPTION

NOTES



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PUBLIC WORKS DEPARTMENT

DATE: MARCH 06, 2012

PROJECT TITLE: CITY OF WINNIPEG

SHEET TITLE:

SCHEDULE

PUBLIC WORKS EAST YARD COMPLEX MAIN OFFICE & GARAGES

SYMBOL SCHEDULE

Ceiling mounted luminaire.

Single pole Line Voltage switch.

Single pole Low Voltage switch.

Single pole switch c/w pilot light.

Duplex receptacle weather proof.

Ground fault duplex receptacle.

20A-2P split wired receptacle.

20A t-slot duplex receptacle.

Childproof duplex receptacle.

Fire alarm pull station.

crawlspace.

Junction box. Dishwasher.

240V-1PH, 2300W.) Photocell by Div. 16.

Egress Sign, cold temp, C/W Heater??? Battery Pack, C/W Heater.

Emergency Light Heads — Dual

Humidistat supplied by Div. 15, wired by Div. 16.

CCTV camera location. <u>Verify location before installation..</u>???

Ceiling mounted occupancy sensor, line voltage. Sensorswitch..???

location & requirements with Div. 15. Tie to fire alarm panel.

3. Auxiliary Buildings - Exterior of Door: Down/Stop_station_

Pan, tilt, zoom CCTV camera location. <u>Verify location before installation..</u>???

Ceiling mounted occupancy sensor, low voltage, Dual Technology.. Sensorswitch..???

Thermostat by Div. 16.

Tempature Sensor

prior to installation.

Security system card access.

Security system motion detector.

Overhead door pushbutton station.

Fire alarm booster power supply.

ISWS — Security work station.

Security system door contact.

Electric strike.

Fire alarm isolator.

Request to exit.

Photo electric beam.

Security system keypad. Status Annunciator.

1. Interior of Door: UP/Down/Stop station

2. Exterior of Door: UP/Down/Stop station

Duplex receptacle — half switched.

Motor. Refer to mechanical for exact location.

Disconnect switch to suit application. By div. 16.

Fire alarm audible device, c/w strobe light.

Duplex receptacle c/w AFCI protection.

50A-2P range receptacle, verify location.

30A-2P dryer receptacle, verify location.

Duplex receptacle.

Wall mounted luminaire. 'A' denotes type.

Single pole Live Voltage switches in multiple.

Single pole Low Voltage switches in multiple.

Duplex receptacle mounted on side of counter.

Low voltage dimmer switch c/w separate neutral. Wattage to match circuit.

Duplex receptacle on separate circuit (provide lamacoid label indicating "SC").

Duplex receptacle c/w isolated ground-max 4 receptacles on a 15A-1P circuit.

Duplex receptacle to be connected to emergency power. Provide red hospital-grade receptacle.

Combination voice/data outlet c/w cover plate - Run one(1) - 3/4" conduit to accessible ceiling

CATV outlet c/w cover plate - Run one(1) - 3/4" conduit to accessible ceiling space or

120V carbon monoxide alarm c/w hush feature and battery backup. Mount according to manufacturer's directions. Honeywell???

Electric hand dryer by Div. 16. Recessed, high flow. Model: World Dryer AIRMAX XRM54-Q974.

Universal LED exit sign. Wire to emergency power supply. Aimlite EXSTU M WHT UNVDC.

LED pictogram egress sign. Wire to emergency power supply. Aimlite RPVR C WHT UNVDC.

Supply conductors to be 2 hour fire rated. Interconnect with fire alarm system.???

Elevator motor. Wire and connect as per elevator supplier's instructions. Provide splitter, fusible disconnect switches, control circuits, lighting circuits as required by elevator supplier. Provide 3/4°C. from splitter location to telephone backboard. Install elevator supplier recommended fuses.

Special outlet to match owners equipment. Confirm voltage, amperage, poles and configuration

Chime c/w power, L.V. transformer relay, wiring, etc. by Div. 16. (verify location before installation).

Smoke/Fire damper. Supplied and installed by Div. 15, wired & connected by Div. 16. Coordinate

Microwave outlet above counter (verify location before installation).

Duplex receptacle flush floor mounted. Confirm exact location on site.

c/w two (2x) Cat6 communication cables back to patch panels.

Duplex receptacle mounted above counter level. (See arch. elevations).

Fluorescent luminaire, B1-A — denotes panel circuit No. and switch.

E1.0

SHEET NUMBER:

REVISION NUMBER:

NOT FOR

CONSTRUCTION

CLIENT: CITY OF WINNIPEG PROJECT NUMBER: 31-178E

DRAWN BY: KC

SCALE: AS SHOWN