


1 ROOF PLAN
1:100

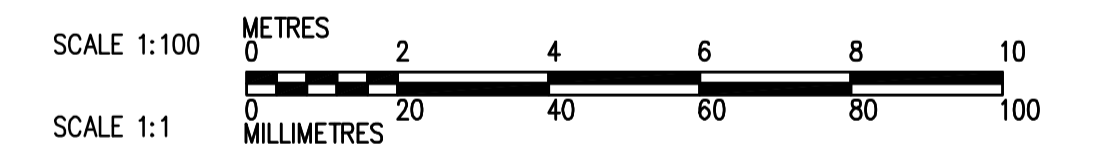

DRAWING NOTES

- ① 915x1220 RELIEF AIR HOOD ON ROOF c/w BACK DRAFT DAMPER. TERMINATE INTAKE OPENING APPROX. 600mm BELOW ROOF DECK. SEE DRAWING WG-H0402 DETAIL 5.
- ② INSULATE ALL SUPPLY AIR DUCT WITH 25mm FOIL FACED INSULATION.
- ③ EXTEND REFRIGERANT SUCTION, LIQUID AND HOT GAS PIPING UP THROUGH ROOF TO CONDENSING UNITS. SEE WG-H401 DETAIL 6.
- ④ COMBINED VENTING/INLET AIR OPENING OF GAS FIRED UNIT HEATER.

GENERAL NOTES

- 1. COORDINATE WITH OTHER TRADES SO AS TO PREVENT CONFLICTS.
- 2. ALL DUCTWORK SHALL BE SUPPORTED AND SUSPENDED AS PER SPECIFICATIONS AND LOCAL CODES (SEE DETAILS).



B.M. ELEV.		 		ENGINEER'S SEAL	
		DESIGNED BY AB/LJW CHECKED BY AMA, PVL DRAWN BY LJW APPROVED BY AHL SCALE: 1:100 RELEASED FOR CONSTRUCTION BY: R. SOROKOWSKI		ORIGINAL SIGNED BY A. BURACHYNSKY 2006/08/30	
00 ISSUED FOR TENDER 06/08/28 LJW		DATE 2006/05/29		CONSULTANT DRAWING NO. WG-H0140	
NO. REVISIONS		DATE BY		DATE 2006/08/30	

THE CITY OF WINNIPEG
 WATER AND WASTE DEPARTMENT
 ENGINEERING DIVISION

WATER TREATMENT PLANT
 STANDBY POWER GENERATOR

MECHANICAL
 VENTILATION PLAN

CITY FILE NUMBER
 SHEET OF
 CITY DRAWING NUMBER
 1-0601G-H0140-001-000