


FOUNDATION PLAN
SCALE : 1:50

CONCRETE SLAB SCHEDULE					
MARK	DEPTH	REINFORCING			REMARKS
		TOP	BOTTOM	BENDING	
S-1	600	20M @ 200 o/c E.W.	20M @ 200 o/c E.W.		SLOPE SLAB

CONCRETE WALL SCHEDULE						
MARK	WIDTH	HEIGHT	REINFORCING			REMARKS
			VERTICAL	HORIZONTAL	ADDITIONAL	
CW-1	400		20M @ 200 o.c. EF	15M @ 200 o.c. EF	20M DOWELS @ 200	
CW-2	200		5 - 15M EW	3 - 15M TIES		

CONCRETE COLUMN SCHEDULE					
MARK	SIZE	REINFORCING			REMARKS
		VERT.	TIES	ADDITIONAL	
CC-1	450x450	4-20M	10M @ 200 o/c		SEE SECTION DWG. S9.02 / CHAMFER CORNERS @ 20mm

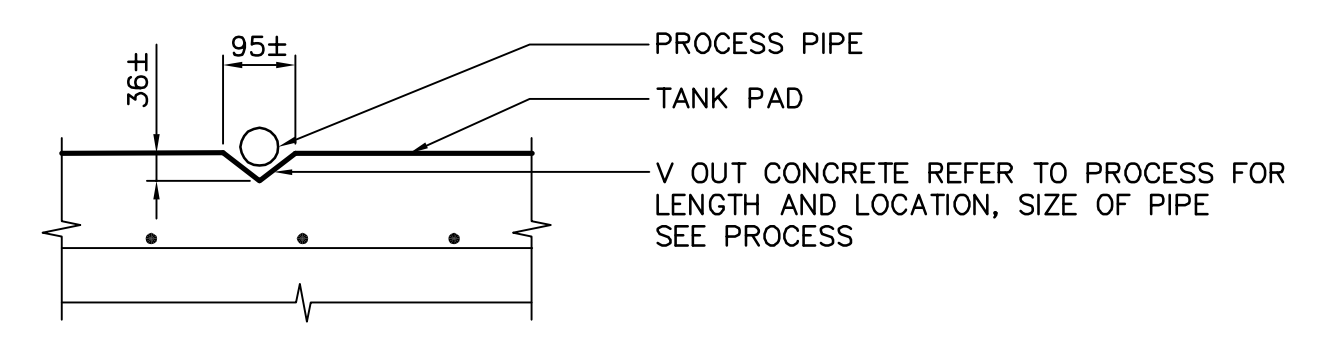

1 SECTION
SCALE 1:10

DRAWING NOTES:
1. REFER TO DRAWING S7.01 FOR GRID LINE DIMENSIONS.



NO.	REVISIONS	DATE	BY
00	ISSUED FOR TENDER	05/10/17	CT

EarthTech
A Tyco International Ltd. Company

DESIGNED BY	AP/GGP	CHECKED BY	MK
DRAWN BY	CT	APPROVED BY	D. TANIGUCHI
SCALE:	AS NOTED	RELEASED FOR CONSTRUCTION BY:	K. MARTENS
DATE	2005/09/07	DATE	05/12/02

ENGINEER'S SEAL
ORIGINAL SIGNED BY
M. KLASSON
2005/12/02
CONSULTANT DRAWING NO.
CS7.02

THE CITY OF WINNIPEG
WATER AND WASTE DEPARTMENT
ENGINEERING DIVISION

NEWPCC CENTRATE NUTRIENT TREATMENT
PHOSPHORUS REMOVAL FACILITY
CONTRACT No. 1

STRUCTURAL
CHEMICAL STORAGE BUILDING
FOUNDATION PLAN AND SCHEDULES

CITY FILE NUMBER	
SHEET	OF
CITY DRAWING NUMBER	1-00F-B-80004-00F-00-D