I-0640C-E0012


I-0640B-E0005

-0640C-E0007

-0640C-E0006

I-0640C-E0003

DRAWING NUMBER

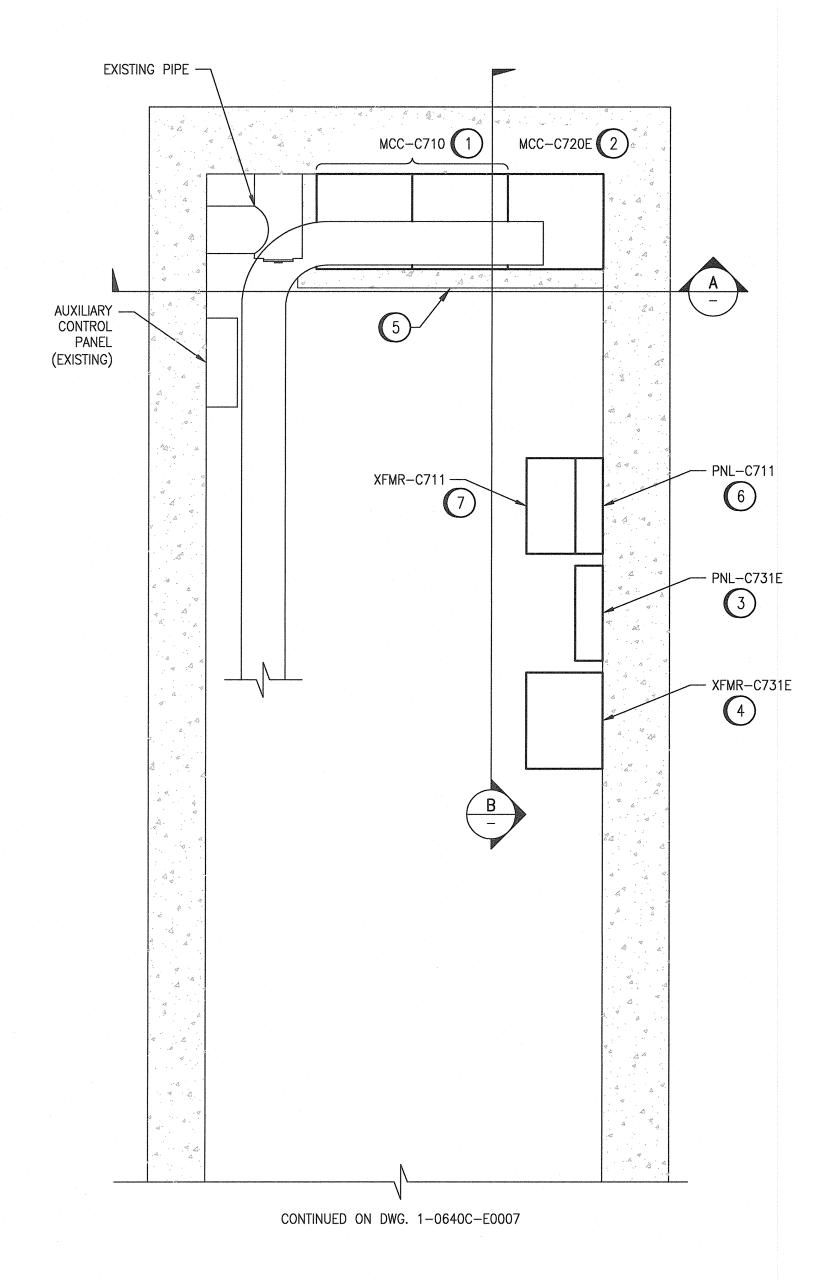



- 1. ALL DEVICES ARE NEW UNLESS SPECIFICALLY NOTED OTHERWISE AND SHALL BE PROVIDED BY THE CONTRACTOR.
- 2. EXISTING CABLE TRAY NOT SHOWN. ALL NEW CABLES ROUTED TO CHLORINE BUILDING ELECTRICAL AREA FROM THE MAIN PUMP HOUSE ELECTRICAL ROOM TO BE ROUTED IN CONDUIT. CONDUIT AND CABLING SYSTEM TO MEET NEMA 4X STANDARD IN CHLORINE BUILDING TANK ROOM AND EQUIPMENT ROOM.
- 3. REFER TO ASBESTOS REPORTS IN APPENDIX B. ASBESTOS IS PRESENT IN AND/OR PRESUMED TO BE PRESENT IN (BUT NOT LIMITED TO) THE FOLLOWING:

PIPING: RAIN WATER LEADER (SWEAT WRAP PIPE INSULATION & PARGING OVER FIBERGLASS)

WALL: VERMICULITE INSULATION (MASONRY)
PLASTER (PREFORMED BLOCK)

LEGEND:

CONSTRUCTION NOTES:


1) PROVIDE NEW NON-ESSENTIAL MCC, MCC-C710.


2 PROVIDE NEW ESSENTIAL MCC, MCC-C720E.

(3) PROVIDE 225A, 120/208V, 3ø, 4W, 30 CCT. PANELBOARD, PNL-C731E.

4 PROVIDE NEW 15 KVA TRANSFORMER, XFMR-C731E.

- PROVIDE HOUSEKEEPING PAD 89mm HIGH, EXTEND 100mm ON FRONT AND LEFT SIDE OF THE EQUIPMENT WITH 20mm CHAMFERED EDGES. PROVIDE REINFORCEMENT AND ANCHOR PAD TO FLOOR SLAB. REFER TO DRAWING 1-0640B-E0005 FOR INSTALLATION DETAILS.
- (6) PROVIDE 225A, 120/208V, 3ø. 4W, 30 CCT. PANELBOARD, PNL-C711.
- 7 PROVIDE NEW 30 KVA TRANSFORMER, XFMR-C711.

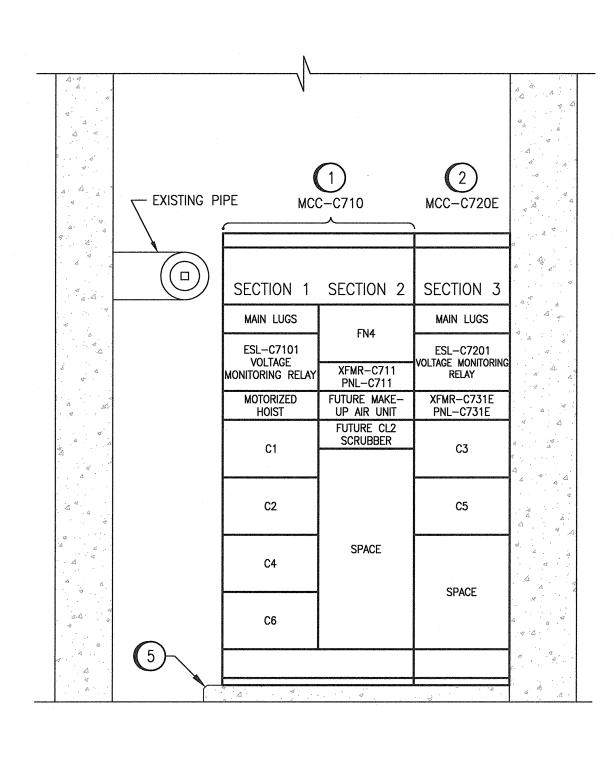

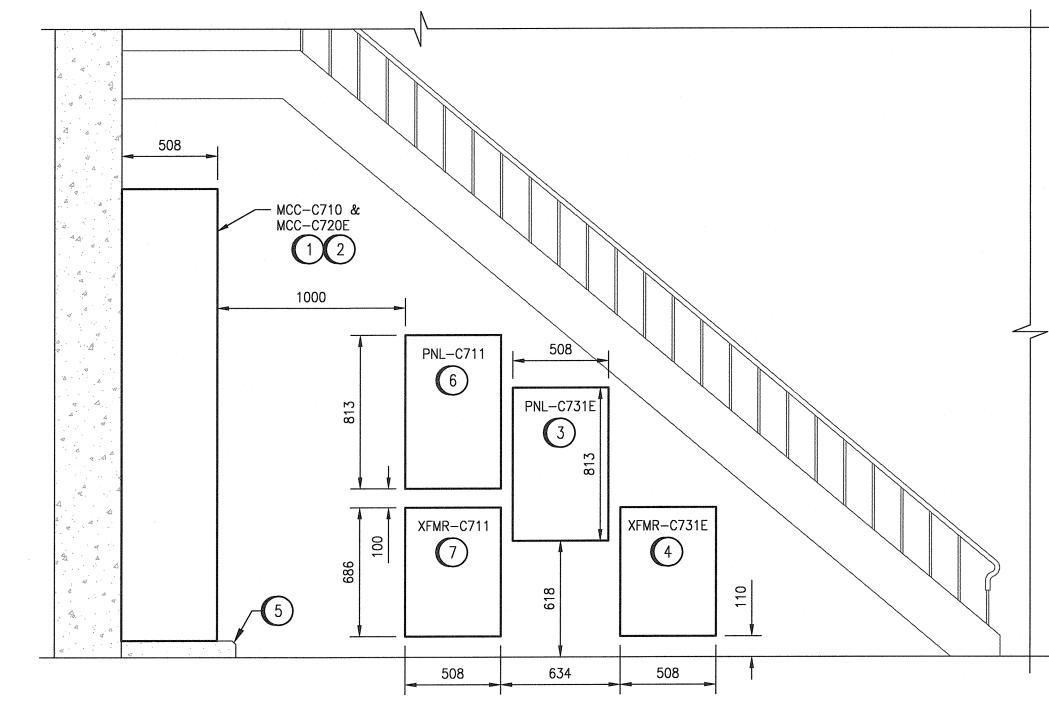

A WEST WALL ELEVATION

SCALE: 1: 20

B NORTH WALL ELEVATION

SCALE: 1: 20

CHLORINE BUILDING — ELECTRICAL PARTIAL PLAN LAYOUT (AT GALLERY LEVEL)

SCALE: 1: 20

ELECTRICAL - HAZARDOUS LOCATION, CHLORINE BLDG GROUND LEVEL

REFERENCE DRAWINGS

PLAN & SECTION, TYPICAL HOUSEKEEPING PAD DETAILS

PANELBOARD SCHEDULES PNL-C711 AND PNL-C731E

ELECTRICAL SINGLE LINE DIAGRAM MCC-C710/MCC-C720E

ELECTRICAL EQUIPMENT PLAN, CHLORINE BUILDING

NOTES:

- THIS DRAWING SUPERCEDES PART OF DRAWING Q-MCP-186.
 SPACE FOR NEW EQUIPMENT IS LIMITED. ENSURE EQUIPMENT PROVIDED FITS IN AVAILABLE
- SPACE AND MEETS APPLICABLE CODES AND STANDARDS.

 3. ALL EQUIPMENT ARE NEW UNLESS SPECIFICALLY STATED OTHERWISE.

3. ALL EQUIPMENT ARE NEW UNLESS SPECIFICALLY STATED OTHERWISE.

WHOLE NUMBERS INDICATE MILLIMETRES DECIMALIZED NUMBERS INDICATE METRES

0.0 0.2 0.4 0.8 1.2


1:20

Certificate of Authorization
SNC-Lavalin Inc.
No. 4489

NO. REVISIONS

| | | | | | () | SNC-LAVALIN INC. | ENGINEER | |
|--|----|------------------------------------|------------|----|-----------|------------------------------|--|---------|
| | | | | | | SNC+LAVALIN | Winnipeg, MB, Canada R3P 0X7 204-786-8080 | |
| | | | | | | DESIGNED BY: S. BOGHOSIAN | CHECKED BY: K. SAPIAK | |
| | | | | | | DRAWN BY: S. BOGHOSIAN | APPROVED BY: D. BECKER | RUCTION |
| | | | | · | | AS SHOWN BY: A. W | ISSUED FOR CONSTRUCTION BY: A. WEISS | |
| | | | | | | DATE: 2019/01/18 | DATE: 2019/10/18 | 001.18 |
| | 00 | ISSUED FOR TENDER AND CONSTRUCTION | 2019/10/18 | SB | KS | CONSULTANT NO.: | | 2019 |

DATE DESIGN CHECK

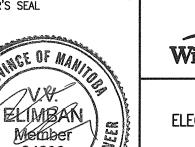

Winnipeg THE CITY OF WINNIPEG WATER AND WASTE DEPARTMENT

MCPHILLIPS PUMPING STATION
ELECTRICAL AND HVAC UPGRADES, MCC REPLACEMENT
ELECTRICAL PANEL LAYOUT
CHLORINE BUILDING

MCC-C710/MCC-C720E LOCATION PLAN - GALLERY LEVEL

CITY DRAWING NUMBER | SHEET | REV. | SIZE

1-0640C-E0005 | SHEET | REV. | SIZ

10C-E0005-001-0