GROUNDING LAYOUT MAIN FLOOR

DRAWING NUMBER


ELECTRICAL SINGLE LINE DIAGRAM, MCC-M730E

ELECTRICAL SINGLE LINE DIAGRAM, MCC-M720

ELECTRICAL SINGLE LINE DIAGRAM, MCC-M710

ELECTRICAL SINGLE LINE DIAGRAM, 4160V DISTRIBUTION

REFERENCE DRAWINGS

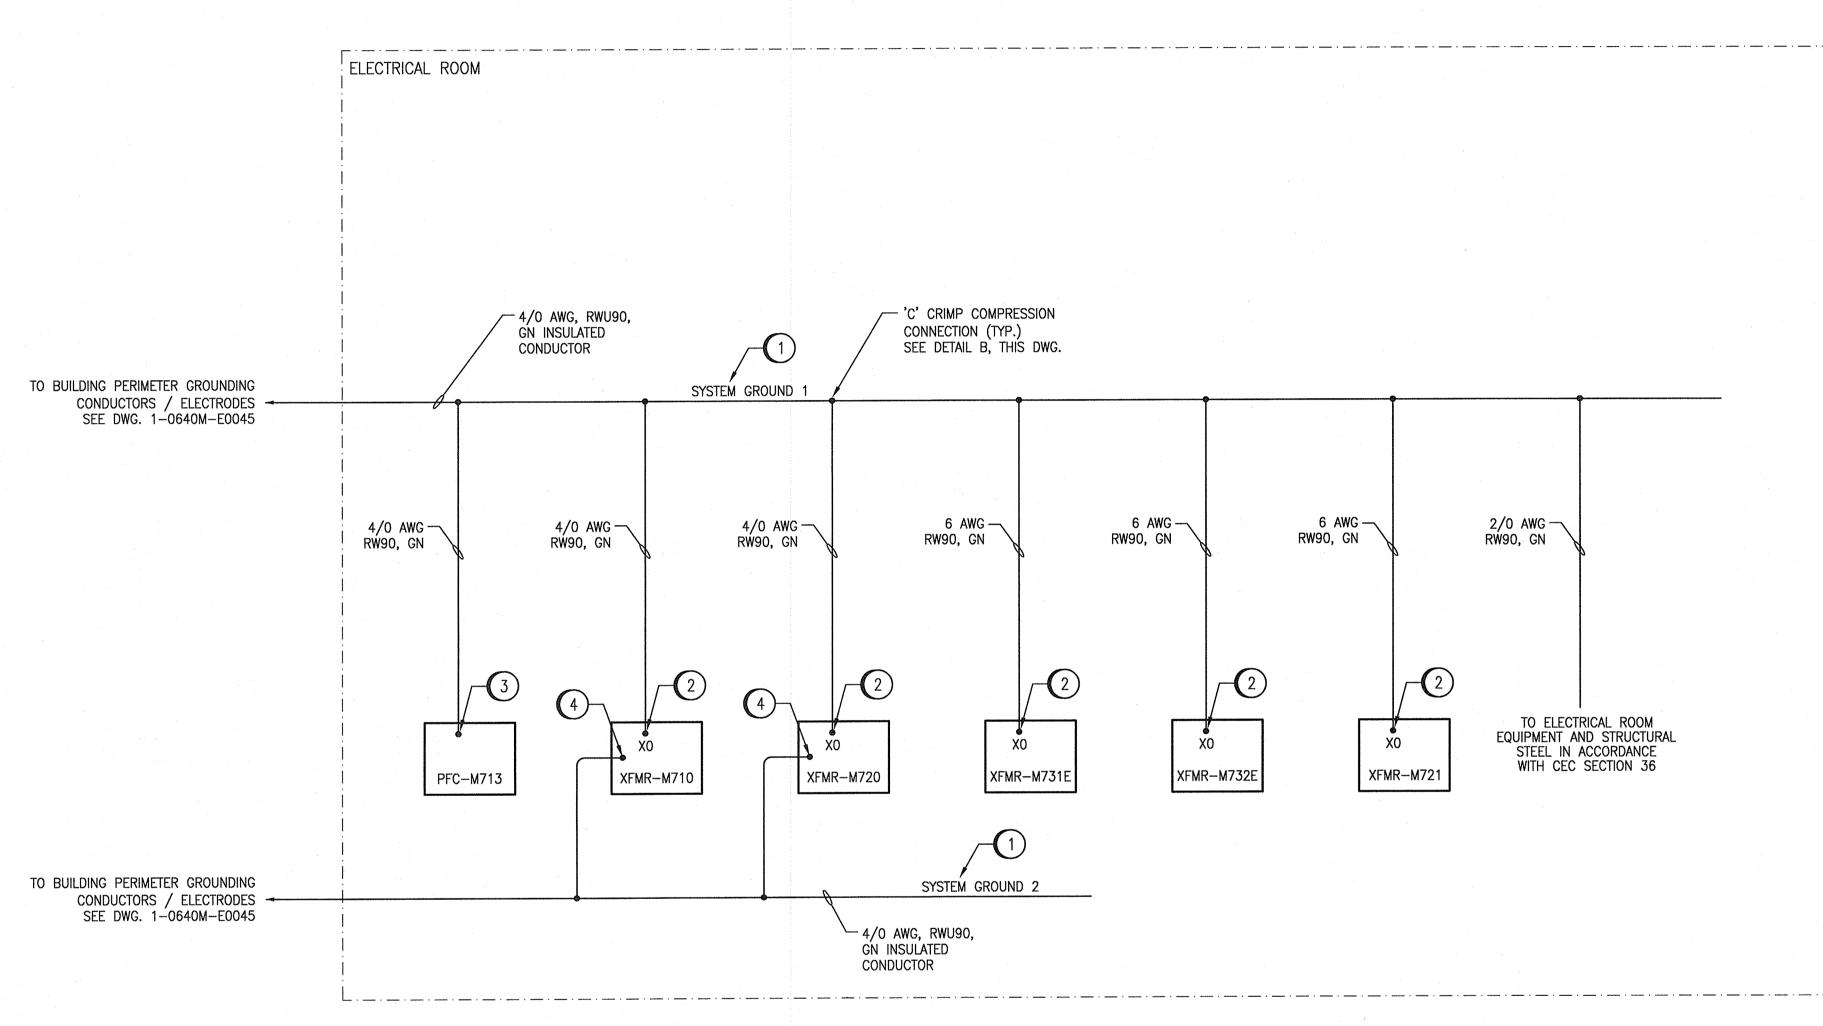


EQUIPMENT GROUNDING CONNECTION SCALE: NTS

GENERAL NOTES:

- 1. CONNECTIONS TO PERIMETER GROUNDING CONDUCTORS SHALL BE 'C' CRIMP PRESSURE CONNECTION OR EXOTHERMIC WELD. ALL COMPRESSION CONNECTIONS SHALL UTILIZE PENETROX JOINT COMPOUND.
- 2. ALL GROUNDING CONDUCTOR SHALL BE STRANDED, SOFT DRAWN COPPER, UNLESS
- (01) 4. ALL WIRES/CABLES SHALL BE RUN IN CONDUIT. SIZE CONDUITS IN ACCORDANCE WITH
- 5. NOT ALL BOND CONNECTIONS ARE SHOWN AS A MINIMUM PERFORM BONDING IN ACCORDANCE WITH CEC.

CONSTRUCTION NOTES:


- PROVIDE LAMACOID TAG ON WALL, ABOVE THE GROUND CONDUCTORS INDICATING "SYSTEM GROUND" AS APPLICABLE.
- 2 PROVIDE GROUND CONNECTION FROM SYSTEM GROUND TO TRANSFORMER XO TERMINAL.
- PROVIDE GROUND CONNECTION TO POWER FACTOR CORRECTION UNIT, PFC-M713, AS PER MANUFACTURER'S REQUIREMENTS.
- PROVIDE A GROUND CONNECTION TO THE TRANSFORMER ENCLOSURE SEPARATE FROM XO TERMINAL CONNECTION.

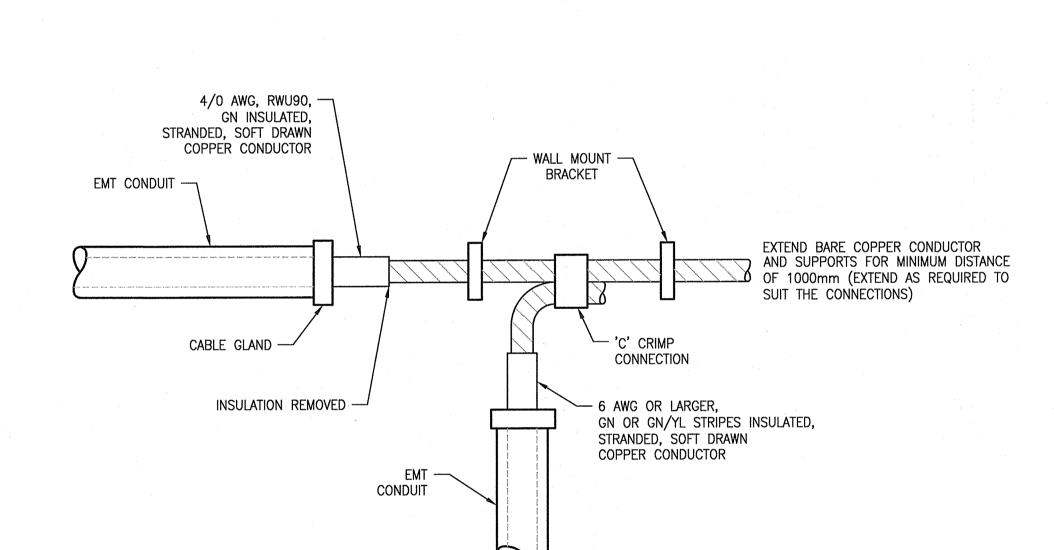

GROUND CONNECTION POINT DETAIL (TYP). SCALE: NTS



				*))	SNC-LAVALIN INC. 148 Nature Park Way	ENGINEER'S SEAL	
					SNC·LAVALIN		STATISTICE OF
					DESIGNED BY: S. JUGANAS	CHECKED BY: K. SAPIAK	I STATE
					DRAWN BY: S. JUGANAS	APPROVED BY: D. BECKER	Mem 346
					SCALE: NTS	ISSUED FOR CONSTRUCTION BY: A. WEISS	Mem 346:
01	ISSUED FOR ADDENDUM 5	2020/01/27	VE	VE	DATE: 2019/04/23	DATE: 2019/10/18	Jan 27/2020
00	ISSUED FOR TENDER AND CONSTRUCTION	2019/10/18	SLJ	KS	CONSULTANT NO.:		1
NO.	REVISIONS	DATE	DESIGN	CHECK			

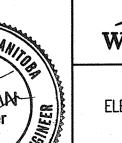

THE CITY OF WINNIPEG WATER AND WASTE DEPARTMENT

MCPHILLIPS WATER PUMPING STATION ELECTRICAL AND HVAC UPGRADES, MCC REPLACEMENT ELECTRICAL GROUNDING RISER DIAGRAM

CITY DRAWING NUMBER -0640M-E0044

1-0640M-E0044-001-01.dwg