


1 MAIN FLOOR PLAN - NEW CONSTRUCTION - HYDRONICS
SCALE: 1/16" = 1'-0"

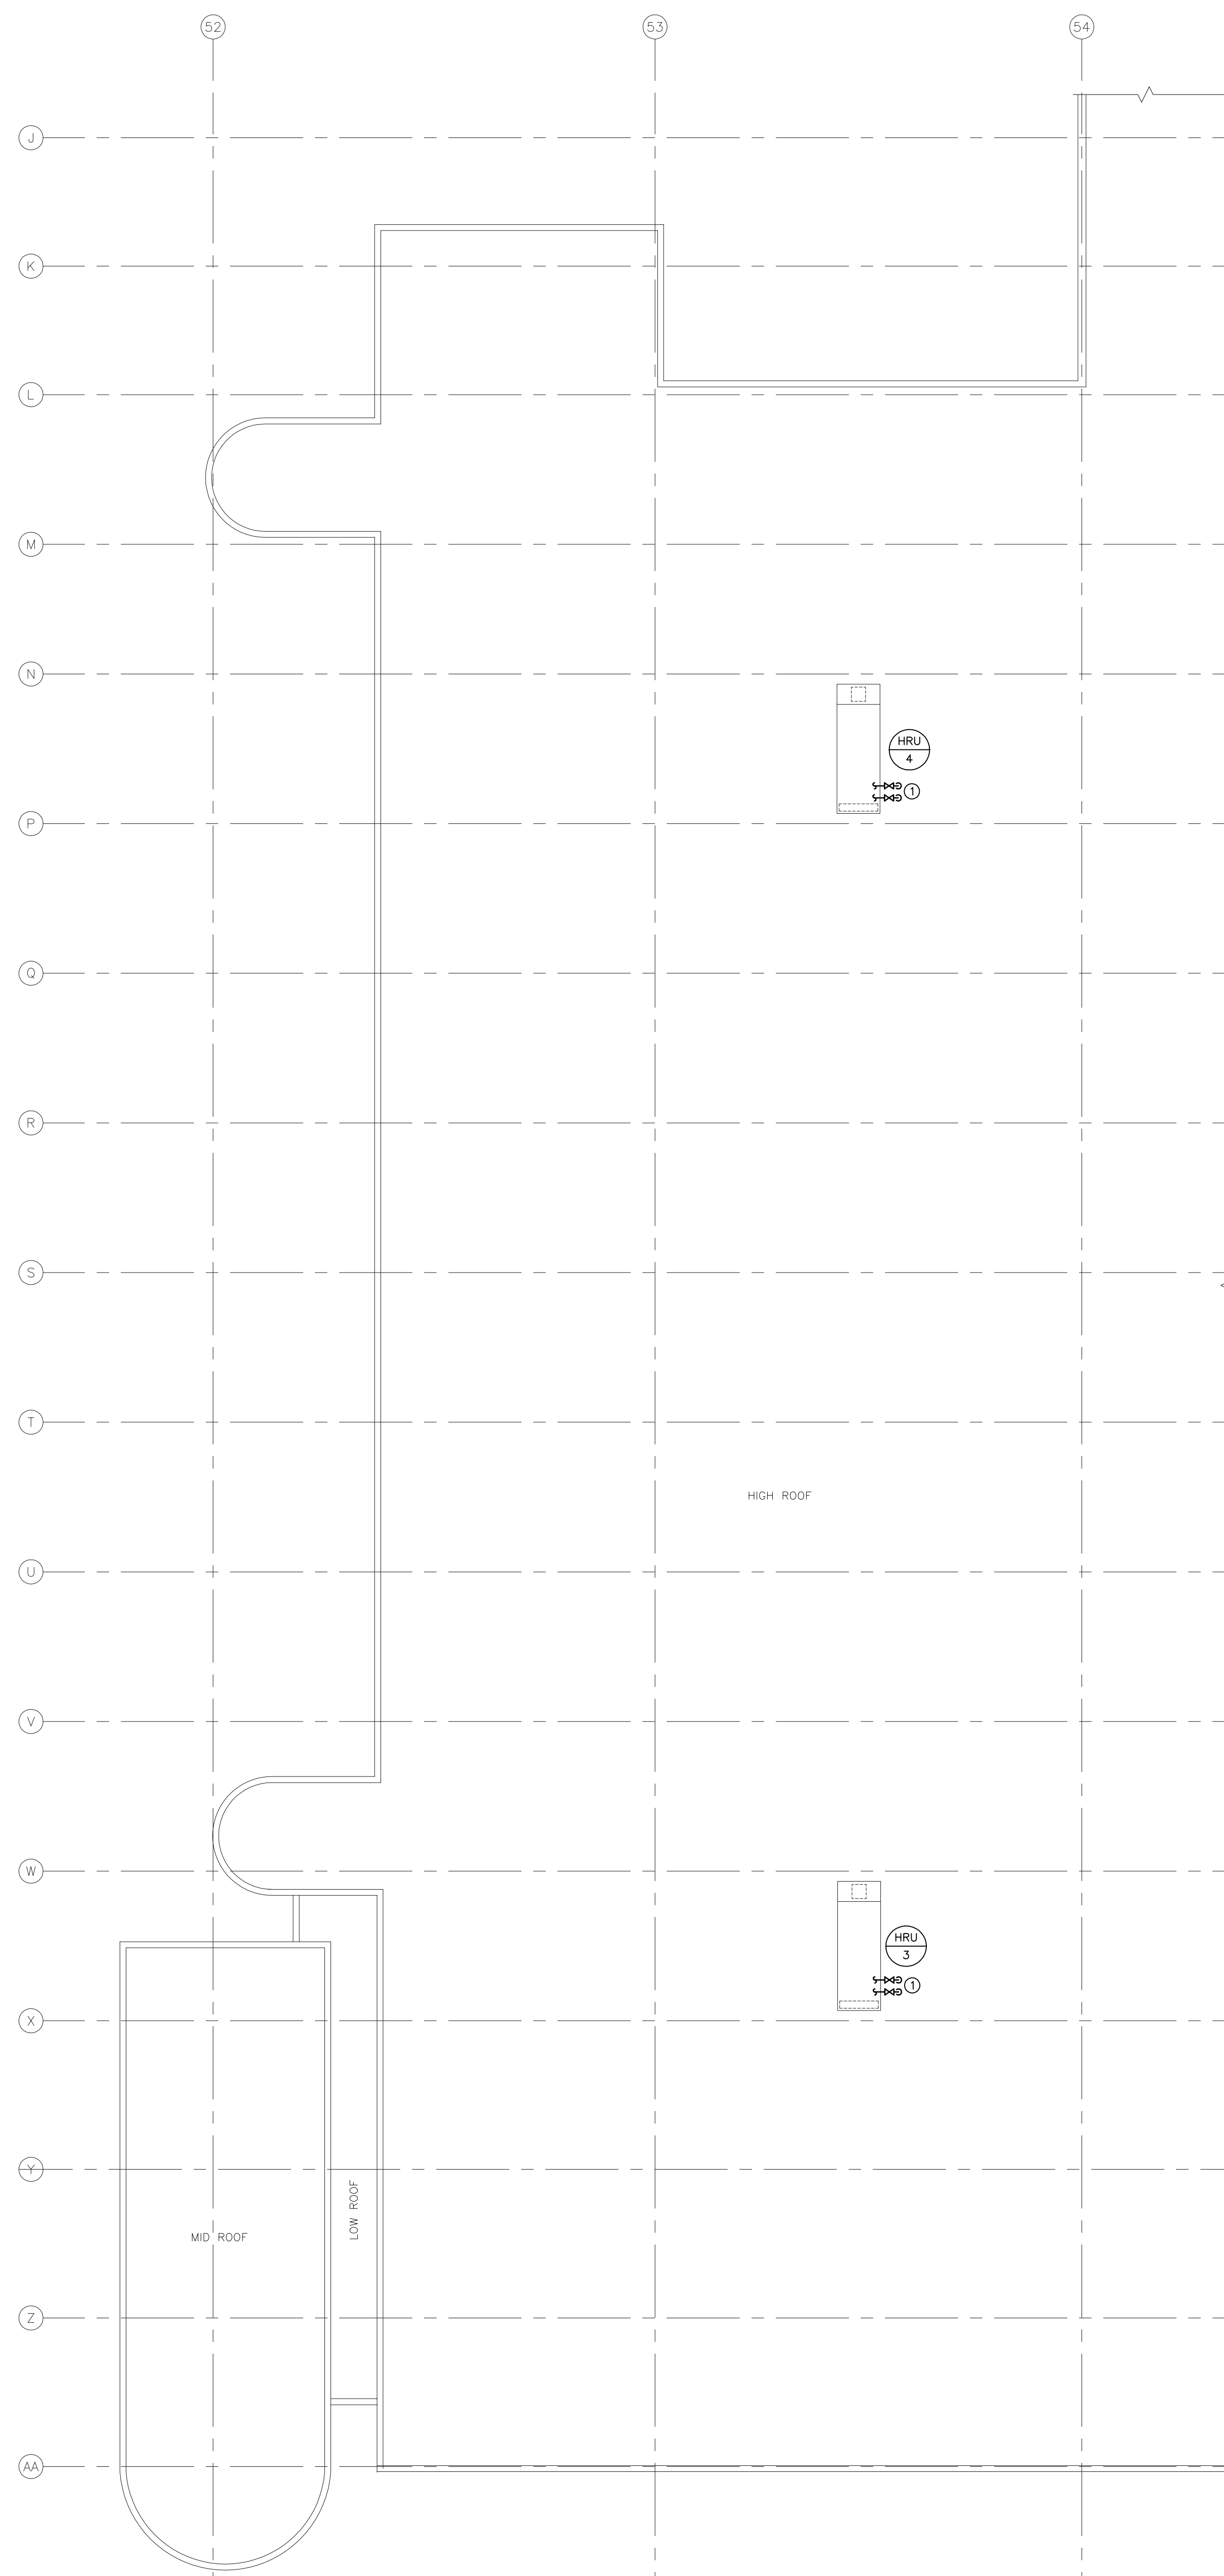


2 ROOF PLAN - NEW CONSTRUCTION - HYDRONICS
SCALE: 1/16" = 1'-0"

GENERAL NOTES

- A. REFER TO SCOPE OF WORK DESCRIPTION IN FRONT END SPECIFICATIONS FOR SEQUENCING.
- B. ALL ABANDONED EQUIPMENT AND SERVICES WITHIN AREA OF WORK SHALL BE REMOVED.
- C. THIS BUILDING MAY CONTAIN ASBESTOS. REFER TO FRONT END SPECIFICATIONS FOR FURTHER INFORMATION.



KEYNOTES

- 1. CONNECT GHS AND GHR TO NEW HRU-3 & 4 ON ROOF.
- 2. CO/NOX CONTROLLER BESIDE FIRE ALARM PANEL. REFER TO M5.2, DETAIL 1 FOR LOCATION OF INTERFACE.
- 3. CO/NOX DETECTORS.
- 4. EXISTING JCI METASYS CONTROL PANEL/AUTOMATION ENGINE.
- 5. CO/NOX DETECTORS C/W WEATHER PROOF ENCLOSURE NEAR WASHBAY.
- 6. HEAT RECOVERY UNIT, HRU-3/4, THERMOSTATS.

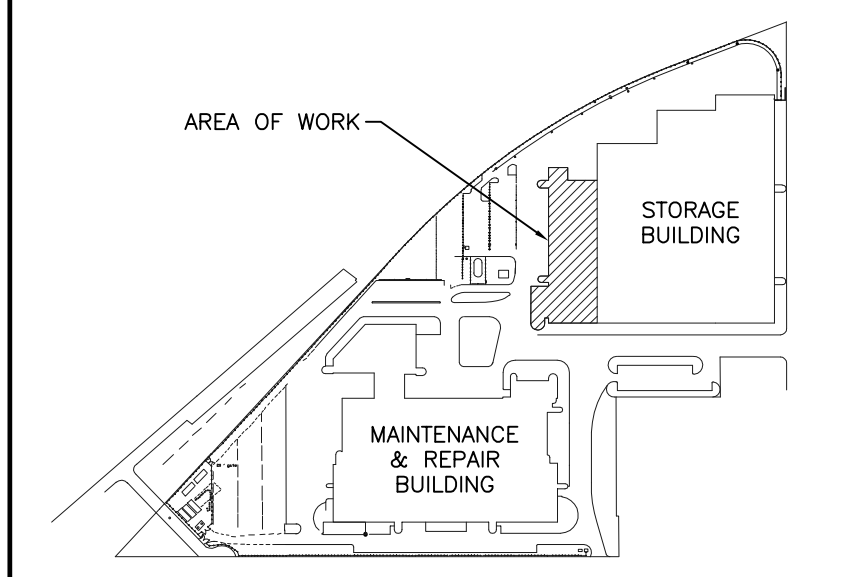

KEY PLAN
NTS

6			
5			
4			
3			
2			
1	ISSUED FOR ADDENDUM 2	JH	20/11/15
0	ISSUED FOR CONSTRUCTION	JH	27/10/15
NO.	Description	BY	DD/MM/YY

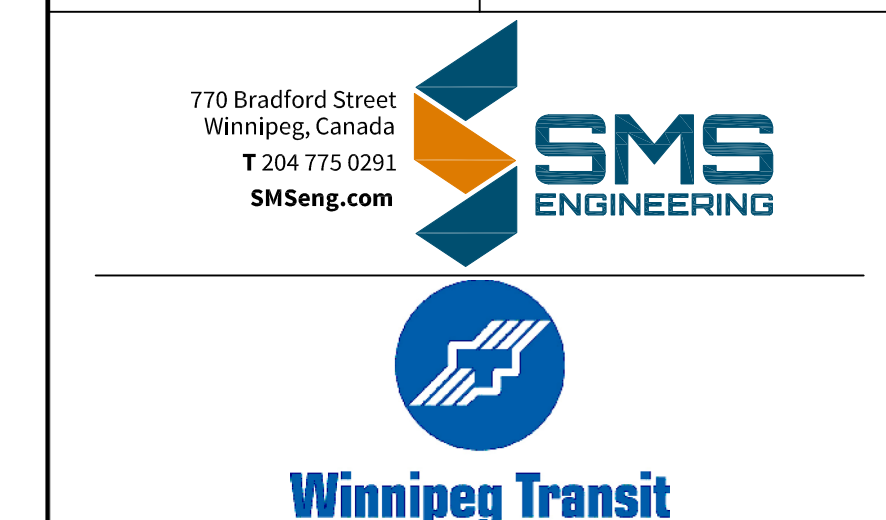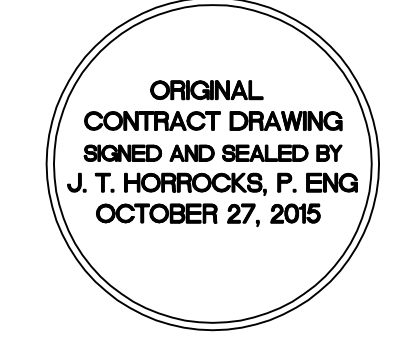

Project Title
**CITY OF WINNIPEG FORT ROUGE
TRANSIT BASE - SERVICE BAY AND
B-SECTION VENTILATION UPGRADE**
WINNIPEG MANITOBA

Drawing Title
**MAIN FLOOR AND ROOF PLAN -
NEW CONSTRUCTION -
HYDRONICS**

Drawn By GB/IE	Checked By JH	Approved By JH
Scale AS SHOWN	Date JULY 2014	Project No. 14-194-01
Revision Number 1	Drawing Number M5.1	Sheet Order 9 OF 11