

TYPICAL TENSION CRACK SEALING DETAIL SCALE: 1:30 METRIC

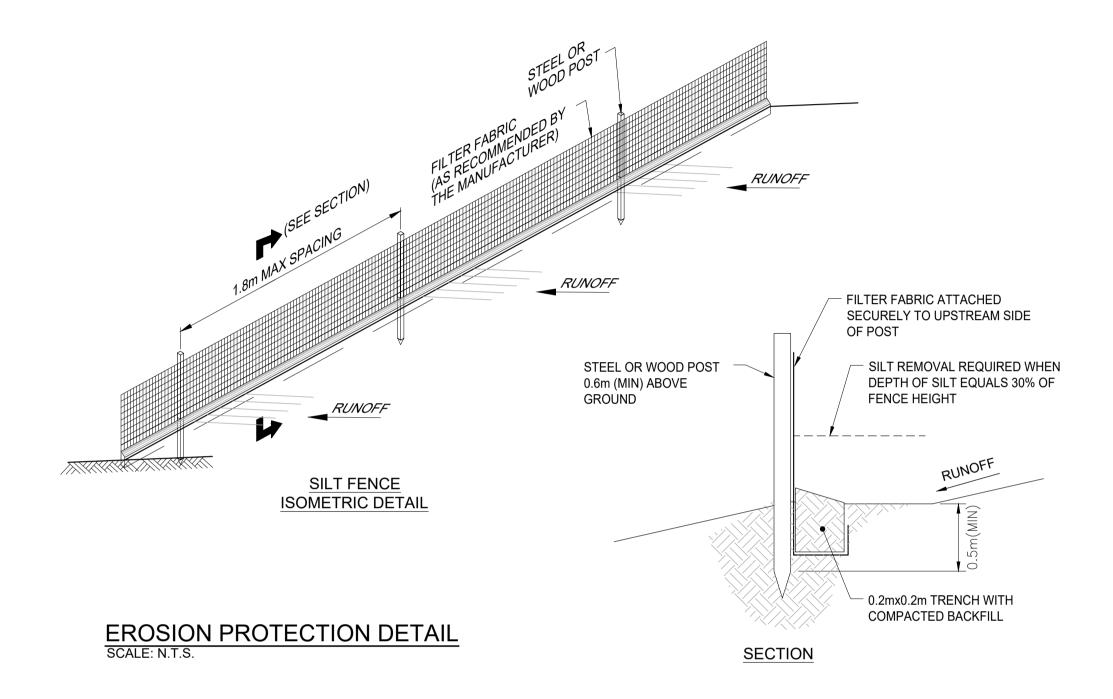

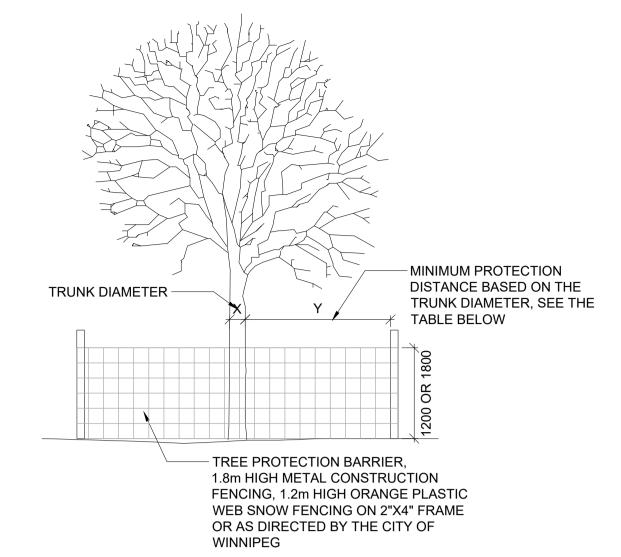

TREE PROTECTION ZONES		
X= TRUNK DIAMETER	Y= MINIMUM PROTECTION DISTANCE REQUIRED	
<10CM	2.0m	
11-40CM	2.4m	
41-50CM	3.0m	
51-60CM	3.6m	
61-70CM	4.2m	
71-80CM	4.8m	
81-90CM	5.4m	
91-100CM+	6.0m	

TRUNK DIAMETER ARE MEASURED AT BREAST HEIGHT AT 1.4 METRES ABOVE GROUND

TREE PROTECTION ZONE DISTANCES ARE TO BE MEASURED FROM THE OUTSIDE EDGE OF THE TREE BASE TOWARDS THE DRIP LINE.

STRAP MATURE TREE TRUNKS WITH 25 X150 X 2400 WOOD PLANKS. SMALLER TREES SHALL BE SIMILARLY PROTECTED USING APPROPRIATE SIZED WOOD PLANKS.

DO NOT STOCKPILE MATERIALS AND SOIL OR PARK VEHICLES AND EQUIPMENT ON BOULEVARDS WITHIN 2.0 METRES OF TREES. EXCAVATIONS SHALL BE CARRIED OUT IN A MANNER TO MINIMIZE DAMAGE TO EXISTING ROOT SYSTEM. WHERE ROOTS MUST BE CUT TO FACILITATE AN EXCAVATION THEY SHALL BE NEATLY PRUNE AT THE FACE OF THE EXCAVATION.

WORK ON SITE SHALL BE CARRIED OUT IN A MANNER TO MINIMIZE DAMAGE TO EXISTING TREE BRANCHES. WHERE DAMAGE TO TREE BRANCHES DOES OCCUR, THE CONTRACTOR SHALL NEATLY PRUNE THE DAMAGED BRANCH.


CITY OF WINNIPEG TREE PROTECTION STANDARDS SCALE: 1:50




TYPICAL STEEL FENCING PROTECTION

NOTES:

- 1. LOCATION AND EXTENT OF EROSION PROTECTION MEASURES TO BE DETERMINED IN THE FIELD BY THE CONTRACT ADMINISTRATOR.
- 2. STRAW WATTLE INSTALLATION REQUIRES PLACEMENT AND SECURE STAKING OF THE ROLL IN A TRENCH, 3"-5" (75-125MM) DEEP, DUG ON CONTOUR. RUNOFF NOT ALLOWED TO RUN UNDER OR AROUND ROLL.
- 3. OPERATION OF EQUIPMENT WITHIN THE DRIPLINE OF THE TREES SHALL BE KEPT TO THE MINIMUM REQUIRED TO PERFORM THE WORK REQUIRED. EQUIPMENT SHALL NOT BE PARKED, REPAIRED, REFUELLED; CONSTRUCTION MATERIALS SHALL NOT BE STORED, AND EARTH MATERIALS SHALL NOT BE STOCKPILED WITHIN THE DRIPLINES OF TREES.EXCAVATION SHALL BE PERFORMED IN A MANNER THAT MINIMIZES DAMAGE TO THE EXISTING ROOT SYSTEMS. WHERE ROOTS MUST BE CUT TO FACILITATE EXCAVATION, THEY SHALL BE PRUNED NEATLY AT THE FACE OF EXCAVATION. THEY MUST BE PROPERLY TRIMMED WITH SHARP TOOLS TO PREVENT CRUSHING OR BEING PULLED BY CONSTRUCTION EQUIPMENT.
- 4. EROSION MEASURES TO REMAIN IN PLACE UNTIL VEGETATION IS WELL ESTABLISHED.

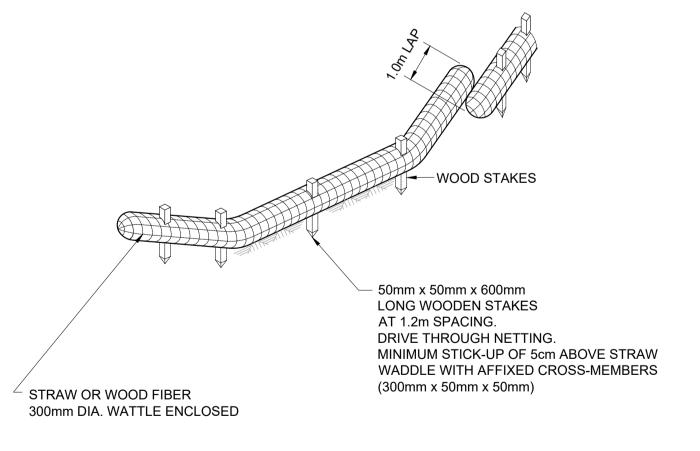

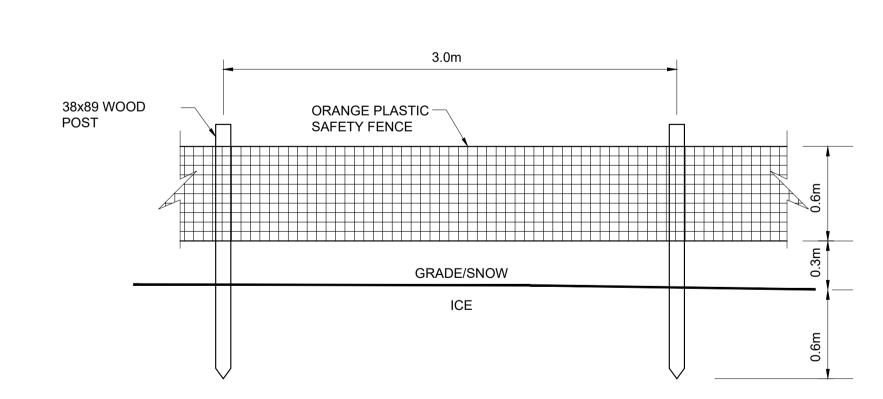

SAFETY AND ICE FENCE DETAIL



SAFETY FENCE DETAIL

WHOLE NUMBERS INDICATE MILLIMETRES DECIMALIZED NUMBERS INDICATE METRES

METRIC

PROPERTY LIMITS DELINEATION

DELINEATION OF PROPERTY LIMITS AS SHOWN ON THIS DWG DOES NOT REPRESENT A "LEGAL SURVEY". KGS GROUP MAKES NO REPRESENTATION OR WARRANTY AS TO THE ACCURACY OF PROPERTY LIMITS DELINEATED ON THIS DWG, NOR ON THE

DIMENSIONAL ACCURACY OF DWG FEATURES RELATIVE TO THOSE PROPERTY LIMITS.

WARNING

NOTIFY THE GAS COMPANY OF THE PROPOSED LOCATION OF EXCAVATION.

TAKE PRECAUTION TO AVOID DAMAGE TO GAS COMPANY INSTALLATIONS.

. SEE PROVINCIAL REGULATION 210/72 FOR DETAILS.

SU	ED FOR TEND	ER
	ENGINEER'S SEAL	

PROJECT TITLE

THE CITY OF WINNIPEG PUBLIC WORKS DEPARTMENT ENGINEERING DIVISION

ST. MARY'S ROAD RIVERBANK STAB **IMPROVEMENT W**

ENGINEERS
GEOSCIENTISTS

Certificate of Authorization

KGS Group

No. 245

MANITOBA

COMPUTER FILE NAME 22-0107-010_GE-07

SHEET OF

SILITY ORK	
ASURES	

EROSION CONTROL MEA

CITY DRAWING NUMBER RW753-22-07

300 LDS LAND DRAINAGE SEWER 300 LDS **FENCE** WASTE WATER SEWER 250 WWS 250 WWS **TEST HOLE** GAS **GUY WIRE** HYDRO LIGHT STANDARD •-• ____ M.T.S. BACK OF CURB **C** PROFILE WATERMAIN 150 WM 150 WM CONCRETE **HYDRANT ASPHALT** EDGE OF ALLEY LHS EDGE OF ALLEY RHS VALVE **SIDEWALK** \otimes \otimes MANHOLE PROPERTY LINE N/W LANE PL ____ **CATCH BASIN SURVEY BAR** -S/E MEDIAN P L **CURB INLET** GEODETIC BENCHMARK GARAGE/PARKING SLAB \triangle POLES T-MTS H-HYDRO 231.33 232.231 **ELEVATION** WINDOW/DOOR SILL •

LEGEND-PLAN

PROPOSED

EXISTING

LEGEND-PROFILE

TYPICAL STRAW WATTLE

EXISTING

SCALE: N.T.S.

PROPOSED

EXISTING

LEGEND-PLAN

UNDERGROUND STRUCTURES SUPV. U/G STRUCTURES DATE COMMITTEE LOCATION OF UNDERGROUND STRUCTURES AS SHOWN ARE BASED ON THE BEST INFORMATION AVAILABLE BUT NO GUARANTEE IS GIVEN THAT ALL EXISTING UTILITIES ARE SHOWN OR THAT THE GIVEN LOCATIONS ARE EXACT. CONFIRMATION OF EXISTENCE AND EXACT LOCATION OF ALL SERVICES MUST BE OBTAINED FROM THE INDIVIDUAL UTILITIES BEFORE PROCEEDING WITH CONSTRUCTION. PROPOSED

LOCATION APPROVED

DESIGNED CR DRAWN HOR. SCALE: AS NOTED VERTICAL ISSUED FOR TENDER 22/12/08 BPA NO. REVISIONS DATE BY DATE

RELEASED FOR CONSTRUCTION: 2022-12-08 DATE

KGS

CHECKED

APPROVED

CONSULTANT DRAWING NO. GE-07