

1 TYPICAL ROOF RECEPTACLE AND DISCONNECT MOUNTING DETAIL SCALE: NTS




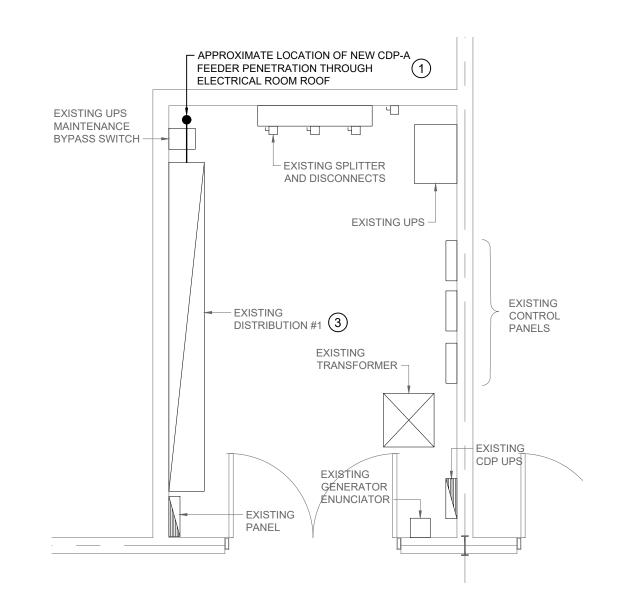


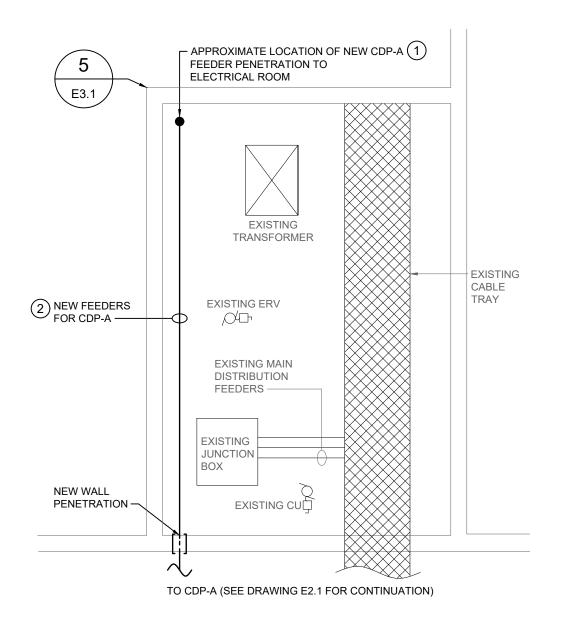

4 LARGE SCALE ELECTRICAL ROOM ROOF


SCALE: 1/4" = 1'-0"

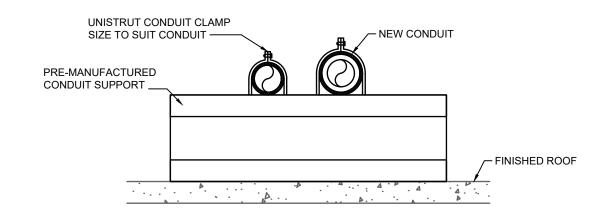

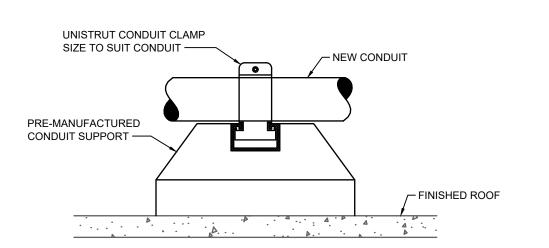

2 TYPICAL ROOF CONDUIT SUPPORT DETAIL

SCALE: NTS

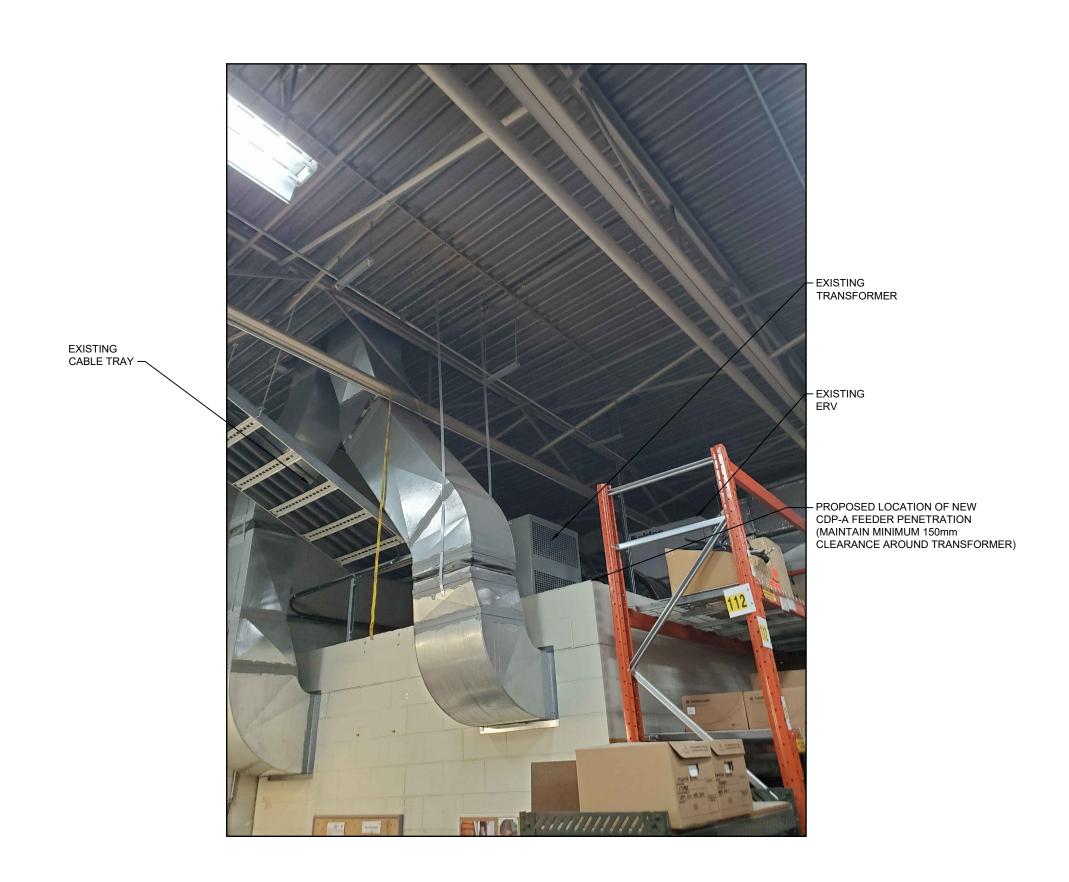

5 EXISTING ELECTRICAL ROOM ELEVATION
SCALE: NTS

GENERAL NOTES

- A. CONTRACTOR TO DETERMINE EXACT CABLE ROUTES ON SITE. WHERE POSSIBLE FOLLOW EXISTING CABLE ROUTES THROUGH BUILDING. RE-USE EXISTING OPENINGS AND PENETRATIONS TO ROUTE CABLES. PROVIDE NEW PENETRATIONS WHERE EXISTING CANNOT BE RE-USED. SEAL ALL PENETRATIONS.
- B. DRAWINGS SHOW ONLY A GENERAL SCHEMATIC OF NEW AND SOME EXISTING SYSTEMS. ROUTING CONDUITS AND/OR CABLES AND LOCATIONS SHALL SUIT SITE CONDITIONS AND MAY HAVE TO BE CHANGED TO AVOID CONFLICT WITH EXISTING STRUCTURE AND SERVICES. WHEN A CONFLICT CANNOT BE AVOIDED, THE EXISTING SERVICES SHALL BE MODIFIED AS REQUIRED.
- C. SEAL ALL PENETRATIONS THROUGH FIRE RATED WALLS WITH FIRE STOP MATERIAL AS REQUIRED TO MAINTAIN ASSEMBLY RATING.

KEY NOTES ⊕

- 1. NEW CDP-A FEEDERS FROM DISTRIBUTION #1 TO RISE UP TO ROOF OF ELECTRICAL ROOM IN APPROXIMATE LOCATION SHOWN. DETERMINE EXACT ROUTING/PENETRATION LOCATION ON SITE AND ADJUST ACCORDINGLY. DISCONNECT, RELOCATE AND RECONNECT EXISTING CABLES, CONDUIT, EQUIPMENT, ETC. AS REQUIRED TO ROUTE NEW FEEDERS. FIRE STOP/SEAL ALL PENETRATIONS.
- 2. CONTRACTOR TO DETERMINE EXACT FEEDER ROUTE ON SITE. ROUTE FEEDERS ALONG/ ABOVE ROOF OF ELECTRICAL ROOM TO SERVICE AREA. ENSURE CLEARANCES ARE MAINTAINED INFRONT OF EXISTING TRANSFORMER. PROVIDE ADDITIONAL RACKING, SUPPORTS, ETC. COORDINATE EXACT PENETRATION/SLEEVE LOCATIONS ON SITE. UTILIZE NEW CABLE TRAY ON THE SERVICE AREA SIDE OF WALL TO ROUTE CABLES TO CDP-A. FIRE STOP/ SEAL ALL PENETRATIONS.
- 3. PROVIDE NEW 600A-3P LSI BREAKER C/W DIGITAL METER FOR CDP-A. BREAKER TO MATCH EXISTING IN ALL RESPECTS. TRIP SETTINGS SHALL BE ADJUSTED BASED ON COORDINATION STUDY.

4			
3			
2			
1			
0	ISSUED FOR CONSTRUCTION	AS	07/06/22
NO.	Description	BY	DD/MM/YY





MANITOBA

T70 Bradford Street Winnipeg, Canada (204) 775-0
20-349-01



Project Title

TRANSIT MAINTENANCE AND REPAIR BUILDING MECHANICAL UPGRADE - WEST HIGH BAY

ELECTRICAL DETAILS

WINNIPEG

Drawn By
WPD
CRM
AS
Scale
1/16"=1'-0"
Date
JUNE 2022
Project No.
20-349-01
Sheet Order

Barry CRM
AS

Project No.
20-349-01
Sheet Order

5 OF 6