



FILE NAME: 2015037MM0.dwg/M4
 DATE: 2016.08.25
 SHEET TITLE: MAIN FLOOR PLUMBING PLAN
 PROJECT No: 2015-037
 ADDRESS: 1777 BRADY ROAD

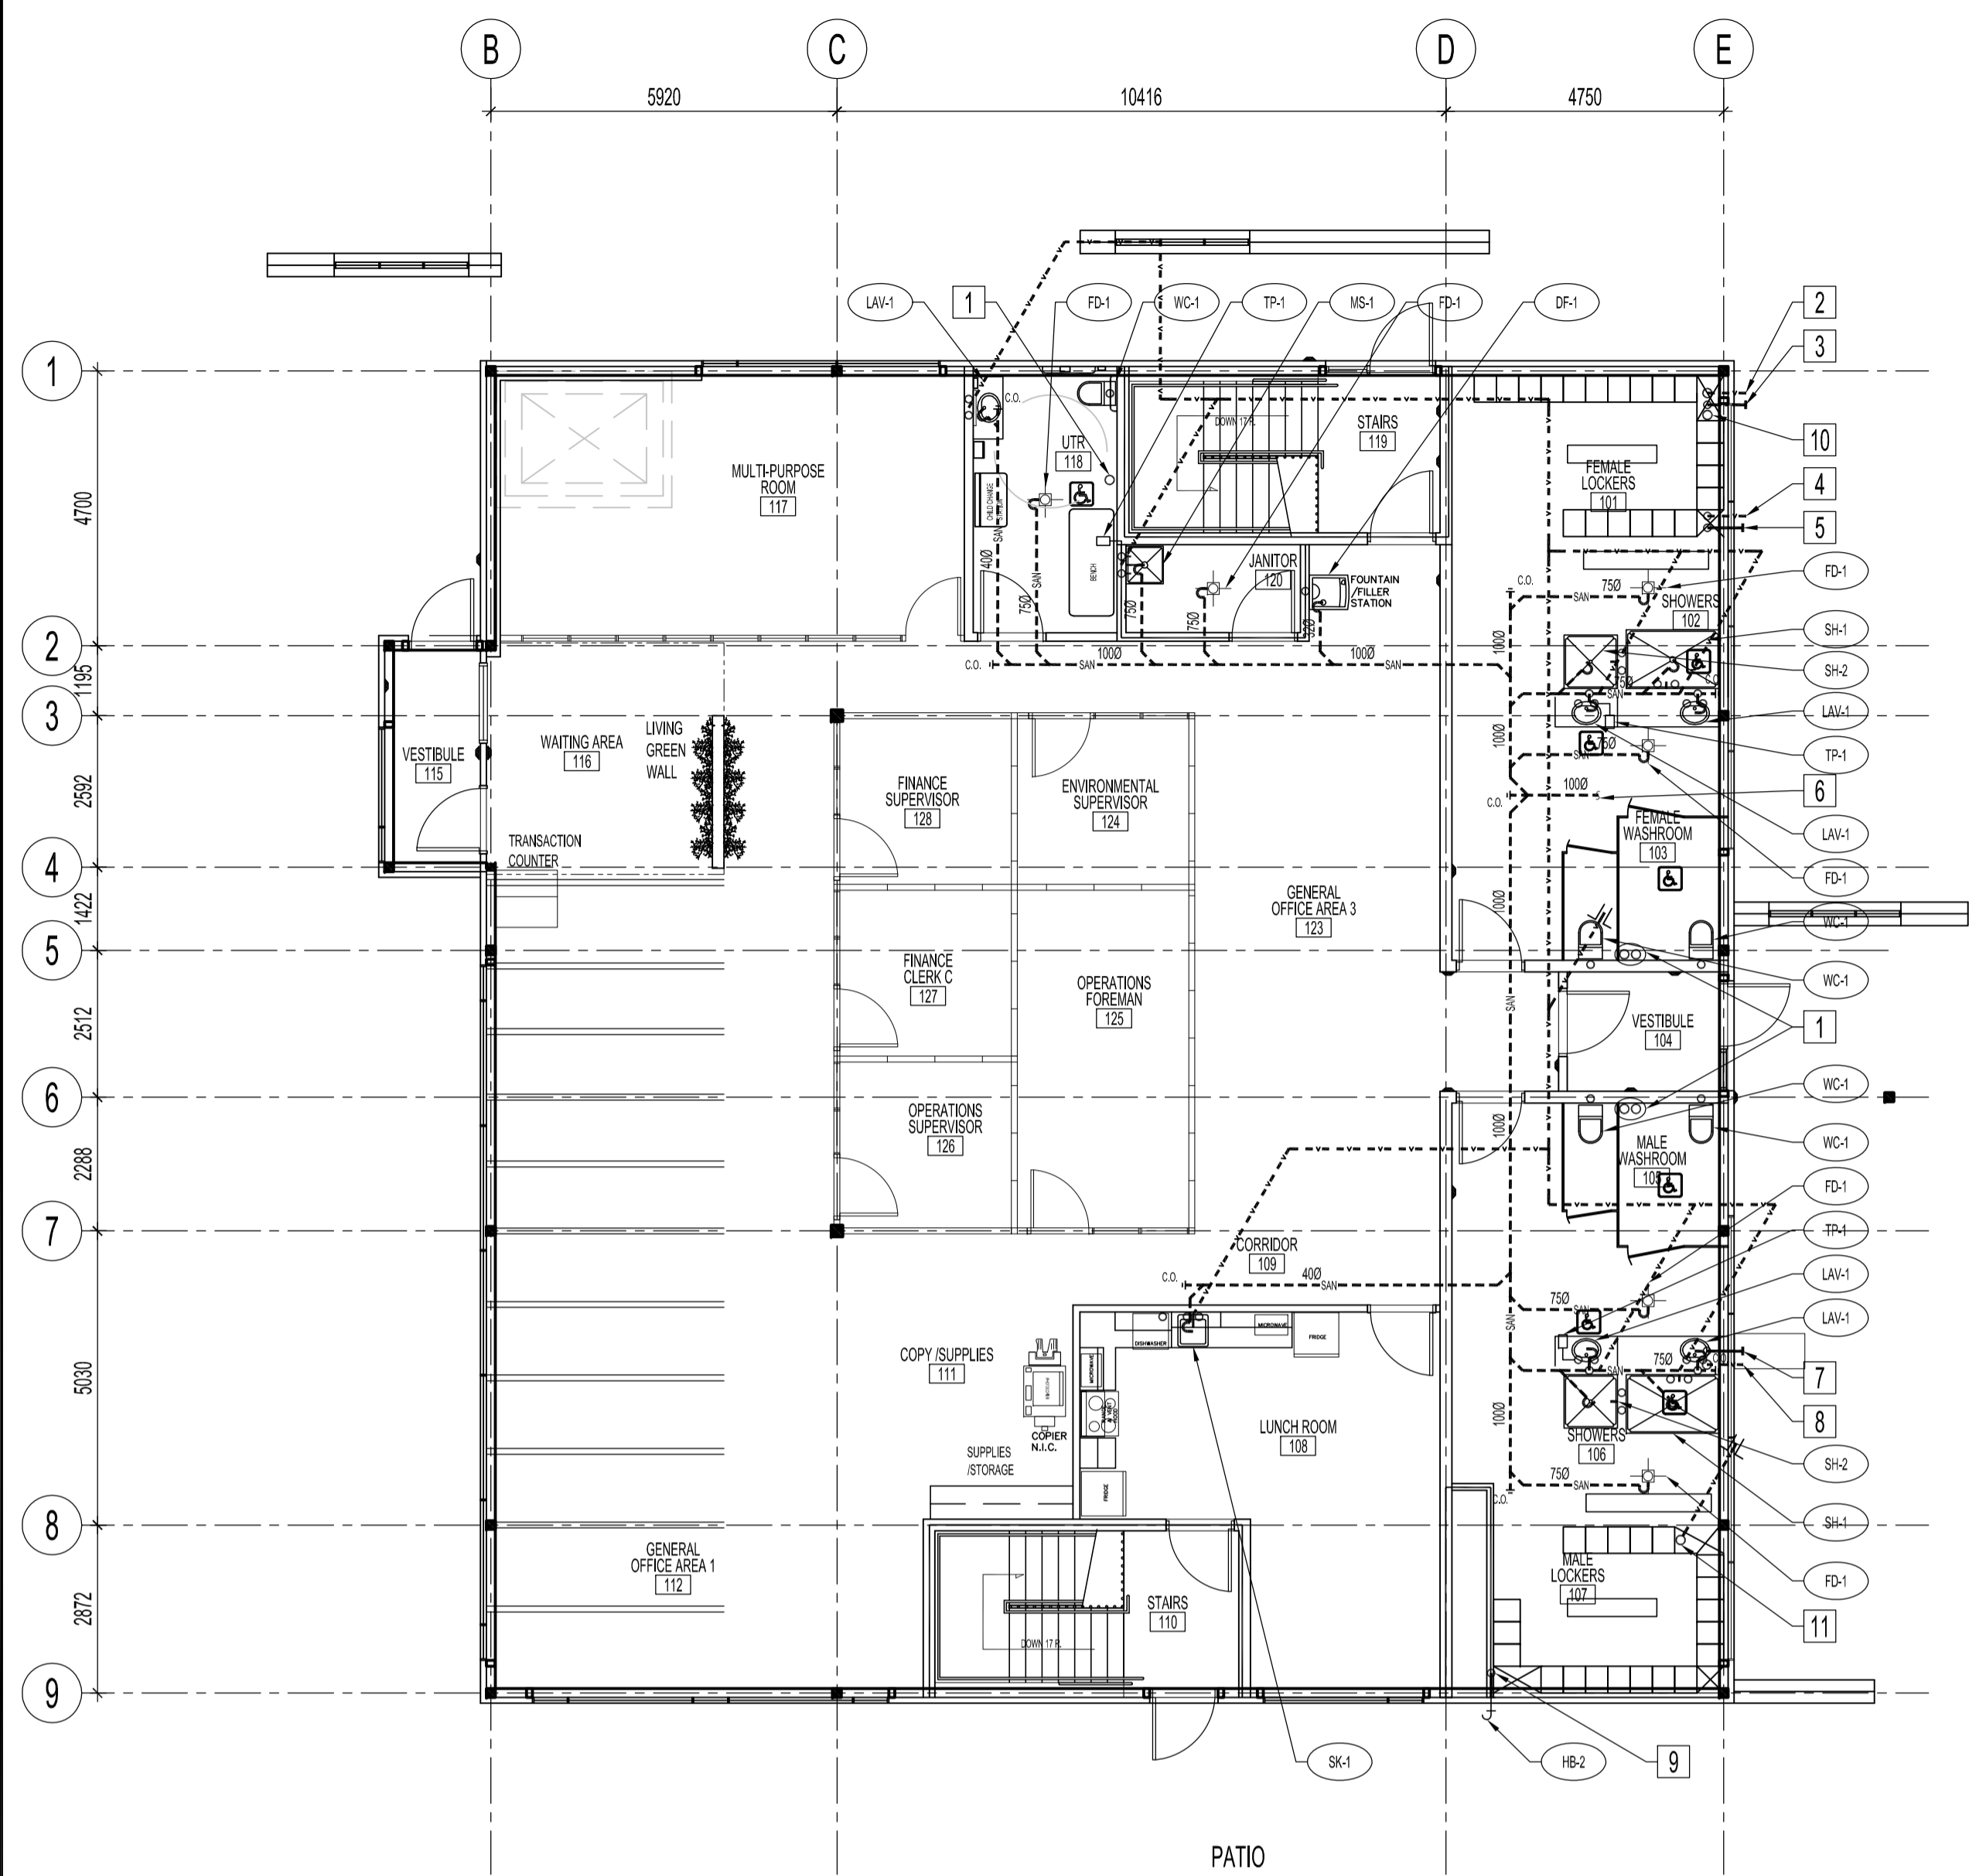


MAIN FLOOR PLUMBING NOTES:

- 1 100mm PVC COMPOSTER VENT PIPE UP TO ROOF C/W WIND TURBINE VENTILATOR (1000mm ABOVE ROOF). INSTALL AS PER MANUFACTURERS RECOMMENDATIONS.
- 2 75mm WT-1 OVERFLOW. TERMINATE WITH AN ELBOW - GRADE BACK TO DOMESTIC WATER TANK WT-1.
- 3 50mm POTABLE WATER FILL C/W CAM LOCK. GRADE BACK TO DOMESTIC WATER TANK WT-1.
- 4 75mm GREY WATER TANK VENT PIPE, TERMINATE WITH AN ELBOW.
- 5 75mm GREY WATER PUMP OUT - GRADE BACK TO GREY WATER TANK WT-2.
- 6 100mm SANITARY DRAIN TO GREY WATER TANK WT-2. REFER TO DRAWING M3 FOR CONTINUATION.
- 7 50mm WEEPING TILE SUMP PIT DISCHARGE TO SPLASHPAD ON GROUND.
- 8 100mm PVC RADON EXHAUST PIPE.
- 9 19mm DOMESTIC COLD WATER LINE UP FROM BASEMENT.
- 10 75mm POTABLE WATER TANK VENT UP INTO CEILING SPACE.
- 11 PLUMBING VENT FROM BASEMENT UP TO ROOF.

MAIN FLOOR PLUMBING PLAN
 SCALE 1:100

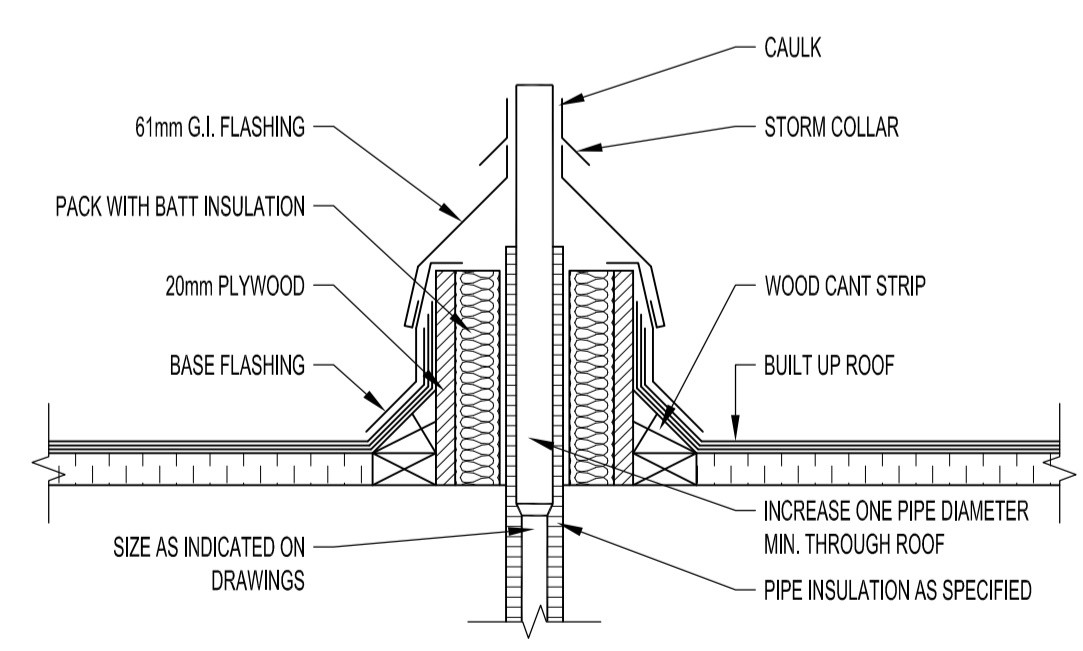


PLUMBING VENT THROUGH ROOF DETAIL
 NTS

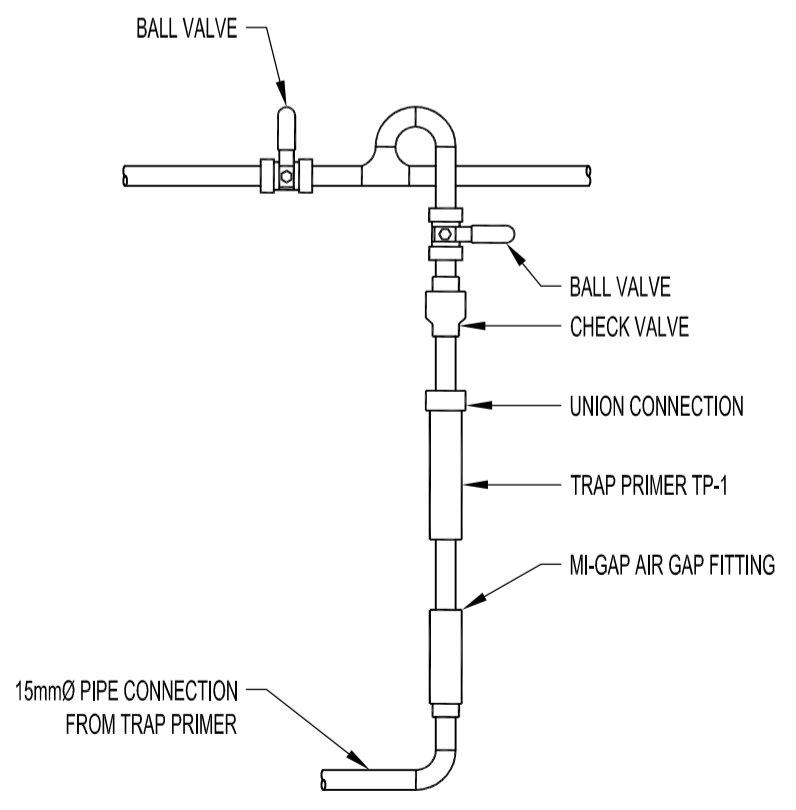

TRAP PRIMER DETAIL
 NTS

NOTES:
 THESE DRAWINGS SHALL NOT BE SCALED.
 THIS DRAWING IS DIAGRAMMATIC ONLY. CONTRACTOR TO COORDINATE EXACT LOCATIONS OF AND ROUTING ON SITE WITH ALL NEW SYSTEMS.
 THE CONTRACTOR SHALL VISIT THE SITE AND SATISFY ONESELF ALL DIMENSIONS, DATUM, AND DETAILED INFORMATION SHOWN ARE CORRECT.
 THE CONTRACTOR IS TO REVIEW AND COORDINATE ALL ARCHITECTURAL, MECHANICAL, ELECTRICAL AND STRUCTURAL DRAWINGS FOR ADDITIONAL OPENINGS THROUGH FLOORS, WALLS, AND CEILINGS FOR DUCT, PIPE & ELECTRICAL RISERS AND ALL OPENINGS NOT SHOWN ON DRAWINGS.
 ALL OPENINGS THROUGH FIRE ASSEMBLIES ARE TO BE FIRE STOPPED AND SEALED WITH ULC APPROVED FIRE STOPPING TO MAINTAIN THE INTEGRITY OF THE FIRE SEPARATION, AND PROVIDE A SMOKE-TIGHT BARRIER.
 ALL PRODUCTS AND MATERIALS TO BE USED AND INSTALLED SHALL CONFORM WITH MANUFACTURERS SPECIFICATIONS & APPLICABLE CODES.
 ALL VENT PIPING TO BE INSTALLED IN ACCORDANCE WITH NATIONAL PLUMBING CODE AND MANITOBA PLUMBING CODE REQUIREMENTS.
 DO NOT SCALE DRAWINGS. CONTRACTOR SHALL VERIFY ALL DIMENSIONS PRIOR TO INSTALLATION AND REPORT ANY DISCREPANCY TO THE ENGINEER.
 CONTRACTOR SHALL PERFORM COORDINATION BETWEEN TRADES AS REQUIRED FOR INSTALLATION OF MECHANICAL SYSTEM. WHERE ROUTING OF PIPING OR ADDITIONAL WORK REASONABLY INCIDENTAL TO ORIGINAL DESIGN INTENT IS REQUIRED DUE TO SITE CONDITIONS, IT SHALL BE DONE AT NO ADDITIONAL COST.
 PROVIDE TRAP PRIMING IN ACCORDANCE WITH NATIONAL PLUMBING CODE AS WELL AS LOCAL AUTHORITY HAVING JURISDICTION.

0	ISSUED FOR CONSTRUCTION	JAW	MAR 20 2017
No.	REVISION/DESCRIPTION	BY	DATE

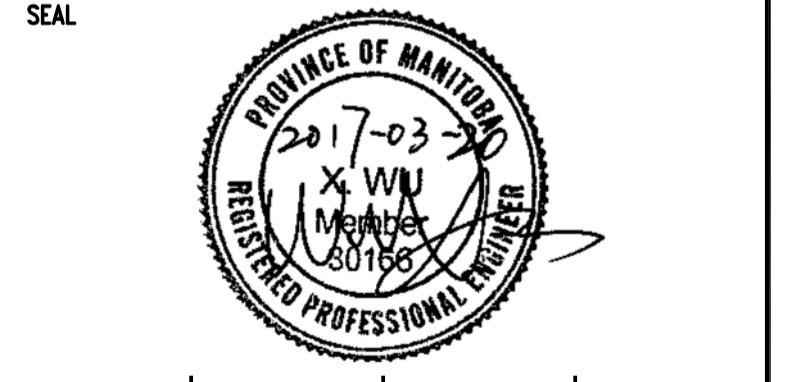

DRAWN	JAW	CHECKED	XYW	DESIGNED	XYW	APPROVED	XYW
DATE	2016.08.25	USER APPROVAL					

THE CITY OF WINNIPEG
 PLANNING, PROPERTY AND
 DEVELOPMENT DEPARTMENT
 MUNICIPAL ACCOMMODATIONS DIVISION
 3-65 GARRY STREET, R3C 4K4

PROJECT
 BRADY ROAD LANDFILL
 ADMINISTRATION BUILDING
 DEVELOPMENT FOR BRADY LANDFILL
 1777 BRADY ROAD

SHEET TITLE
 MAIN FLOOR PLUMBING PLAN

SCALE	PROJECT No:	SHEET No:
AS SHOWN	2015-037	M4

DRAWING SHEET SIZE: A1 (841mm x 594mm) PLOT 1:1