

FOUNDATION/ MAIN FLOOR PLAN

FOUNDATION LOADING:
DEAD LOAD (TYPICAL) = 5.0 kPa DEAD LOAD (MECH/ELEC) = 6.8 kPa LIVE LOAD = 4.8 kPa LIVE LOAD (MECH/ELEC) = 7.2 kPa

PLAN NOTES:


- SEE PLANS, SECTIONS, DETAILS, AND ARCHITECTURAL DRAWINGS FOR T.O. CONCRETE ELEVATIONS AND SLOPE OF SLABS.

- GRIDS ARE TO FACE OF GRADE BEAM OR CENTERLINE OF GRADE BEAMS U/N. - CONFIRM OPENING LOCATIONS IN STRUCTURAL SLABS WITH ARCH, MECH/ELEC, AND


STRUCT DRAWINGS.

- CONFIRM WEIGHT, SIZE, AND LOCATION OF ALL MECHANICAL AND ELECTRICAL UNITS BEING SUPPORTED ON SLAB WITH MECHANICAL AND ELECTRICAL DRAWINGS.

- COORDINATE ALL MISCELLANEOUS STEEL WITH ARCHITECTURAL DRAWINGS. - 'F.D.' DENOTES A FLOOR DRAIN. CONFIRM LOCATION WITH ARCH DRAWINGS.

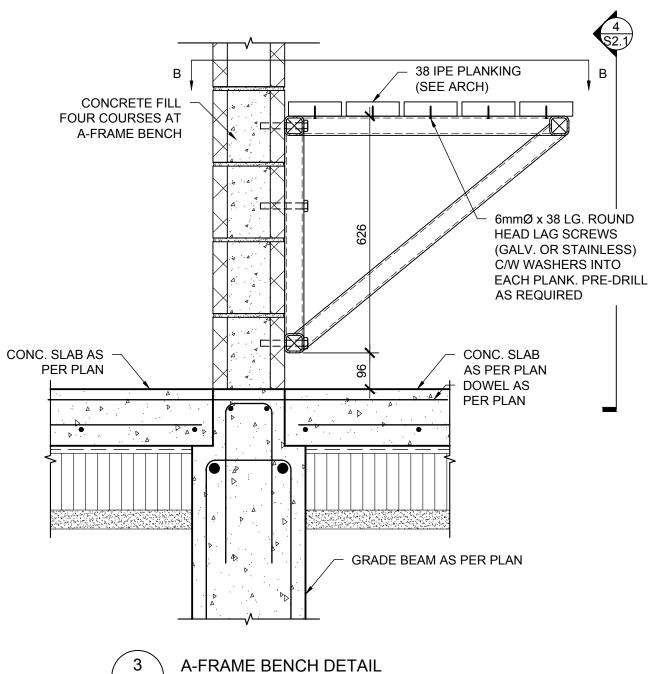


S2.1 SCALE: 1:10

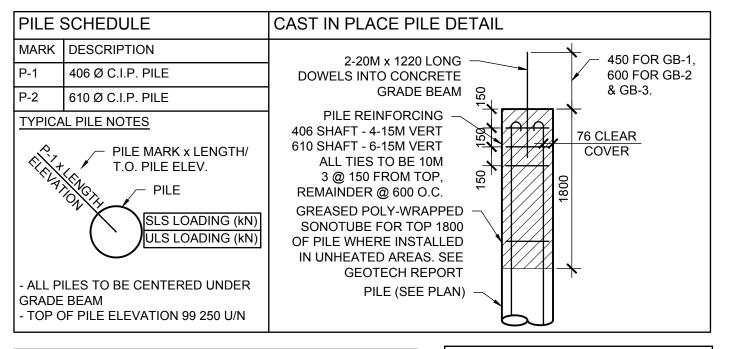

GRADE BEAM SCHEDULE SLAB SCHEDULE MARK DESCRIPTION MARK DESCRIPTION GB-1 200x600 CONC. GRADE BEAM 150 CONC. STRUCTURAL SLAB REINF: 2-20M TOP AND BOTTOM 10 OSB SHEATHING 10M STIRRUPS @ 300 O.C. 150 VOID FORM 50 LEVELLING SAND GB-2 250x600 CONC. GRADE BEAM REINF: 15M @ 400 O.C. E.W. BOTTOM REINF: 2-25M TOP AND BOTTOM BLL IN SHORT DIRECTION 10M STIRRUPS @ 300 O.C. C/W 190x150 CONC. UPSTAND 150 CONC. STRUCTURAL SLAB UPSTAND REINF: 2-15M HORIZ 10 MIL POLY V.B. 10M @ 300 O.C. 10 OSB SHEATHING 150 VOID FORM GB-3 300x600 CONC. GRADE BEAM 50 LEVELLING SAND REINF: 2-25M TOP AND BOTTOM REINF: 15M @ 300 O.C. E.W. BOTTOM 10M STIRRUPS @ 300 O.C. BLL IN SHORT DIRECTION C/W 190x150 CONC. UPSTAND 200 CONC. SLAB ON GRADE UPSTAND REINF: 2-15M HORIZ 10M @ 300 O.C. 300 MIN. COMPACTED GRANULAR ON COMPACTED SUBGRADE (SEE GEOTECH REPORT) REINF: 15M @ 400 O.C. E.W. CENTRE OF SLAB SAWCUTS AS PER PLAN - PROVIDE 50 DEEP x 150 HIGH x FULL WIDTH BEAM POCKET FOR ALL WALL TO WALL CONNECTIONS NOT POURED MONOLITHICALLY. PROVIDE TOP AND

- 'BLL' REFERS TO BOTTOM LOWER LAYER OF REINFORCING. STEP AND SLOPE SLABS AS INDICATED ON ARCH DRAWINGS. SLAB DEPTH AS SPECIFIED IN SCHEDULE IS TO BE MAINTAINED THROUGHOUT.

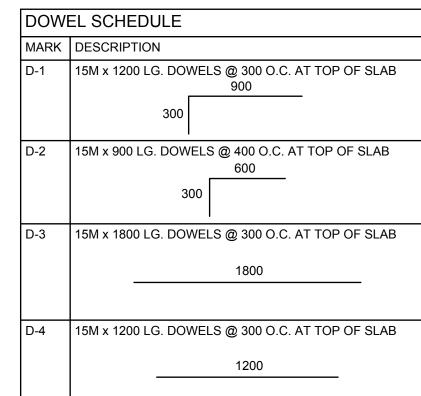

SLAB AS PER PLAN 10M NOSING BAR ALL AROUND. EXTEND PAST OPENING MIN. 600. FLOOR GRILL (SEE ARCH) CONFIRM WITH ARCH

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THIS DRAWING SHALL NOT BE SCALED

THE CONTRACTOR SHALL VERIFY ALL DIMENSIONS, DATUMS AND LEVELS NOTED ON THE DRAWINGS WITH THE CONDITIONS ON SITE AND SHALL BE RESPONSIBLE FOR REPORTING ANY ERRORS OR OMISSIONS TO THE ENGINEER FOR ADJUSTMENTS.

1 \ SLAB STEP DETAIL **S2.1** SCALE: 1:10


CANTILEVER BENCH DETAIL

MASONRY BLOCK


No. 1193 Date: May 30, 2017

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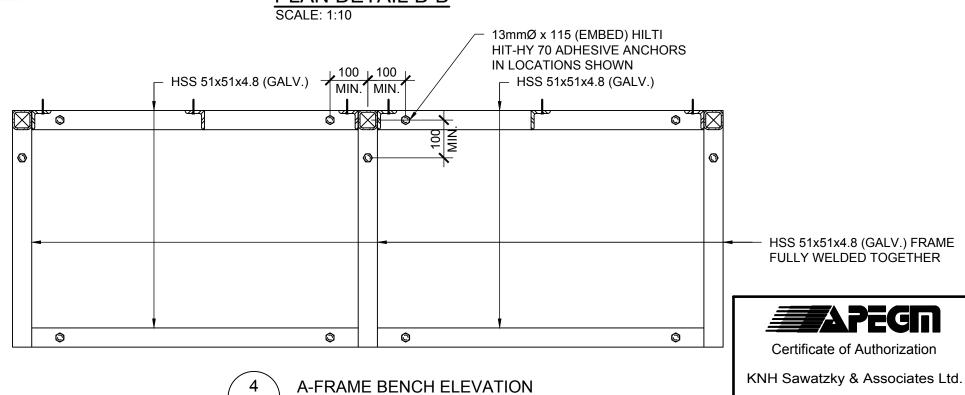




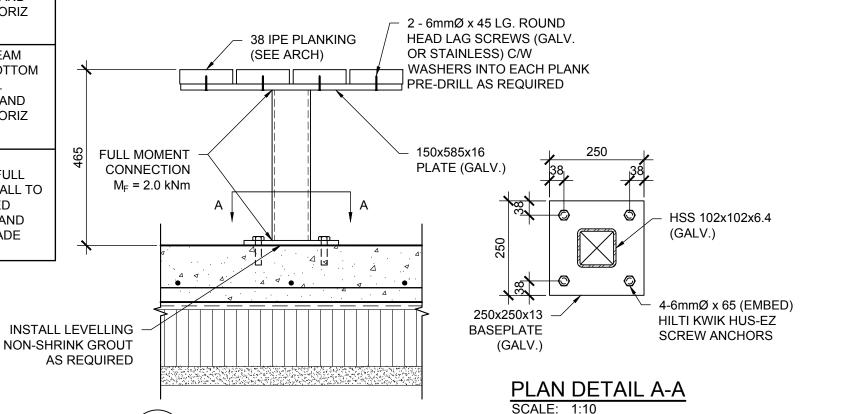


BOTTOM DOWELS TO MATCH GRADE

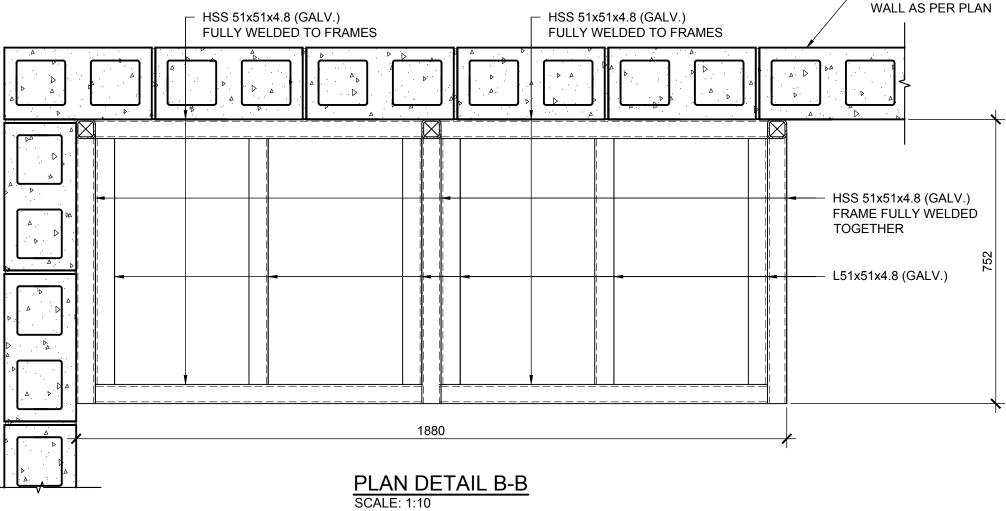BEAM REINFORCING. TYPICAL.



S2.1 SCALE: 1:10

Revisions Revision
ISSUED FOR CONSTRUCTION Prime Consultant:

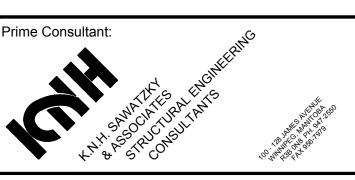

Northern Sky Architecture Inc.





STRUCTURAL ONLY CONTACT ENGINEER WHEN

INSPECTIONS ARE REQUIRED

La Barriere Park Washroom Replacement

La Barriere Park, Manitoba

	drawing title FOUNDATION/MAIN FLOOR PLAN				
	scale	as noted	designed by	js/m	ni
	date	May 2017	drawn by	js	
١.	project no.	337-2017	approved by	proved by mi	
	reference no.	16.235	sheet S2.1		REV.