

EXHAUST FAN ROOM MAIN FLOOR PLAN SCALE: 1:75



INSTRUMENT AIR CONNECTION

ELECTRICAL ROOM /aipa CONTROL ROOM

ELECTRICAL ROOM MAIN FLOOR PLAN SCALE: 1:75

NEW 50Ø INSTRUMENT AIR LINE TO EXIT BUILDING

ALONG THE NORTH WALL.

TIE-IN TO EXISTING INSTRUMENT AIR LINE.

MOUNT ON FACE OF EXISTING CABLE TRAY AS APPROPRIATE.

TIE-IN TO EXISTING 2500 RAS LINES WITH 23


250x250x150 REDUCING TEE. CONNECT 150Ø FLUSHING WATER &

VALVES PRIOR TO EACH

PROVIDE ISOLATION

CONNECTION.

SEE DETAIL 3.

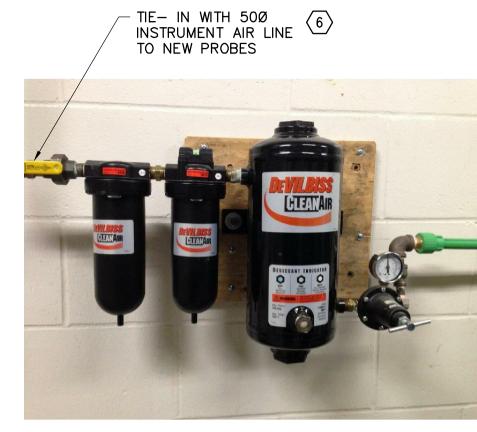

INSTRUMENT AIR CONNECTION



TANK FILL CONNECTION




KEYNOTES:


- 1. TIE-IN TO EXISTING HIGH PRESSURE, DRY COMPRESSED AIR SYSTEM.
- AQUATHERM GREENPIPE, SDR 7.4 ROUTE OF INSTRUMENT AIR LINE IS DIAGRAMMATIC. EXACT ROUTING TO BE DETERMINED ON SITE.
- SEE DETAIL 1 FOR APPROXIMATE CONNECTION LOCATION. • REUSE EXISTING PIPE SUPPORTS WHERE APPLICABLE.
- 2. EXISTING 2500 RAS LINE TO SBR 2 DOUBLES AS TANK FILL LINE.
- 316L STANDARD WEIGHT STAINLESS STEEL PIPE • TIE-IN 1500 FLUSHING WATER PIPE TO EXISTING RAS LINE
- DOWNSTREAM OF VALVE CV-282. • INSTALL NEW ISOLATION VALVE CV-282A ON FLUSHING WATER LINE (SHOWN ON VERTICAL)
- 3. EXISTING 2500 RAS LINE TO SBR 1 DOUBLES AS TANK FILL LINE.
- 316L STANDARD WEIGHT STAINLESS STEEL PIPE • TIE-IN 1500 FLUSHING WATER PIPE TO EXISTING RAS LINE
- DOWNSTREAM OF VALVE CV-182. • INSTALL NEW ISOLATION VALVE CV-182A ON FLUSHING WATER LINE (SHOWN ON VERTICAL)
- 4. 50Ø INSTRUMENT AIR TO SODA ASH SILO
- SEE DETAIL 3 FOR WALL PENETRATION • SEE DRAWING D-1001 FOR CONTINUATION OUTSIDE OF BUILDING.
- SEE DRAWING D-1005 FOR SODA ASH SILO DETAILS
- 5. 150Ø FLUSHING WATER LINE SEE DETAIL 3 FOR WALL PENETRATION
- INSULATED & HEAT TRACED PER SPECIFICATIONS.
- 6. TIE-IN TO EXISTING HIGH PRESSURE, DRY COMPRESSED AIR SYSTEM.
- AQUATHERM GREENPIPE, SDR 7.4 • ROUTE OF INSTRUMENT AIR LINE IS DIAGRAMMATIC. EXACT

SEE DRAWING C-1001 FOR CONTINUATION BELOW GRADE

- ROUTING TO BE DETERMINED ON SITE.
- REUSE EXISTING PIPE SUPPORTS WHERE APPLICABLE. • SEE DRAWING D-1001 FOR CONTINUATION OUTSIDE OF BUILDING.

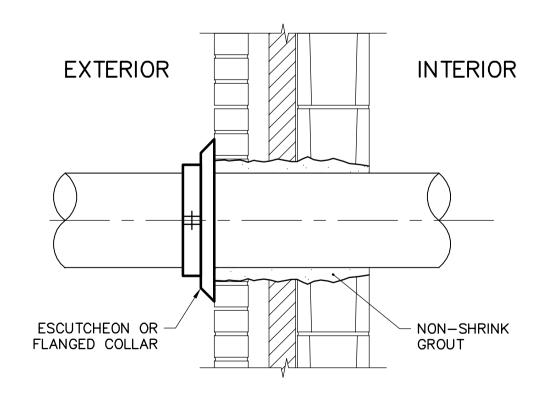

WALL PENETRATION SCALE **NONE**

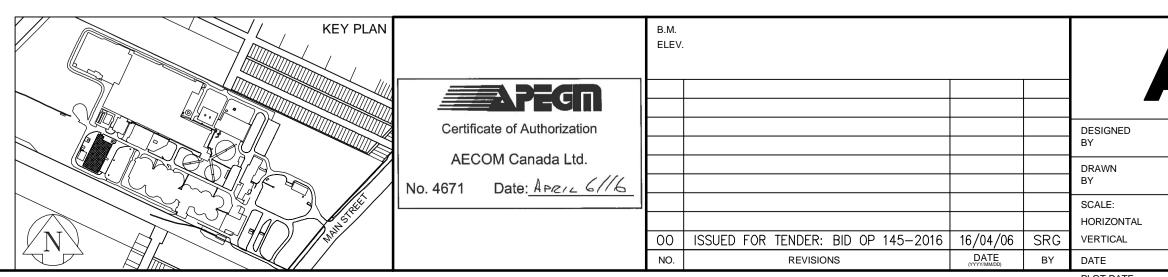

AECOM SEARS CHECKED APPROVED RELEASED FOR CONSTRUCTION NONE

NONE

2016 04 05

2016 04 05

DATE

CONSULTANT DRAWING NUMBER D-1004

Winnipèg

THE CITY OF WINNIPEG WATER AND WASTE DEPARTMENT **ENGINEERING DIVISION**

SHEET 14 OF 18

2016 NEWPCC SBR UPGRADES

EXHAUST FAN ROOM & ELECTRICAL ROOM PLANS & DETAILS

1-0101C-P0053-001-00

FILE PATH: P:\60338393\900-Work\910-CAD\20-SHEETS\D
FILE NAME: 60338393-SHT-30-0000-D-1004.dwg

BID OPPORTUNITY: 145-2016

CITY DRAWING NUMBER