

- UTILIZE EXISTING SUPPORTS AS APPLICABLE

SUPPORT ON EXISTING PIPE AS APPLICABLE






SUPPORT ON EXISTING PIPE AS APPLICABLE. SEE DRAWING D-1005 FOR CONTINUATION



KEYNOTES:


- 50Ø INSTRUMENT AIR LINE FROM EXISTING COMPRESSOR IN EXHAUST FAN ROOM TO SODA ASH AIR CANNONS.
- AQUATHERM GREENPIPE, SDR 7.4
- ROUTE OF INSTRUMENT AIR LINE IS DIAGRAMMATIC. EXACT ROUTING TO BE DETERMINED ON SITE.
- REUSE EXISTING PIPE SUPPORTS WHERE APPLICABLE.
- FOR DETAILS INSIDE EXHAUST FAN BUILDING, SEE DRAWING D-1004. • FOR DETAILS AT SODA ASH SILO, SEE DRAWING D-1005.
- 2. 150Ø FLUSHING WATER FOR SBR TANK FILL.
- SCH 80 PCV PIPE
- ALL EXTERIOR PIPING ABOVE GRADE TO BE INSULATED & HEAT TRACED PER SPECIFICATIONS
- FOR CONTINUATION BELOW GRADE, SEE DRAWING C-1001. • FOR CONTINUATION INSIDE EXHAUST FAN ROOM, SEE DRAWING D-1004.
- 3. PROVIDE SEVEN (7) NEW 2100m± SQUARE, INSULATED ENCLOSURES, MANUFACTURED IN
- ACCORDANCE WITH THE 2010 NATIONAL BUILDING CODE OF CANADA:
- WESTERN STEEL AND TUBE, 1247 CLARENCE AVE WINNIPEG MB (TO MATCH EXISTING); OR
- ENDURO VPC FIBREGLASS ENCLOSER MODEL 600; OR APPROVED EQUAL.
- 4. PROVIDE SEVEN (7) NEW HEATERS:• OUELLET 208V, 3 PHASE, 3000W MAXIMUM, OR EQUIVALENT
- 5. FOR SODA ASH SILO UPGRADES, SEE DRAWING D-1005.
- 6. FOR NEW SA PIPING CONFIGURATION INSIDE SBR TANKS, SEE DRAWING D-1002.
- 7. EXISTING ENCLOSURE TO REMAIN.
- 8. PROVIDE 1.0m x 1.0m x 1.0m WOOD FRAMED, INSULATED ENCLOSURES FOR PROBE PROTECTION.
- 9. 50Ø INSTRUMENT AIR LINE FROM EXISTING COMPRESSOR IN ELECTRICAL ROOM TO EACH POTENTIAL PROBE LOCATION.
- AQUATHERM GREENPIPE, SDR 7.4
- ROUTE OF INSTRUMENT AIR LINE IS DIAGRAMMATIC. EXACT ROUTING TO BE DETERMINED ON SITE.
- REUSE EXISTING PIPE SUPPORTS WHERE APPLICABLE.
- FOR DETAILS INSIDE ELECTRICAL ROOM, SEE DRAWING D-1004. • FOR CONNECTION TO PROBES, SEE DETAIL 2 ON DRAWING D-1003.
- 10. PROVIDE UNISTRUT BRACKET TO SUPPORT CONDUCTIVITY PROBE. CONFIRM LOCATION WITH CONTRACT ADMINISTRATOR.

- 1. FOR PROBE INSTALLATION & LOCATIONS, DRAWING D-1003.
- 2. PROBES & TRANSMITTERS WILL BE INSTALLED ON SBR 2 ONLY AT THIS TIME. PROVIDE ALL NEW QUICK CONNECTIONS & WIRING FOR EACH PROBE AT BOTH SBR TANKS. SEE INSTRUMENT LOOP DIAGRAMS FOR CONNECTION DETAILS. ONLY ONE SBR WILL BE IN SERVICE AT A TIME, WITH PROBES & TRANSMITTERS BEING RELOCATED PERIODICALLY

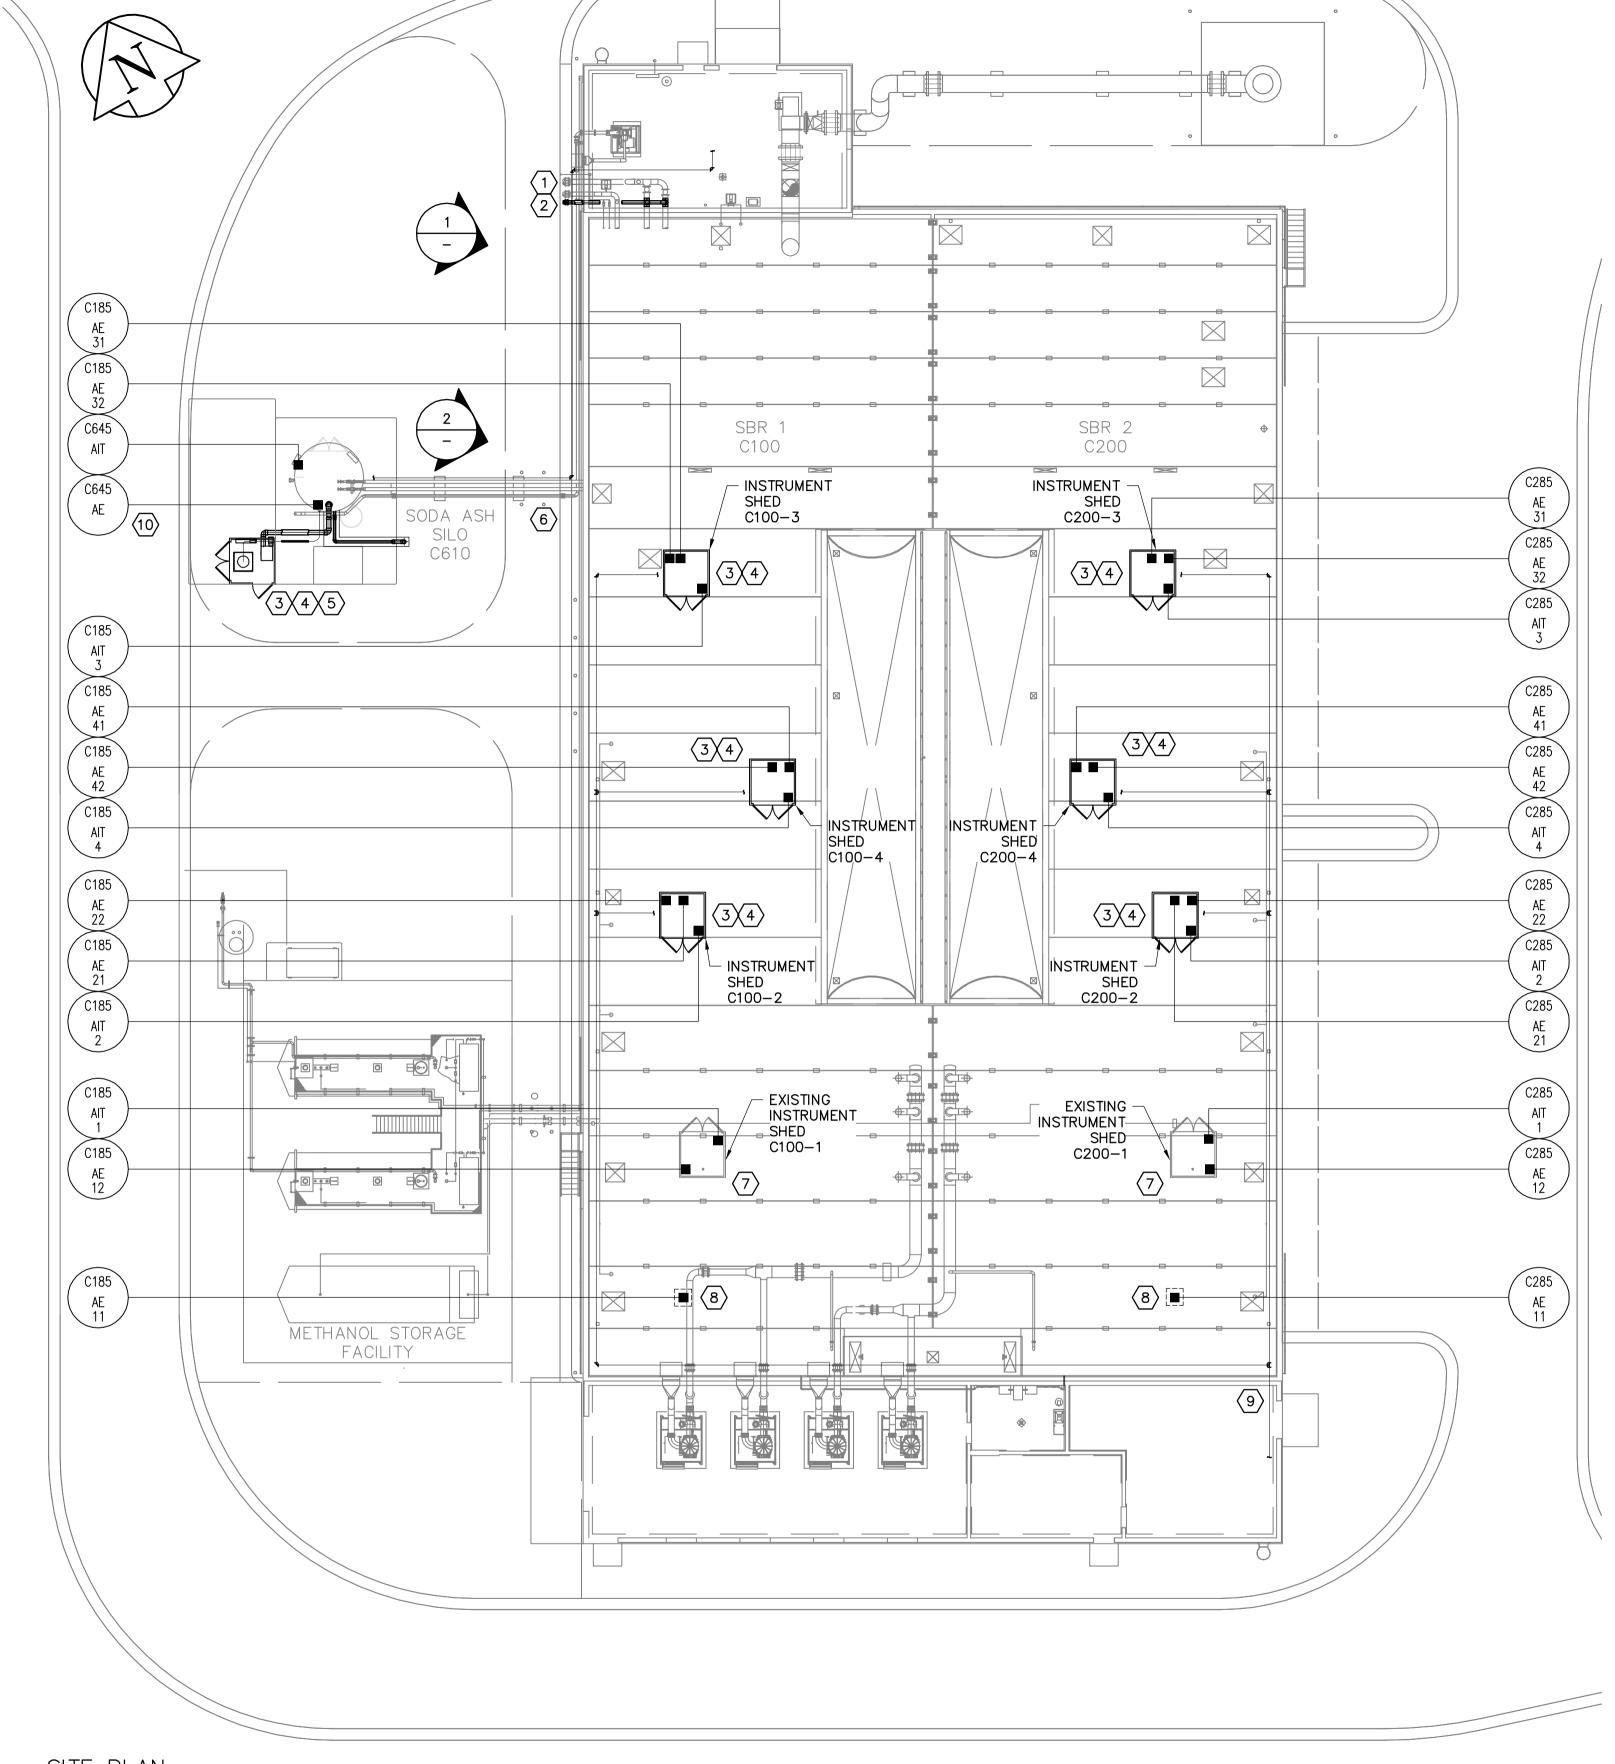

SITE PLAN SCALE: 1:200

AS-CONSTRUCTED DIMENSIONS, MEASUREMENTS AND OTHER DETAILS CONTAINED IN THIS RECORD DRAWING HAVE BEEN OBTAINED BY AECOM CANADA LTD. ("AECOM") FROM VARIOUS SOURCES. SUCH INFORMATION REPRESENTS THE BEST INFORMATION AVAILABLE TO AECOM AT THE TIME OF PREPARATION OF THIS RECORD DRAWING. AECOM DOES NOT IN ANY WAY REPRESENT OR WARRANT THAT SUCH INFORMATION IS ACCURATE AND ASSUMES NO RESPONSIBILITY FOR ANY ERRORS OR **OMISSIONS CONTAINED THEREIN.**

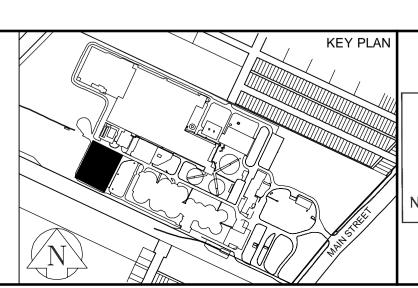

ELEV. **EAPEGN** Certificate of Authorization AECOM Canada Ltd. No. 4671 Date: APRIL 6/16 OO ISSUED FOR TENDER: BID OP 145-2016 16/04/06 DATE (YYYY/MM/DD)

AECOM DESIGNED CHECKED CGL KJS DRAWN APPROVED SRG KJS RELEASED FOR SCALE: CONSTRUCTION 1: 200 HORIZONTAL

DATE

2016 04 05

VERTICAL

SEARS

CONSULTANT DRAWING NUMBER

BID OPPORTUNITY: 145-2016

D-1001

Winnipèg

THE CITY OF WINNIPEG WATER AND WASTE DEPARTMENT **ENGINEERING DIVISION**

SHEET 11 OF 18

2016 NEWPCC SBR UPGRADES LOCATION PLAN & DETAILS

1-0101C-P0050-001-00

FILE NAME: 60338393-SHT-30-0000-D-1001.dwg

CITY DRAWING NUMBER