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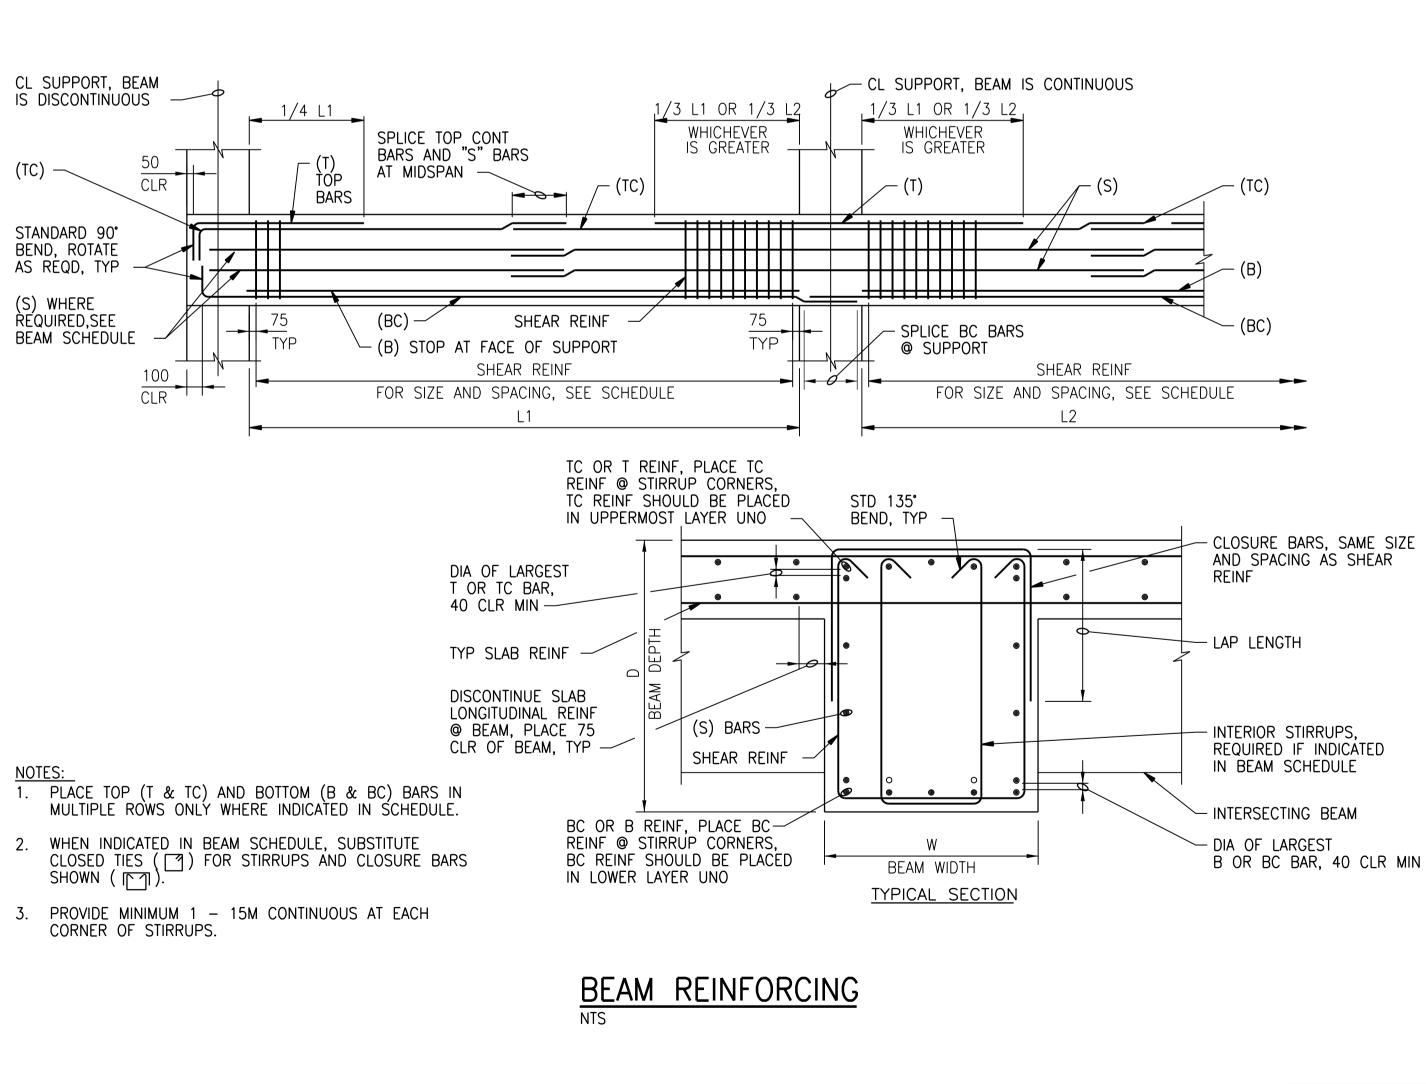
BEAM NO.	SIZE		* TOP REINF AT LEFT SUPPORT		BOTTOM REINF		* TOP REINF AT RIGHT SUPPORT		S			SHEAR REII	REMARKS	
(SEE PLANS)	w	D	Т	тс	В	BC	Т	TC	TC BARS (		SIZE	TYPE	SPACING FROM LEFT SUPPORT	
BM1	400	600	_	4-25M	_	4-25M	_	4-25M	_	1	10M	STIRRUP	© 250	PROVIDE MATCHING DOWELS FROM WALL
BM2	300	500	-	3-25M	-	3-25M	-	3-25M	-	2	10M	STIRRUP	© 250	
BM3	300	500	_	3-25M	_	3-25M	_	3-25M	_	2	10M	STIRRUP	© 250	
BM4	300	600	_	3-20M	-	3-20M	-	3-20M	_	1	10M	STIRRUP	© 300	
GBM1	800	2300	_	4-25M	-	4-25M	-	4-25M	2×6-20M	2	10M	STIRRUP	© 300	
GBM1a	800	2300	_	6-25M	-	6-25M	-	6-25M	2×6-20M	2	10M	STIRRUP	© 300	CLOSE STIRRUPS ABOVE AND BELOW OPENING, SEE DETAIL #2/SDTL-ROO6
GBM2	800	800	_	4-25M	2-25M	4-25M	_	4-25M	2x3-20M	2	10M	STIRRUP	© 300	DEPTH INCREASES OVER CONCRETE AIR SHAFT, SEE DETAILS ON DRAWING SDTL-R003

BEAM SCHEDULE

NTS

## NOTES:

- 1. \* TOP REINFORCING MAY BE CALLED-OUT TWICE IN SCHEDULE. (I.E. "TOP REINFORCING AT RIGHT SUPPORT" OF BEAM THAT IS CONTINUOUS OVER THE RIGHT SUPPORT IS CALLED-OUT AS "TOP REINFORCING AT LEFT SUPPORT" OF ADJACENT BEAM.)
- 2. LEFT SUPPORT IS DESIGNATED AS THE SUPPORT CLOSEST TO THE LEFT SIDE OR BOTTOM OF SHEET ON WHICH FRAMING PLAN IS DRAWN, UNLESS NOTED OTHERWISE ON PLAN.
- 3. WHERE FLOOR SLOPES, DEPTH OF BEAM (D) SHOWN IS MINIMUM DEPTH. BOTTOM ELEVATION OF BEAM SHALL BE CONSTANT, UNLESS INDICATED OTHERWISE.
- 4. WHERE SHEAR REINFORCING "TYPE" IS INDICATED AS "STIRRUP", PROVIDE SHEAR REINFORCING AND CLOSURES AS SHOWN IN BEAM REINFORCING DETAIL. WHERE SHEAR REINFORCING "TYPE" IS INDICATED AS "CLOSED TIE", PROVIDE CLOSED TIES IN LIEU OF STIRRUPS AND CLOSURE BARS.
- 5. "NO." INDICATES NUMBER OF STIRRUPS OR TIES PER SET.




COLUMN REINFORCING	SIZE	(mm)	VERTICAL REINFORCING	TRAVERSE REINFORCING		CROSS-SECTION	REMARKS		
	W	D	(NUMBER-SIZE)	SIZE	S				
C1	400	900	8-25M	10M	300				
C2	500	400	6-20M	10M	300				
C3	300	1200	8-25M	10M	300				
C4	300	400	4-25M	10M	300				
C5	300	900	6-25M	10M	300				
C6	300	675	6-25M	10M	300				

## NOTES:

"W" = DIMENSION IN EAST/WEST DIRECTION. 1.

2. "D" = DIMENSION IN NORTH/SOUTH DIRECTION. 3. "S" = SPACING, SEE DETAIL BELOW.

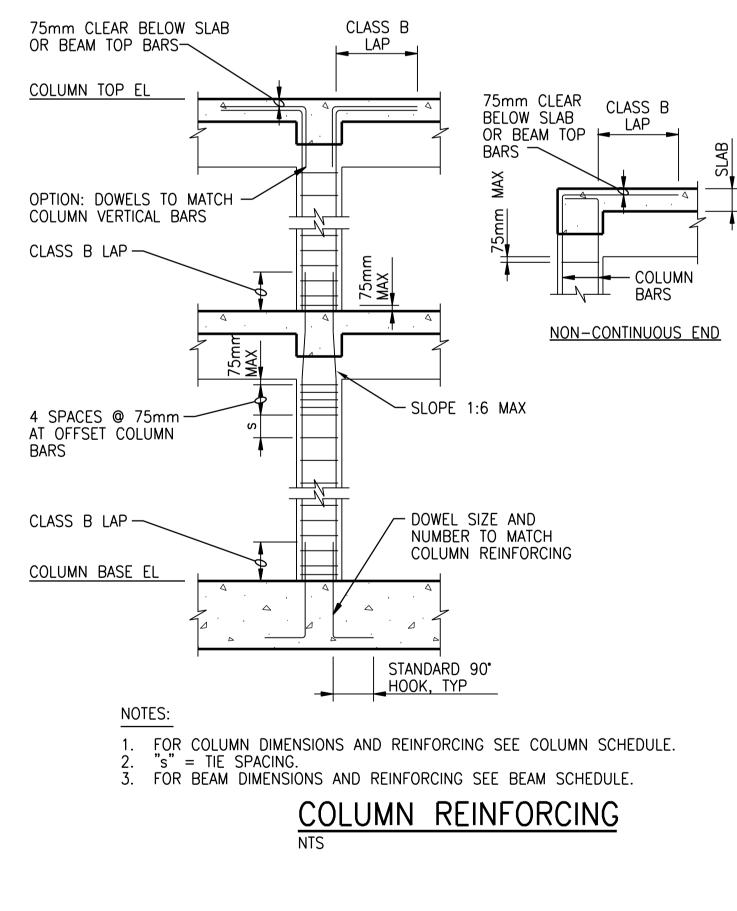

			CH2MHIL				
						<b>SNC·LAVALIN</b>	
						designed by: J. THANNICKAL	CHECKED BY: E.
						drawn by: C. RYNARD	APPROVED 6 H.T. FR
Certificate of Authorization						scale: NTS	ISSUED FOR ( BY: T.
CH2M HILL Canada Ltd.						<sup>DATE:</sup> 2016/01/29	DATE: 201
No. 1441	00 NO.	ISSUED FOR TENDER - B.O. 899-2015 REVISIONS	01/2016 DATE	C.R. DESIGN	J.C. check	CONSULTANT NO.: 474248	

PLOT DATE: 2016\01\28

## COLUMN REINFORCING SCHEDULE

