
DRAWING NUMBER

REFERENCE DRAWINGS

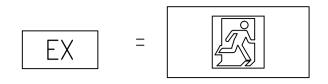

EX >

CEILING MOUNTED EXIT SIGN (PLAN VIEW) TYPE (REFER TO SCHEDULE) ARROW AS INDICATED ON DRAWING

WALL MOUNTED EXIT SIGN (PLAN VIEW) = TYPE (REFER TO SCHEDULE) ARROW AS INDICATED ON DRAWING

WALL MOUNTED BATTERY/EXIT COMBINATION UNIT (PLAN VIEW) TYPE (REFER TO SCHEDULE) ARROW AS INDICATED ON DRAWING

WALL MOUNTED EXIT SIGN (SIDE VIEW) SHOWN ON STAIRWELL ELEVATION DRAWINGS. DIRECTION OF EXIT SIGN:

A LEFT ARROW

ZD7 RIGHT ARROW

HIGH BAY LUMINAIRE X = TYPE (REFER TO SCHEDULE)

LUMINAIRE, 610mm LENGTH \bigotimes X = TYPE (REFER TO SCHEDULE)

X = TYPE (REFER TO SCHEDULE) LUMINAIRE, ALWAYS "ON" (E.M & (X)///// = NIGHT LIGHT)

> X = TYPE (REFER TO SCHEDULE) CEILING MOUNTED LED LUMINAIRE X = TYPE (REFER TO SCHEDULE)

> WALL MOUNTED LED LUMINAIRE X = TYPE (REFER TO SCHEDULE)

YOKE / HANDRAIL MOUNTED LED LUMINAIRE X = TYPE (REFER TO SCHEDULE)

LUMINAIRE, 1220mm LENGTH

SINGLE POLE TOGGLE SWITCH \equiv (C = DENOTES SWITCHING ARRANGEMENT 3 = 3 - WAY SWITCH)

TWO GANGED SINGLE POLE TOGGLE SWITCHES (J, H = DENOTES SWITCHING ARRANGEMENT)3 = 3 - WAY SWITCH)


OCCUPANCY SENSOR SWITCH (A = DENOTES SWITCHING ARRANGEMENT)

OVERRIDE PUSH BUTTON C/W OCCUPANCY SENSOR (A = DENOTES SWITCHING ARRANGEMENT)

PHOTOCELL

WALL MOUNTED SWITCH C/W OCCUPANCY SENSOR

(P = DENOTES SWITCHING ARRANGEMENT)

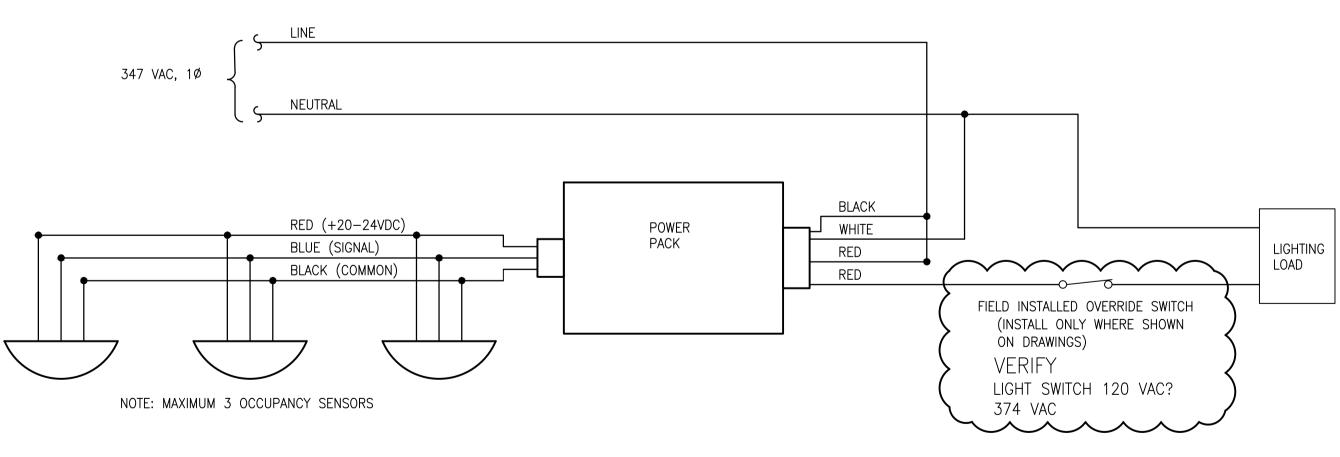

OCCUPANCY SENSOR WIRING DETAIL (TYP.)

APEGIN Certificate of Authorization SNC-Lavalin Inc. No. 4489

GENERAL NOTES:

- 1. INSTALLATION MUST COMPLY WITH THE CANADIAN ELECTRICAL CODE, THE NATIONAL BUILDING CODE OF CANADA, AND CITY OF WINNIPEG ELECTRICAL BYLAW.
- 2. PROVIDE ALL NECESSARY MOUNTING ACCESSORIES FOR INSTALLATION OF NEW RUNNING MAN EXIT SIGNS.
- 3. IT IS THE RESPONSIBILITY OF THE ELECTRICAL CONTRACTOR TO CONFIRM EXACT CIRCUIT NUMBERS ON SITE. MODIFICATION OF CIRCUIT NUMBERING DURING CONSTRUCTION WILL NOT CONSTITUTE AN EXTRA TO THE CONTRACT.
- 4. EXIT SIGNS ARE TO BE INSTALLED IN ACCORDANCE WITH THE SIGN ORIENTATIONS SHOWN ON THE DRAWING TO INDICATE THE REQUIRED EGRESS PATH IN ACCORDANCE WITH BUILDING AND LOCAL AUTHORITY REQUIREMENTS.

EXIT SIGN SCHEDULE								
TYPE (EX)	DESCRIPTION	MANUFACTURER	MODEL	VOLTS (VAC)	LOAD	NOTES		
E1	LN SERIES, NEMA 4X RATED, SINGLE-FACED	LUMACELL	LN1WU00	120-347	LESS THAN 2.5W			
E2	LN SERIES, NEMA 4X RATED, DOUBLE-FACED	LUMACELL	LN2WU00	120-347	LESS THAN 2.5W			
E3	LA SERIES, EXTRUDED ALUMINUM EXIT SIGN, SINGLE-FACED	LUMACELL	LA1WU00	120-347	LESS THAN 2.5W			
E4	LA SERIES, EXTRUDED ALUMINUM EXIT SIGN, DOUBLE-FACED	LUMACELL	LA2WU00	120-347	LESS THAN 2.5W			
E5	LH SERIES, HAZARDOUS LOCATIONS (CLASS I, ZONE 2), SINGLE-FACED	LUMACELL	LH1GU00	120-347	LESS THAN 2.5W	1		
E6	DIRECTION WAY GUIDANCE SIGNS, PHOTOLUMINESCENT EXIT SIGN, RIGHT ARROW	THOMAS & BETTS	PL4344GR	N/A	N/A	2		
E7	DIRECTION WAY GUIDANCE SIGNS, PHOTOLUMINESCENT EXIT SIGN, LEFT ARROW	THOMAS & BETTS	PL4343GR	N/A	N/A	2		
E8	LAC SERIES, EXTRUDED ALUMINIUM COMBINATION UNIT, SINGLE-FACED	LUMACELL	LAC1W6722LD1AT	120-347	0.15A	3		
E9	LX SERIES, HAZARDOUS LOCATIONS (CLASS 1, DIV. 1), SINGLE-FACED	LUMACELL	LX1S1P120	120	MAX. 4W	4,5		

SPECIFIC NOTES:

- CLASS I, ZONE 2 RATED.
- ONLY USED IN STAIRWELLS.
- UNIT IS EQUIPPED WITH BATTERY AND EMERGENCY LIGHTING HEADS.
- CLASS I, ZONE 1 RATED.
- RSTP TRANSFER PANEL (LUMACELL P/N: 347/120RSTP25) TO POWER THE 120 VAC LX SERIES FROM 347 VAC POWER SOURCE.

		LUMINAIRE	SCHEDULE	- -			
TYPE	MANUFACTURER	MODEL	LAMP TYPE	VOLTS (VAC)	LOAD	MOUNTING	NOTES
А	PHILIPS	HBX13LL40-347-M-WT	LED	347	106 W	PH	
В	APPLETON	AMLED-6-7-Y-BH / AMLEDSF1	LED	347	76 W	Y / SP	1
С	PHILIPS CFI	DWAE232-347, <10% THD, INSTANT START	2-T8	347	64 W	cs	
D	KENALL	TES8-48-1-45L40K-DCC-1-120-P5H-PP	LED	347	50 W	TRC / CS	2
E	KENALL	TES8-48-1-100L40K-DCC-1-347-P5H-PP	LED	347	113 W	TRC / CS	2
F	KENALL	TES8-48-1-50L40K-DCC-1-DV-P5H-PP	LED	120	58 W	TRC / CS	
G	CFI	DWAE232-347-EB10I	Т8	347	54 W	SH/CS	
Н	NOT USED						
J	PHILIPS	LP32T	LED	347	71 W	W	
К	PHILIPS	LP32T / R10855	LED	347	71 W	W	3
L	APPLETON	LLEDA15BC2	LED	347	46 W	TRC / SH	1
М	APPLETON	LLEDA17BC2	LED	347	82 W	CS	1
N	CFI	SPS2GFSVA33212003	3-T8	120	3X32 W	R/TB	
0	CFI	HWC232-120 / FKR-126	2-T8	120	53 W	СН	
Р	CFI	2LP3CGS332-36AL-UNV-1/3EB10I	3-T8	120	90 W	R/TB	
R	CFI	1TG8232-21-UNV-CM-2W	2-T8	120	56 W	R/TB	
S	PHILIPS	C4LION1VBZ10V/C4L10DL35KCLWVB	LED	120V	14 W	R/TB	
Х		EXISTING LIGHTING					
EA	LUMACELL	MQM2LD1	LED	6 VDC	2X4W	W	4

RECESSED / I-BAR CEILING SURFACE SLIP-FITTER/POST PENDANT HANGER THREADED ROD AND CHANNEL STEM HUNG YOKE CHAIN HUNG AS NOTED ON DRAWINGS

SPECIFIC NOTES:

. CLASS I, ZONE 1 RATED.

00 ISSUED FOR TENDER

- 2. FIXTURE C/W 347/120 VAC INTEGRAL STEPDOWN TRANSFORMER.
- 3. FIXTURE C/W INTEGRAL 347 VAC PHOTOCELL. 4. REMOTE EMERGENCY HEAD LIGHTING FIXTURE.

	CH2	ENGINEER'S SEAL		
	SNC·LAVALIN	KGS GROUP CONSULTING ENGINEERS		
	DESIGNED BY: S. JUGANAS	CHECKED BY: D. BECKER		
	DRAWN BY: G. WILLIAMSON	APPROVED BY: D. BECKER	PRELIMINARY NOT FOR CONSTRUCTION	
	SCALE: NTS	ISSUED FOR CONSTRUCTION BY:		

08/2015 | SLJ | DEB

THE CITY OF WINNIPEG WATER AND WASTE DEPARTMENT

SOUTH END WATER POLLUTION CONTROL CENTRE SEWPCC UPGRADING/EXPANSION PROJECT ELECTRICAL SCHEDULE

LUMINAIRE AND EXIT SIGNS

1 CONSULTANT NO.: 474248 FILE NAME:1-0102-ESCH-A002.dwg

2015/02/04

PLOT DATE: Aug 12, 2015 - 2:32pm