


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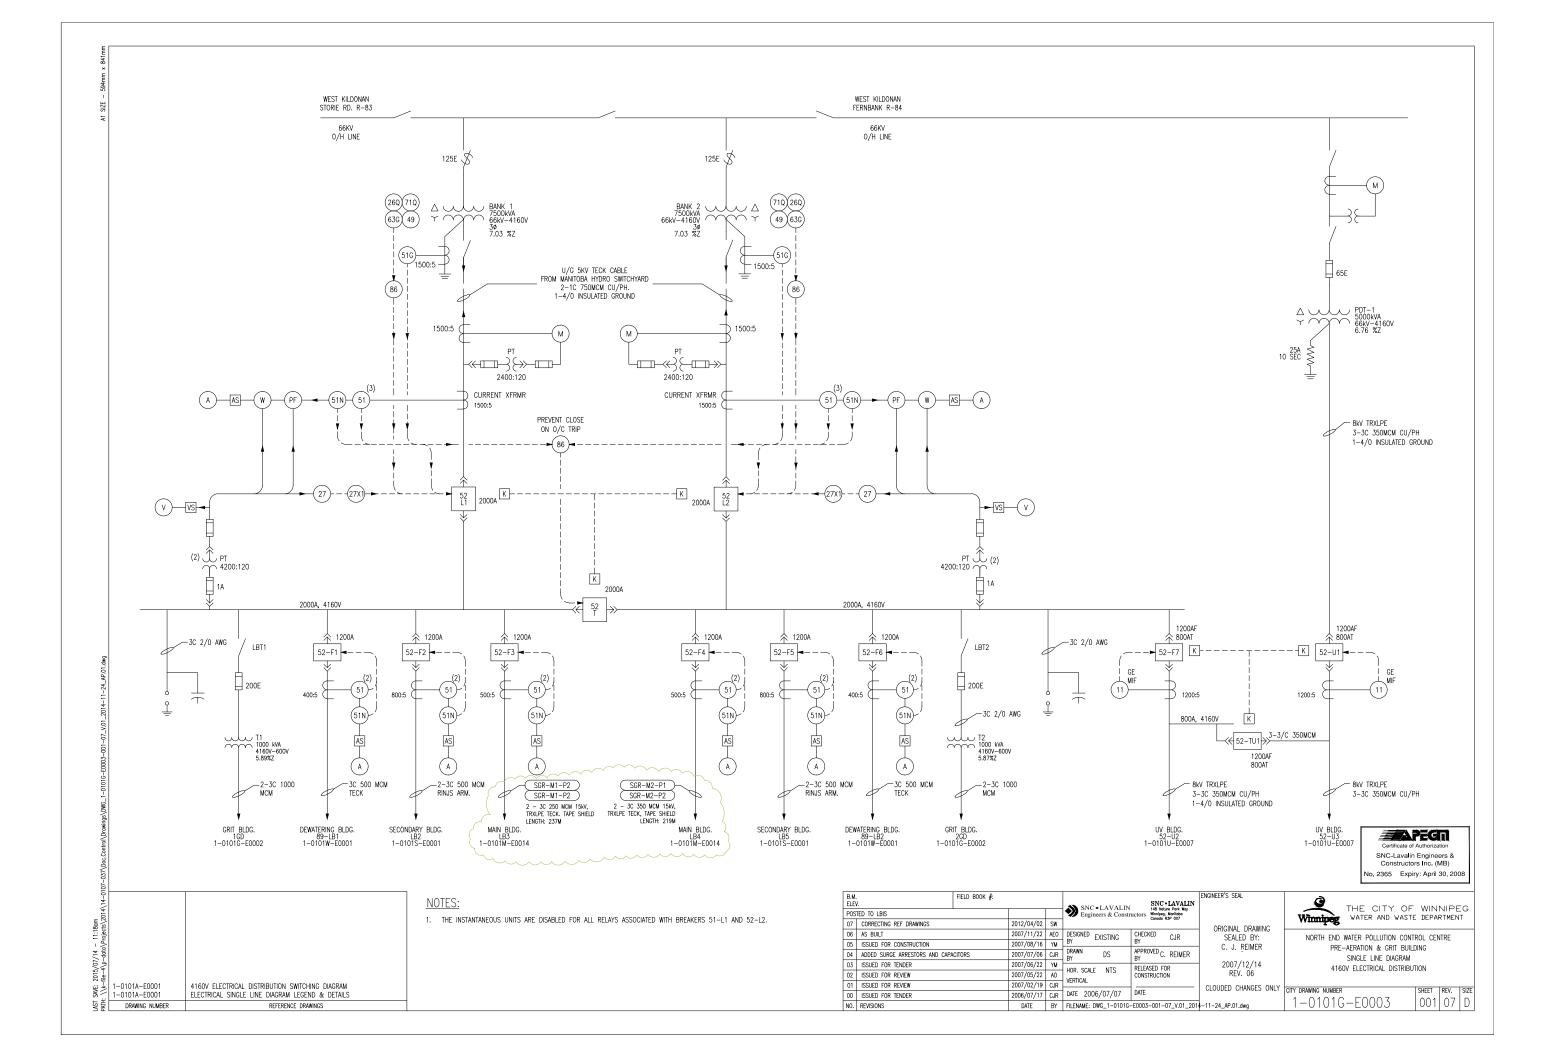
DRAWN APPROVED CJR RELEASED FOR HOR. SCALE NTS CONSTRUCTION VERTICAL NTS 2008/03/03 | EFB REVISED DRAWING NUMBER; WAS 1-0101A-D-E0001 2007/07/05 CJR DATE 2005/11/07 DATE 00 ISSUED FOR CITY USE NO. REVISIONS DATE | BY | FILENAME: 1-0101A-E0004-001-01D.dwg Winnipeg WATER AND WASTE DEPARTMENT

NORTH END WATER POLLUTION CONTROL CENTRE


ELECTRICAL SINGLE LINE DIAGRAM LEGEND & DETAILS


CITY DRAWING NUMBER 001 01 D



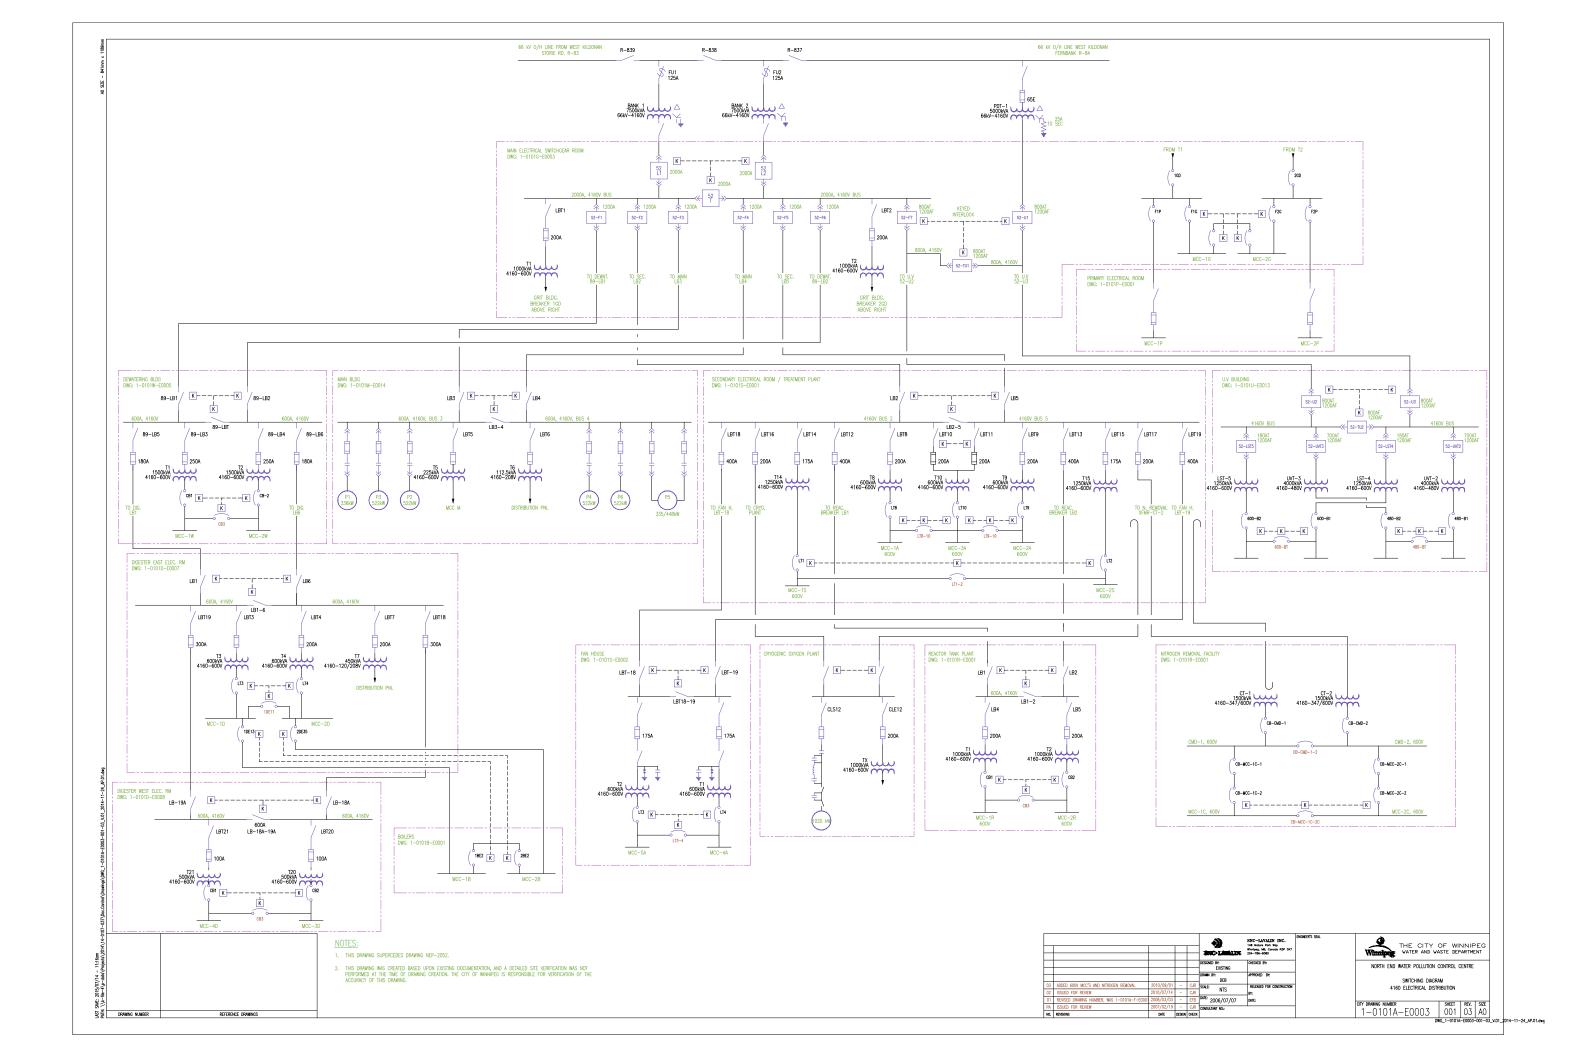

FROM GRIT BUILDING F2P FROM GRIT BUILDING 1-0101G-E0002 1-0101G-E0002 2-3C 350 MCM TECK 2-3C 350 MCM TECK (1-ALUMINUM, 1-COPPER) (1-ALUMINUM, 1-COPPER) KIRK KEY #12040 | KIRK KEY #12040 1PE5 K - - - - - - - - K MCC 1P 600V, 3ø 600V, 3ø, 3W 600V, 3ø -0 _{1PE2} 0-400A 1PE3 80A 9 N.O. KIRK KEY #12040 N.O. 3C 250 MCM TECK ____ 3C 250 MCM TECK FROM DIGESTER BUILDING 2PE14 45 kVA 600V-208/120V 3 PHASE, DRY TYPE PNL 1UPS 1-0101D-E0008 TRANSFORMER 1PE37 (⁶ 2PF17 (^A 2PE18 400A MCC-2P EXT MCC-1P EXT 600V, 3ø, 3W 600V, 3ø, 3W 3C #2 TECK90 PNL B 120/208V 200A 3ø, 4W 42 CCT PNL A 1PE34 60A 120/208V 200A 60A 3ø, 4W 42 CCT 3C #6 R90 2PE36 45kVA 600V-208/120V 3 PHASE, DRY TYPE TRANSFORMER 1PE35 45kVA 600V-208/120V 3 PHASE, DRY TYPE TRANSFORMER PNL 3UPS 120/208V 100A 3ø, 4W 24CCT 120/208V 225A 3ø, 4W 120/208V 225A 3ø, 4W 42 CCT 42 CCT IN PRIMARY CLARIFIER CONTROL ROOM (NORMAL POWER) (ESSENTIAL POWER) FIELD BOOK #: Winnipeg THE CITY OF WINNIPEG WATER AND WASTE DEPARTMENT SNC-LAVALIN INC. 148 Nature Park Way
Winnipeg, MB, Canada R3P 0X7
204-786-8080 POSTED TO LBIS 1. ALL CONDUIT IS GENERALLY RIGID ALUMINUM, UNLESS OTHERWISE NOTED. CHECKED CJR DESIGNED EXISTING NORTH END WATER POLLUTION CONTROL CENTRE PRIMARY CLARIFIERS APPROVED BY DRAWN DEB SINGLE LINE DIAGRAM RELEASED FOR CONSTRUCTION ELECTRICAL DISTRIBUTION HOR. SCALE NTS REVISED DRAWING NUMBER; WAS 1-0101P-F-E0001 2008/03/03 EFB 1-0101G-E0002 GRIT BULDING SINGLE LINE DIAGRAM ELECTRICAL DISTRIBUTION VERTICAL 2007/07/05 CJR 1-0101A-E0003 1-0101A-E0004 4160V ELECTRICAL DISTRIBUTION SWITCHING DIAGRAM 0 | ISSUED FOR CITY USE CITY DRAWING NUMBER 2007/02/19 CJR DATE 2006/07/07 DATE ELECTRICAL SINGLE LINE DIAGRAM LEGEND & DETAILS PA ISSUED FOR REVIEW 1-0101P-E0001 NO. REVISIONS DRAWING NUMBER REFERENCE DRAWINGS DATE BY | FILENAME: 1-0101P-E0001-001-01D.dwg

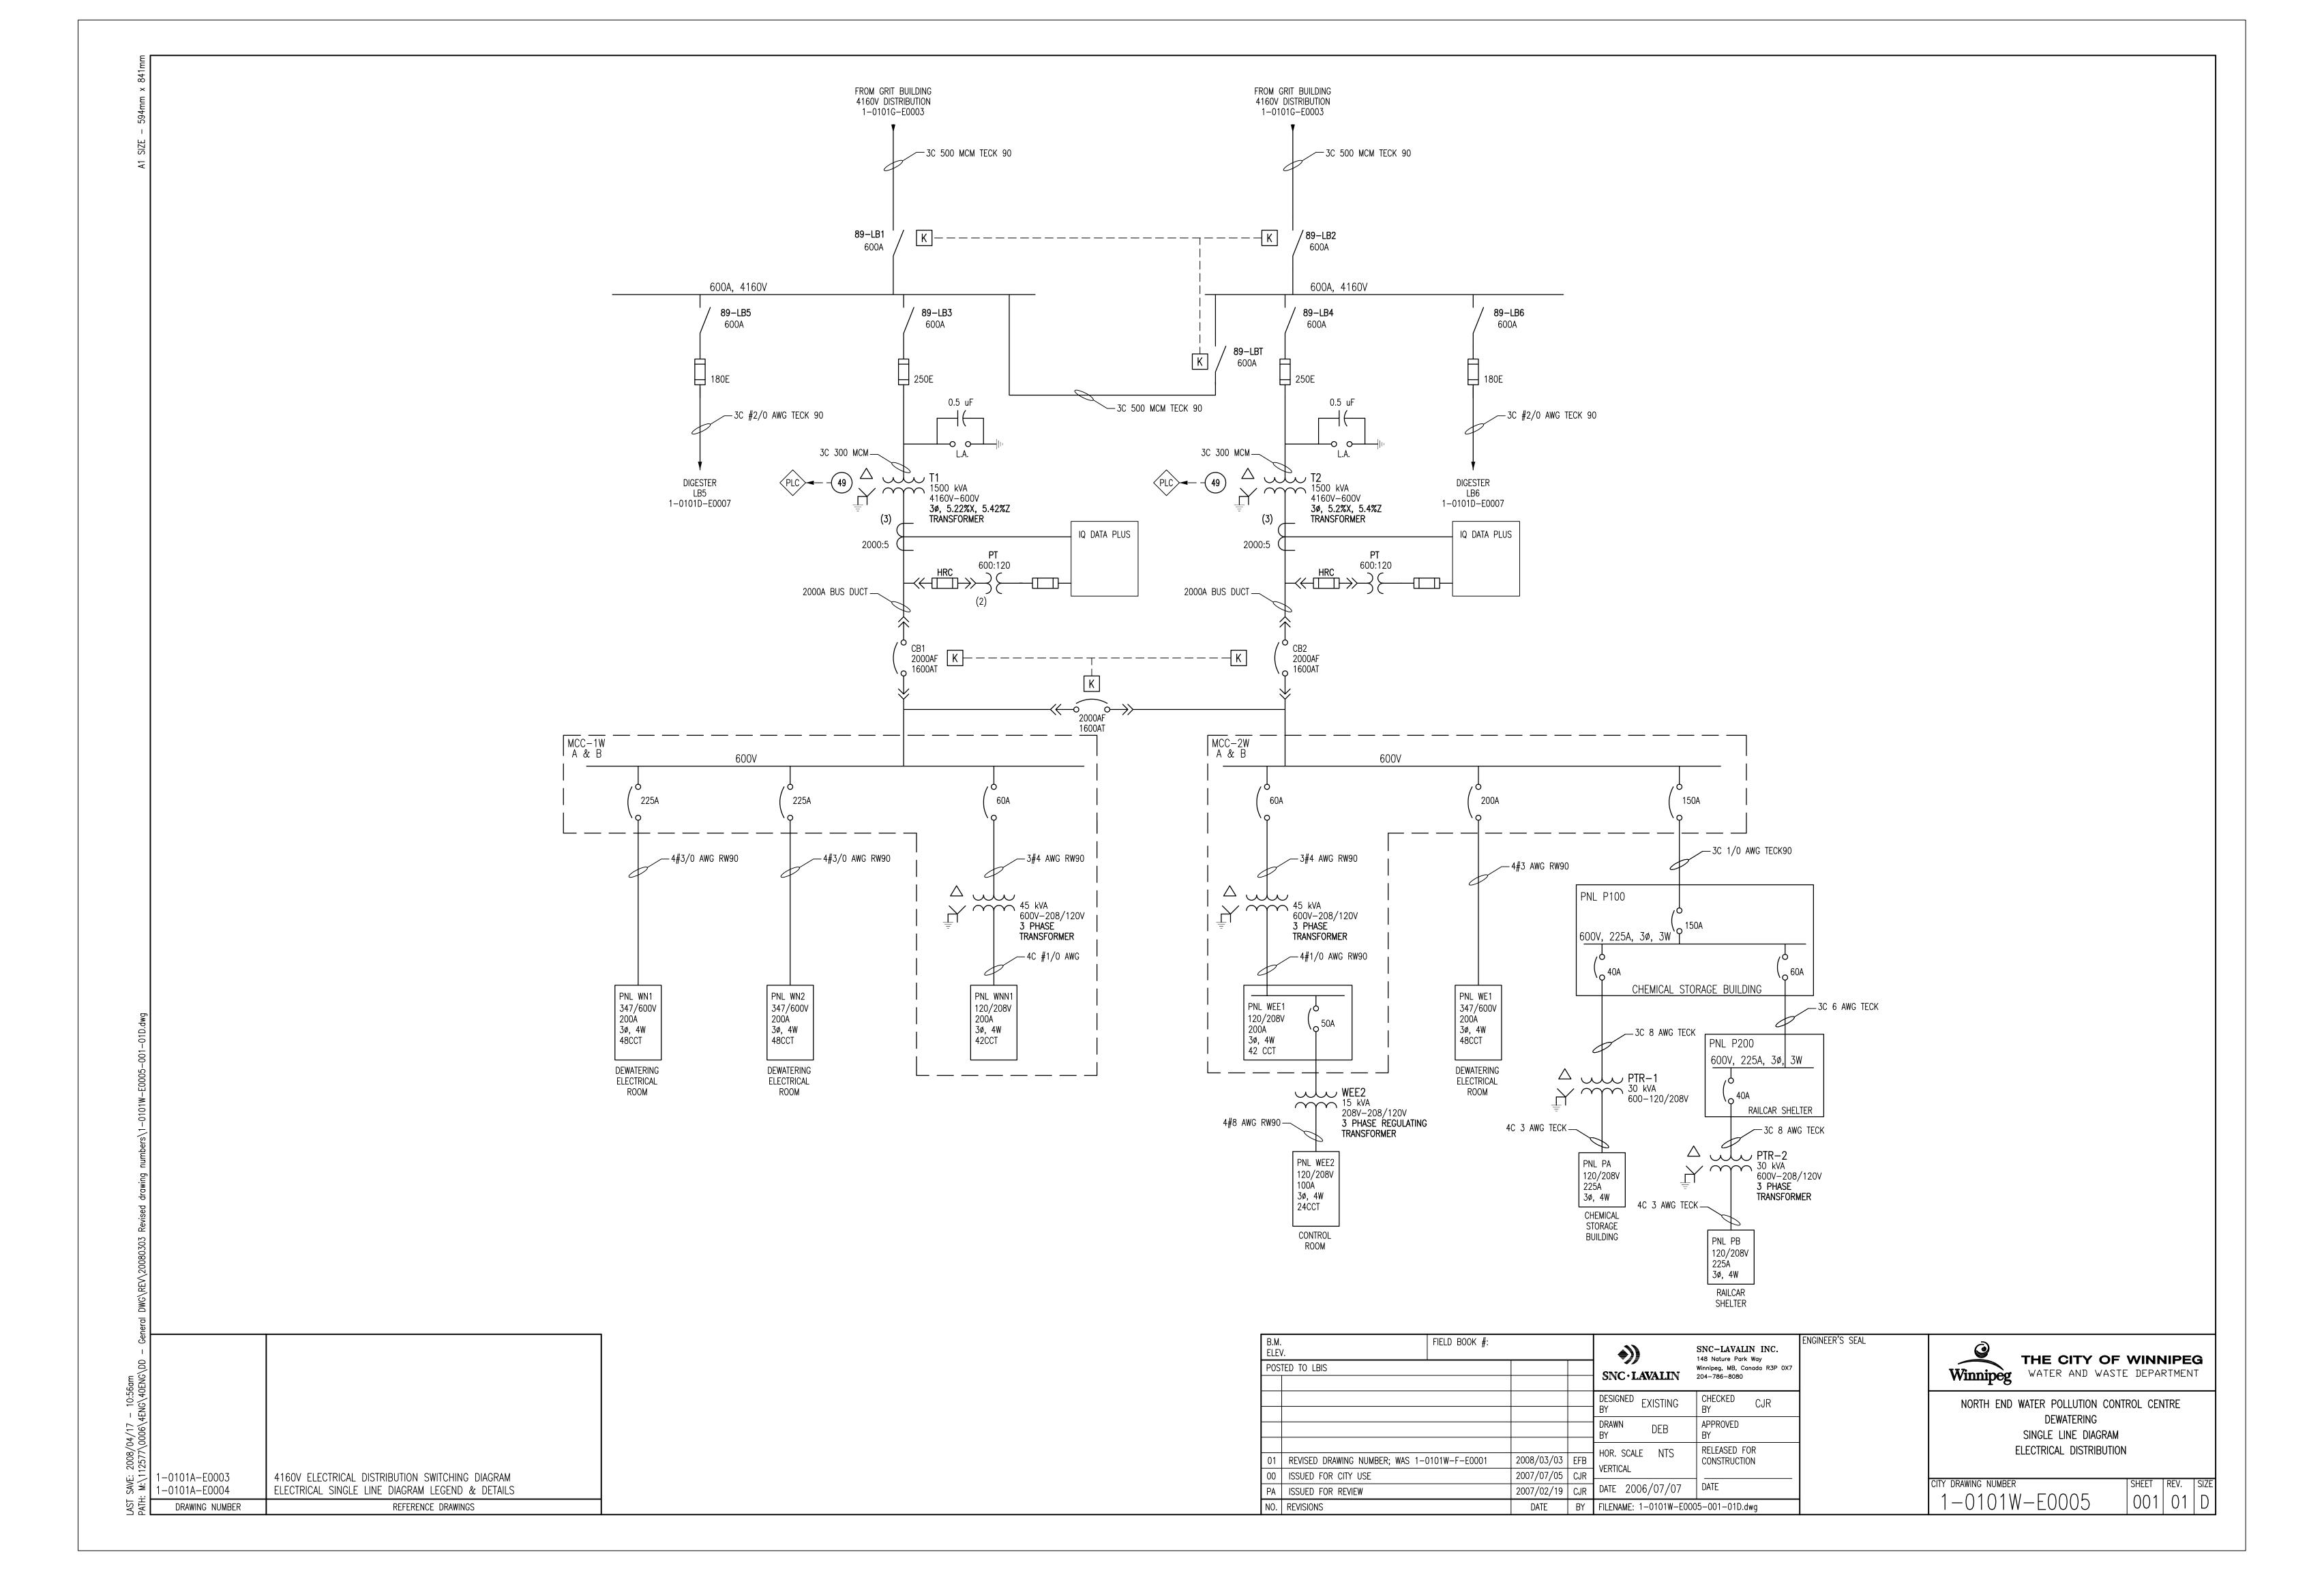

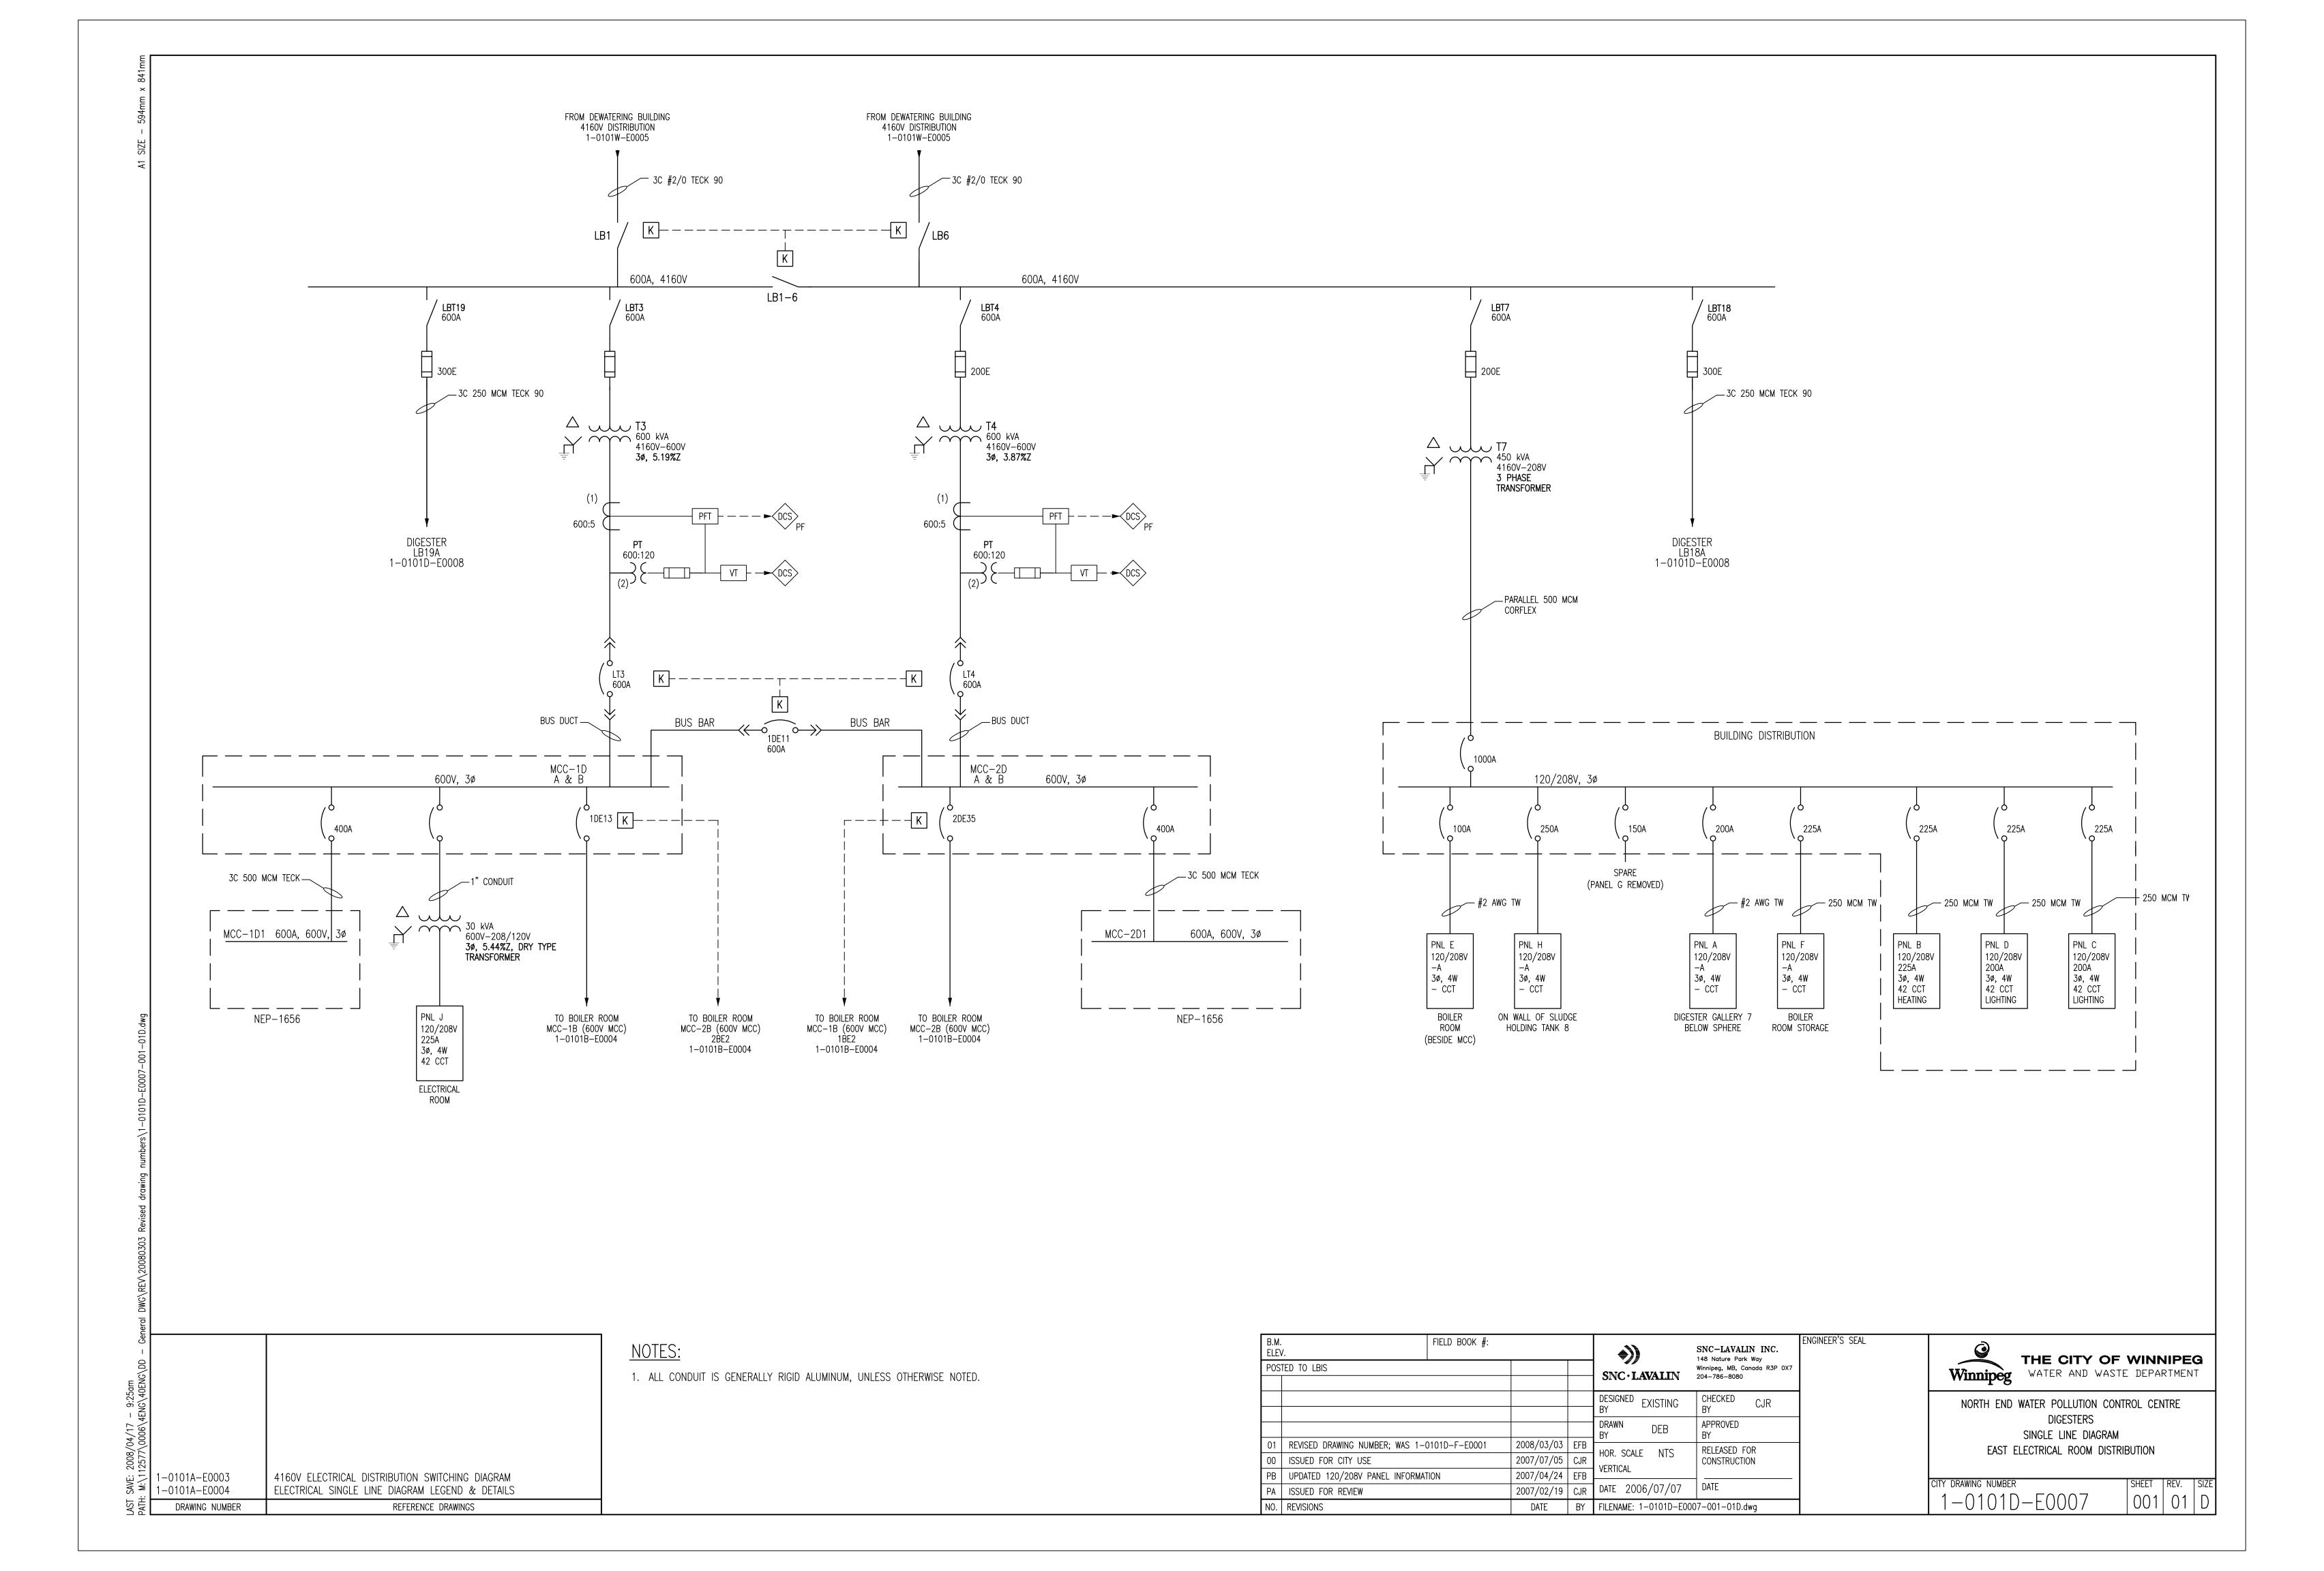


FROM DIGESTER EAST ELECTRICAL RM FROM DIGESTER EAST ELECTRICAL RM 4160V DISTRIBUTION 4160V DISTRIBUTION 1-0101D-E0007 1-0101D-E0007 ✓ 3C 250 MCM TECK 90 3C 250 MCM TECK 90 LB-18A-19A 600A, 4160V 600A, 4160V 600A LBT21 / LBT20 600A 600A ____3C #2 AWG R90 ____3C #2 AWG R90 5kV TECK 5kV TECK T20 500 kVA 500 kVA 4160V-600V 4160V-600V 4160V-600V 3ø, 5.27%X, 5.48%Z 3ø, 5.29%X, 5.49%Z TRANSFORMER TRANSFORMER 600:120 600:120 IN 1" CONDUIT ~_4-1C 350 MCM ~_4-1C 350 MCM R90 TECK R90 TECK CB2 (LABELLED T21/MCC-4D)


MCC 4D


800AF


600AT CB1 (LABELLED T20/MCC-3D) MCC 3D 3800AF 120/208V, 125A SPLITTER 4-1C 350 MCM — CORFLEX ——4−1C 350 MCM CORFLEX $<\!\!<\!\!-\!\!>$ CB3 (LABELLÉD T20-T21) 600AT 60A MCC-4D MCC-3D UPS 3C #6 AWG TECK 90 — COPPER ____3C #3 AWG TECK 90 ___3C 10 AWG 30 kVA 600V-208/120V 3 PHASE ISOLATION TRANSFORMER 75 kVA 600V-208/120V 3ø, 53%Z BYPASS SWITCH TRANSFORMER TRANSFORMER 4C #3 AWG IN CONDUIT 4C 250 MCM TECK 90 PNL R 347/600V 60A 120/208V 100A 120/208V, 200A SPLITTER PNL 1UPS 3ø, 4W 3ø, 4W 120/208V 100A 24 CCT 24 CCT 3ø, 4W 100A OUTSIDE DIGESTER 24 CCT IN ELECTRICAL CONTROL ROOM OUTSIDE DIGESTER CONTROL ROOM NEP-1311 NEP-1311 ✓—4C #2 TECK 90 ___4C 3 AWG IN CONDUIT ___4C 3 AWG IN CONDUIT TO BOILER TO PRIMARY CLARIFIER PNL 3UPS 1-0101P-E0001 PNL 2UPS 1-0101B-E0004 120/208V 225A PNL K 120/208V 225A 3ø, 4W 42 CCT o 50A 3ø, 4W 42 CCT IN ELECTRICAL ROOM FIELD BOOK #: Winnipeg WATER AND WASTE DEPARTMENT NOTES: SNC-LAVALIN INC. 148 Nature Park Way SNC • LAVALIN


Winnipeg, MB, Canada R3P 0X7
204-786-8080 POSTED TO LBIS 1. ALL CONDUIT IS GENERALLY RIGID ALUMINUM, UNLESS OTHERWISE NOTED. DESIGNED EXISTING CHECKED CJR NORTH END WATER POLLUTION CONTROL CENTRE DIGESTERS APPROVED BY DRAWN DEB SINGLE LINE DIAGRAM RELEASED FOR WEST ELECTRICAL ROOM DISTRIBUTION HOR. SCALE NTS REVISED DRAWING NUMBER; WAS 1-0101D-F-E0002 2008/03/03 EFB CONSTRUCTION 1-0101D-E0007 DIGESTERS SINGLE LINE DIA. 4160 ELECTRICAL DISTRIBUTION VERTICAL 2007/07/05 CJR 1-0101A-E0003 4160V ELECTRICAL DISTRIBUTION SWITCHING DIAGRAM 0 | ISSUED FOR CITY USE CITY DRAWING NUMBER 2007/02/19 CJR DATE 2006/07/07 DATE 1-0101A-E0004 ELECTRICAL SINGLE LINE DIAGRAM LEGEND & DETAILS PA ISSUED FOR REVIEW 001 01 D DATE BY | FILENAME: 1-0101D-E0008-001-01D.dwg DRAWING NUMBER REFERENCE DRAWINGS NO. REVISIONS

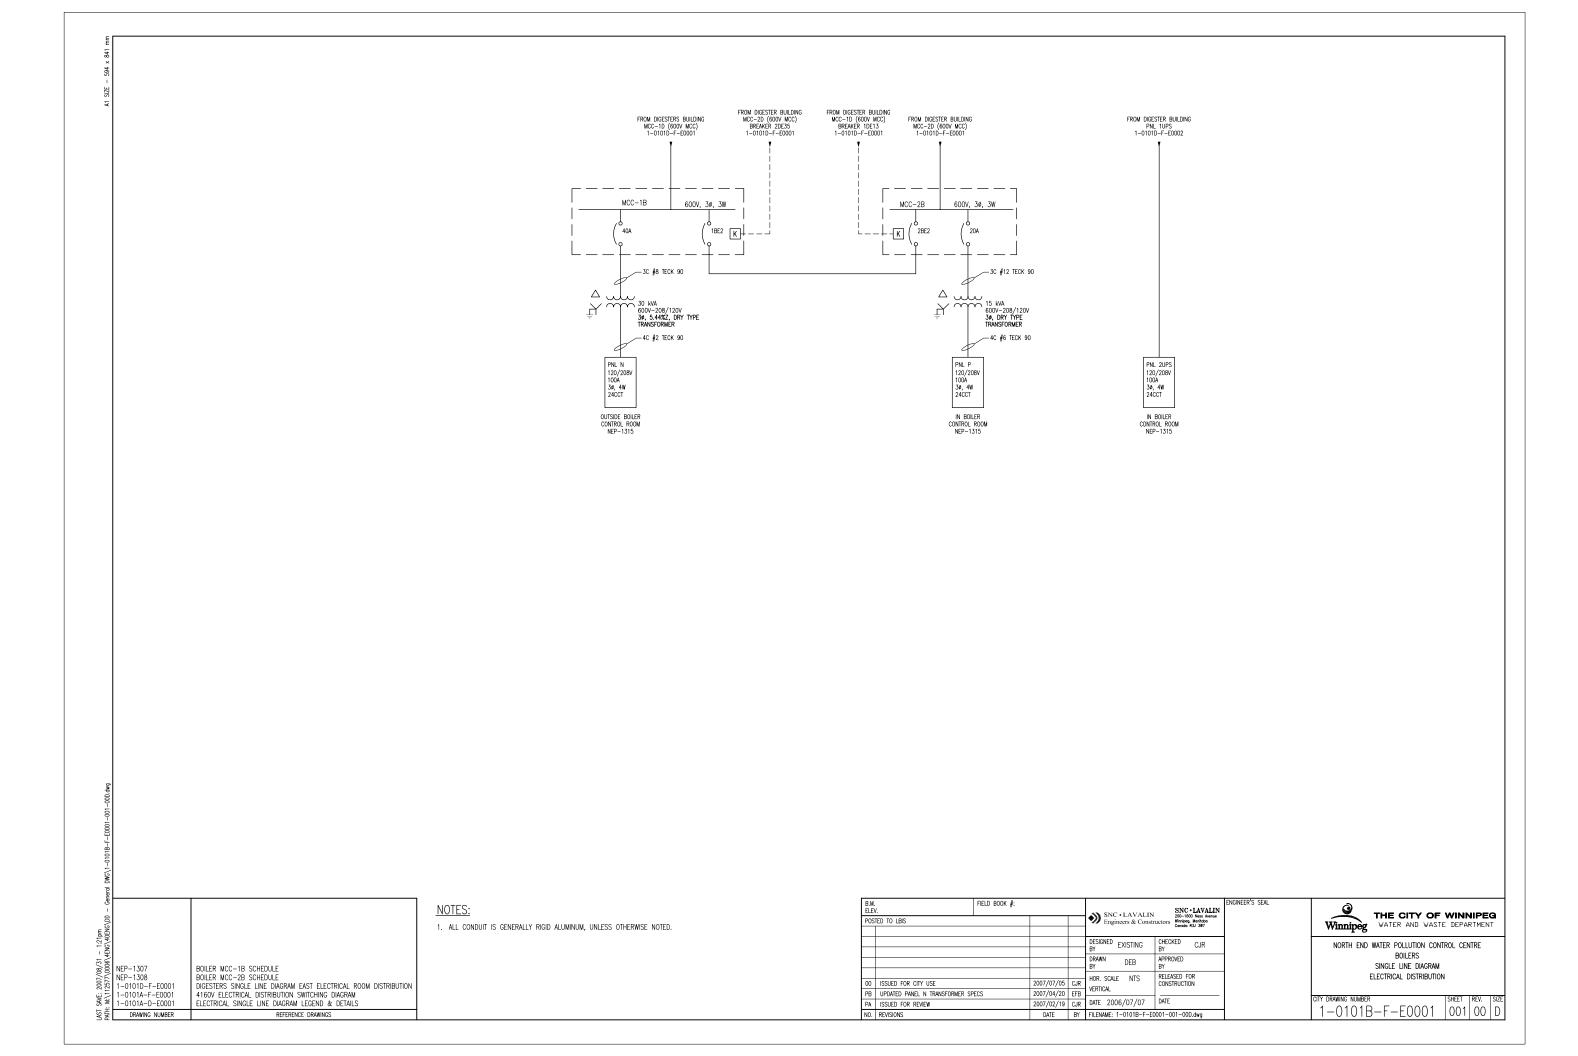

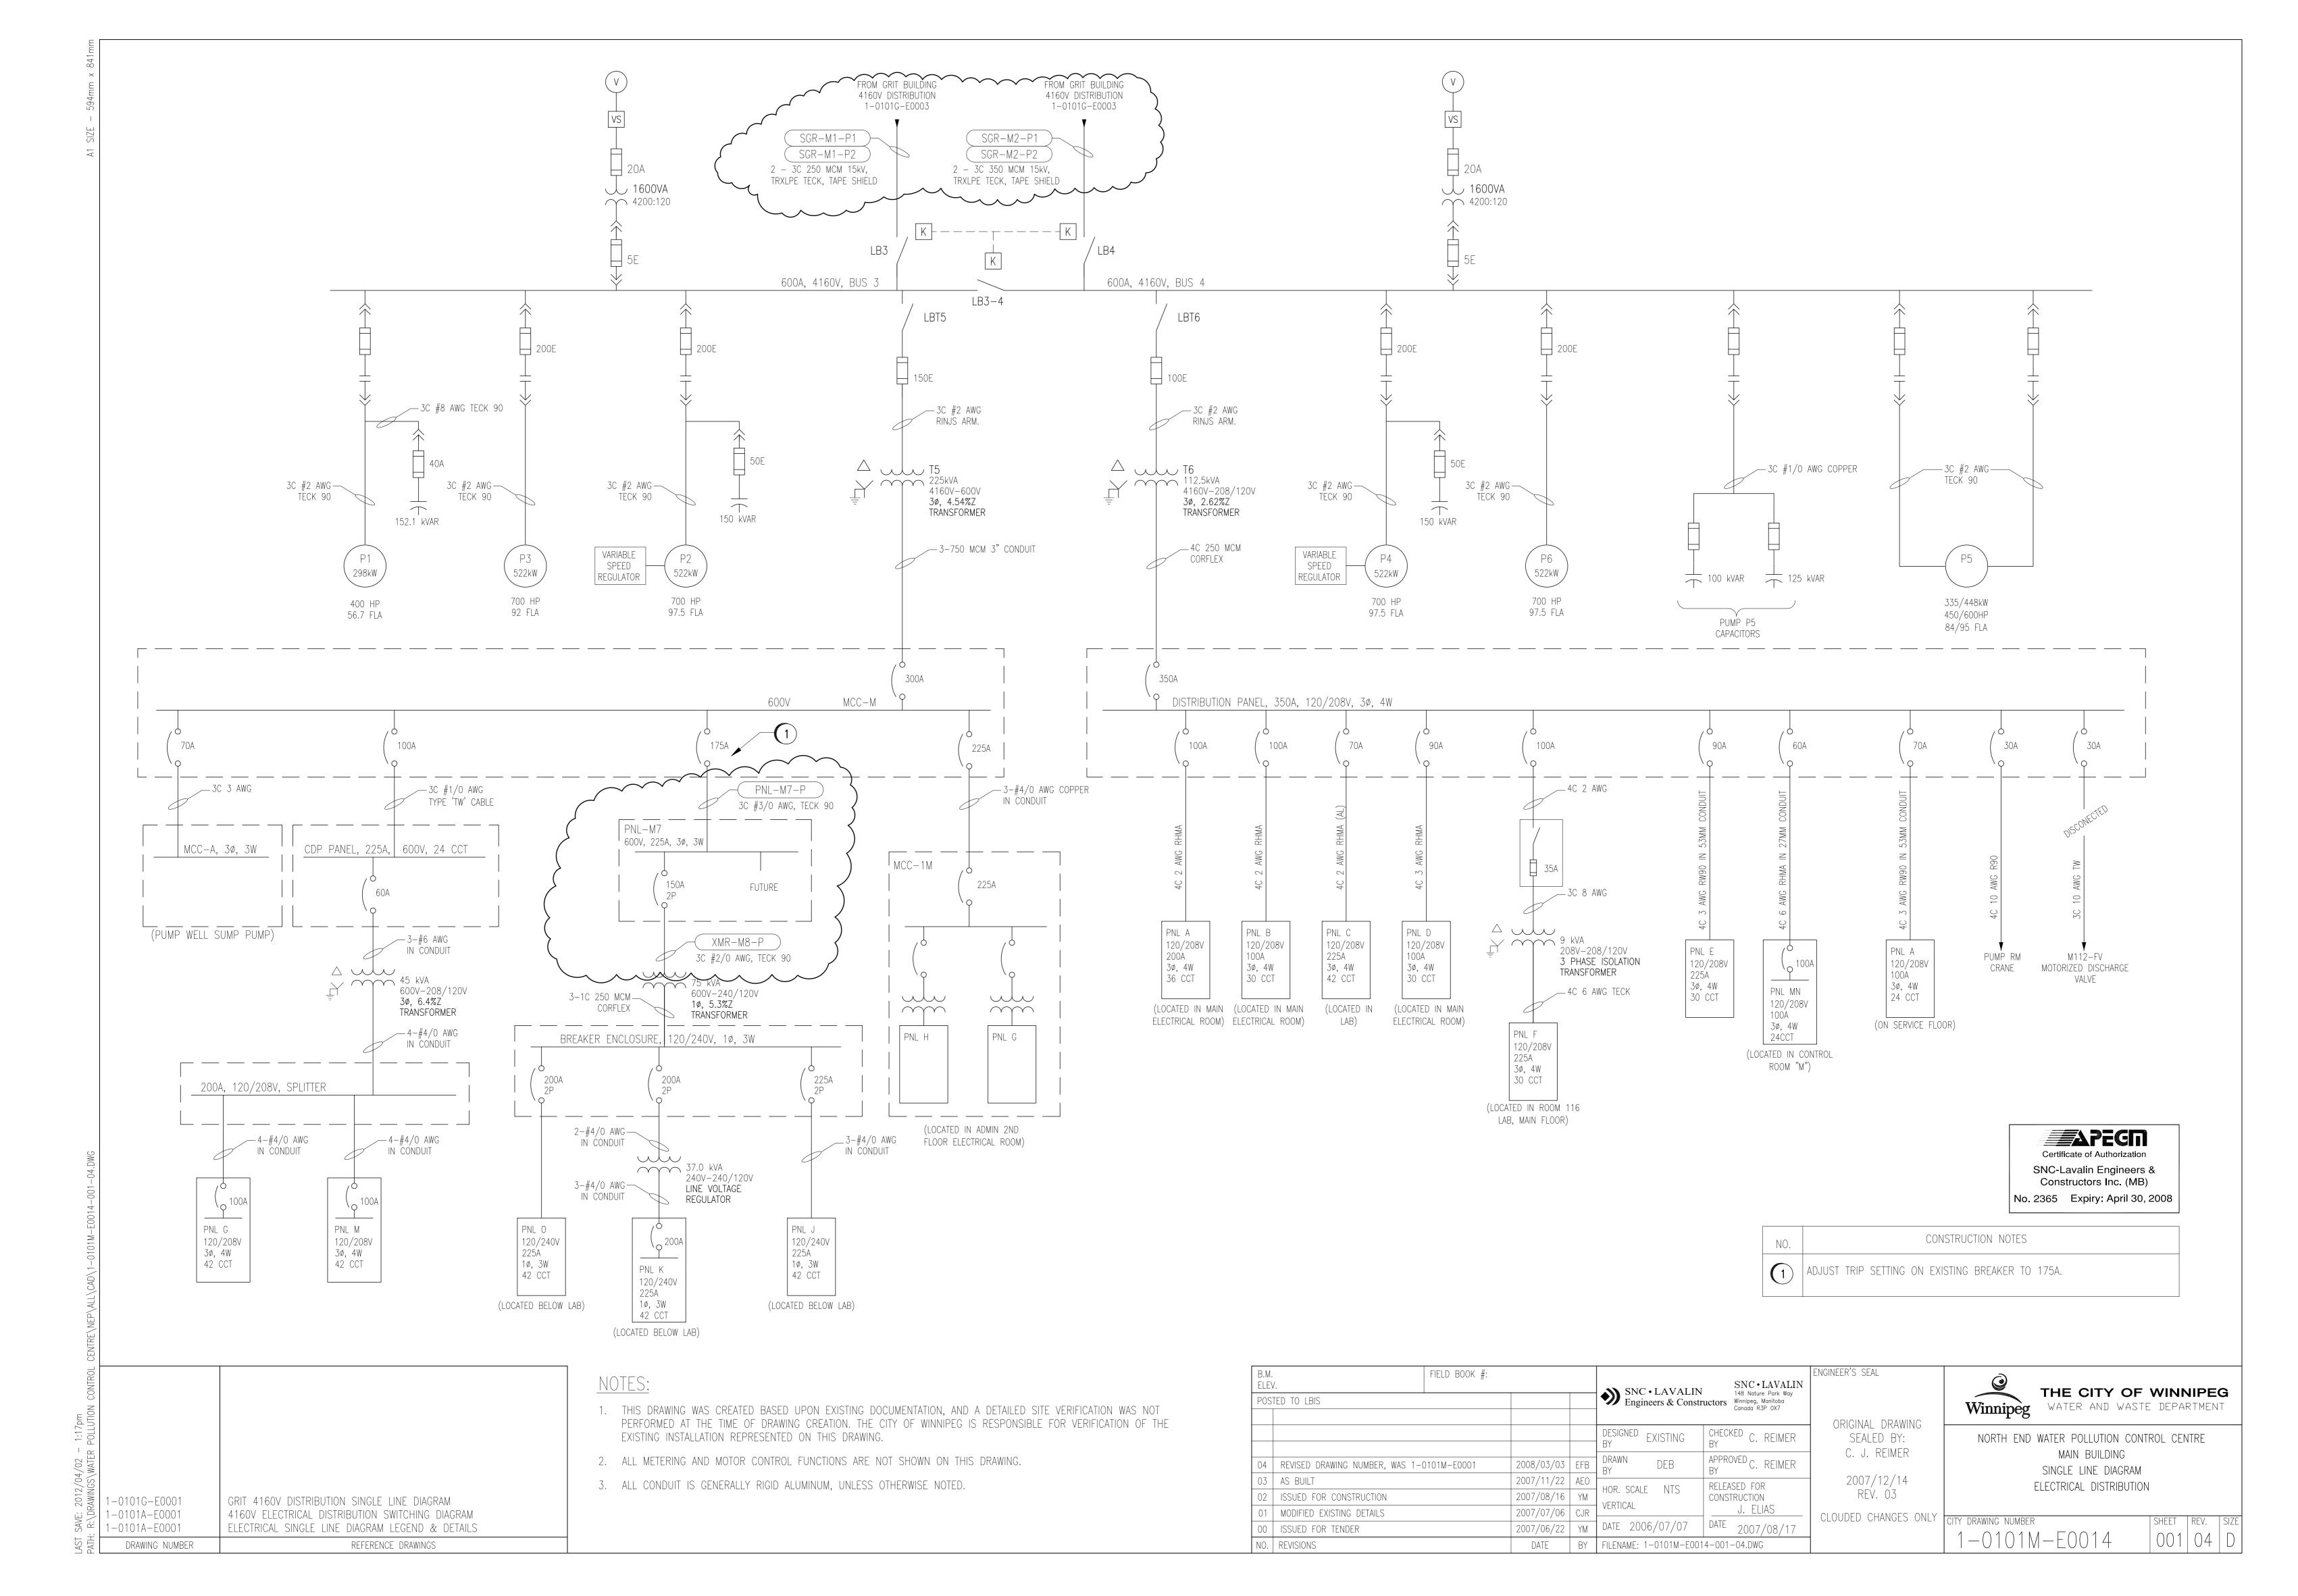

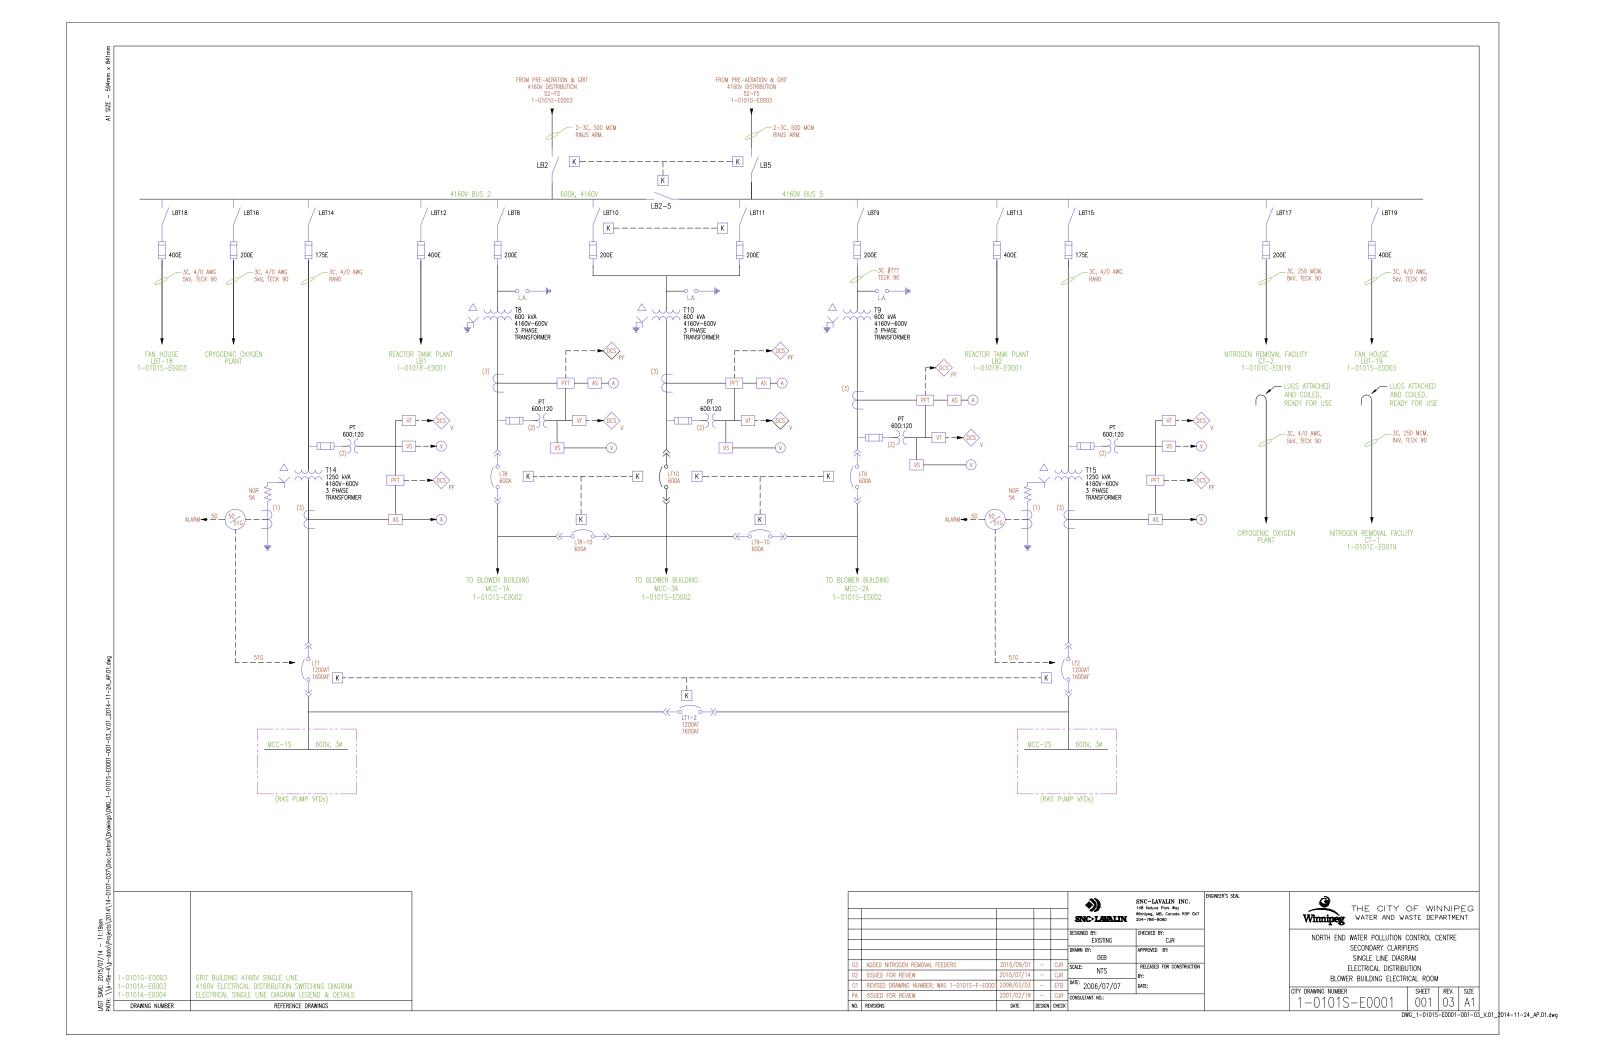

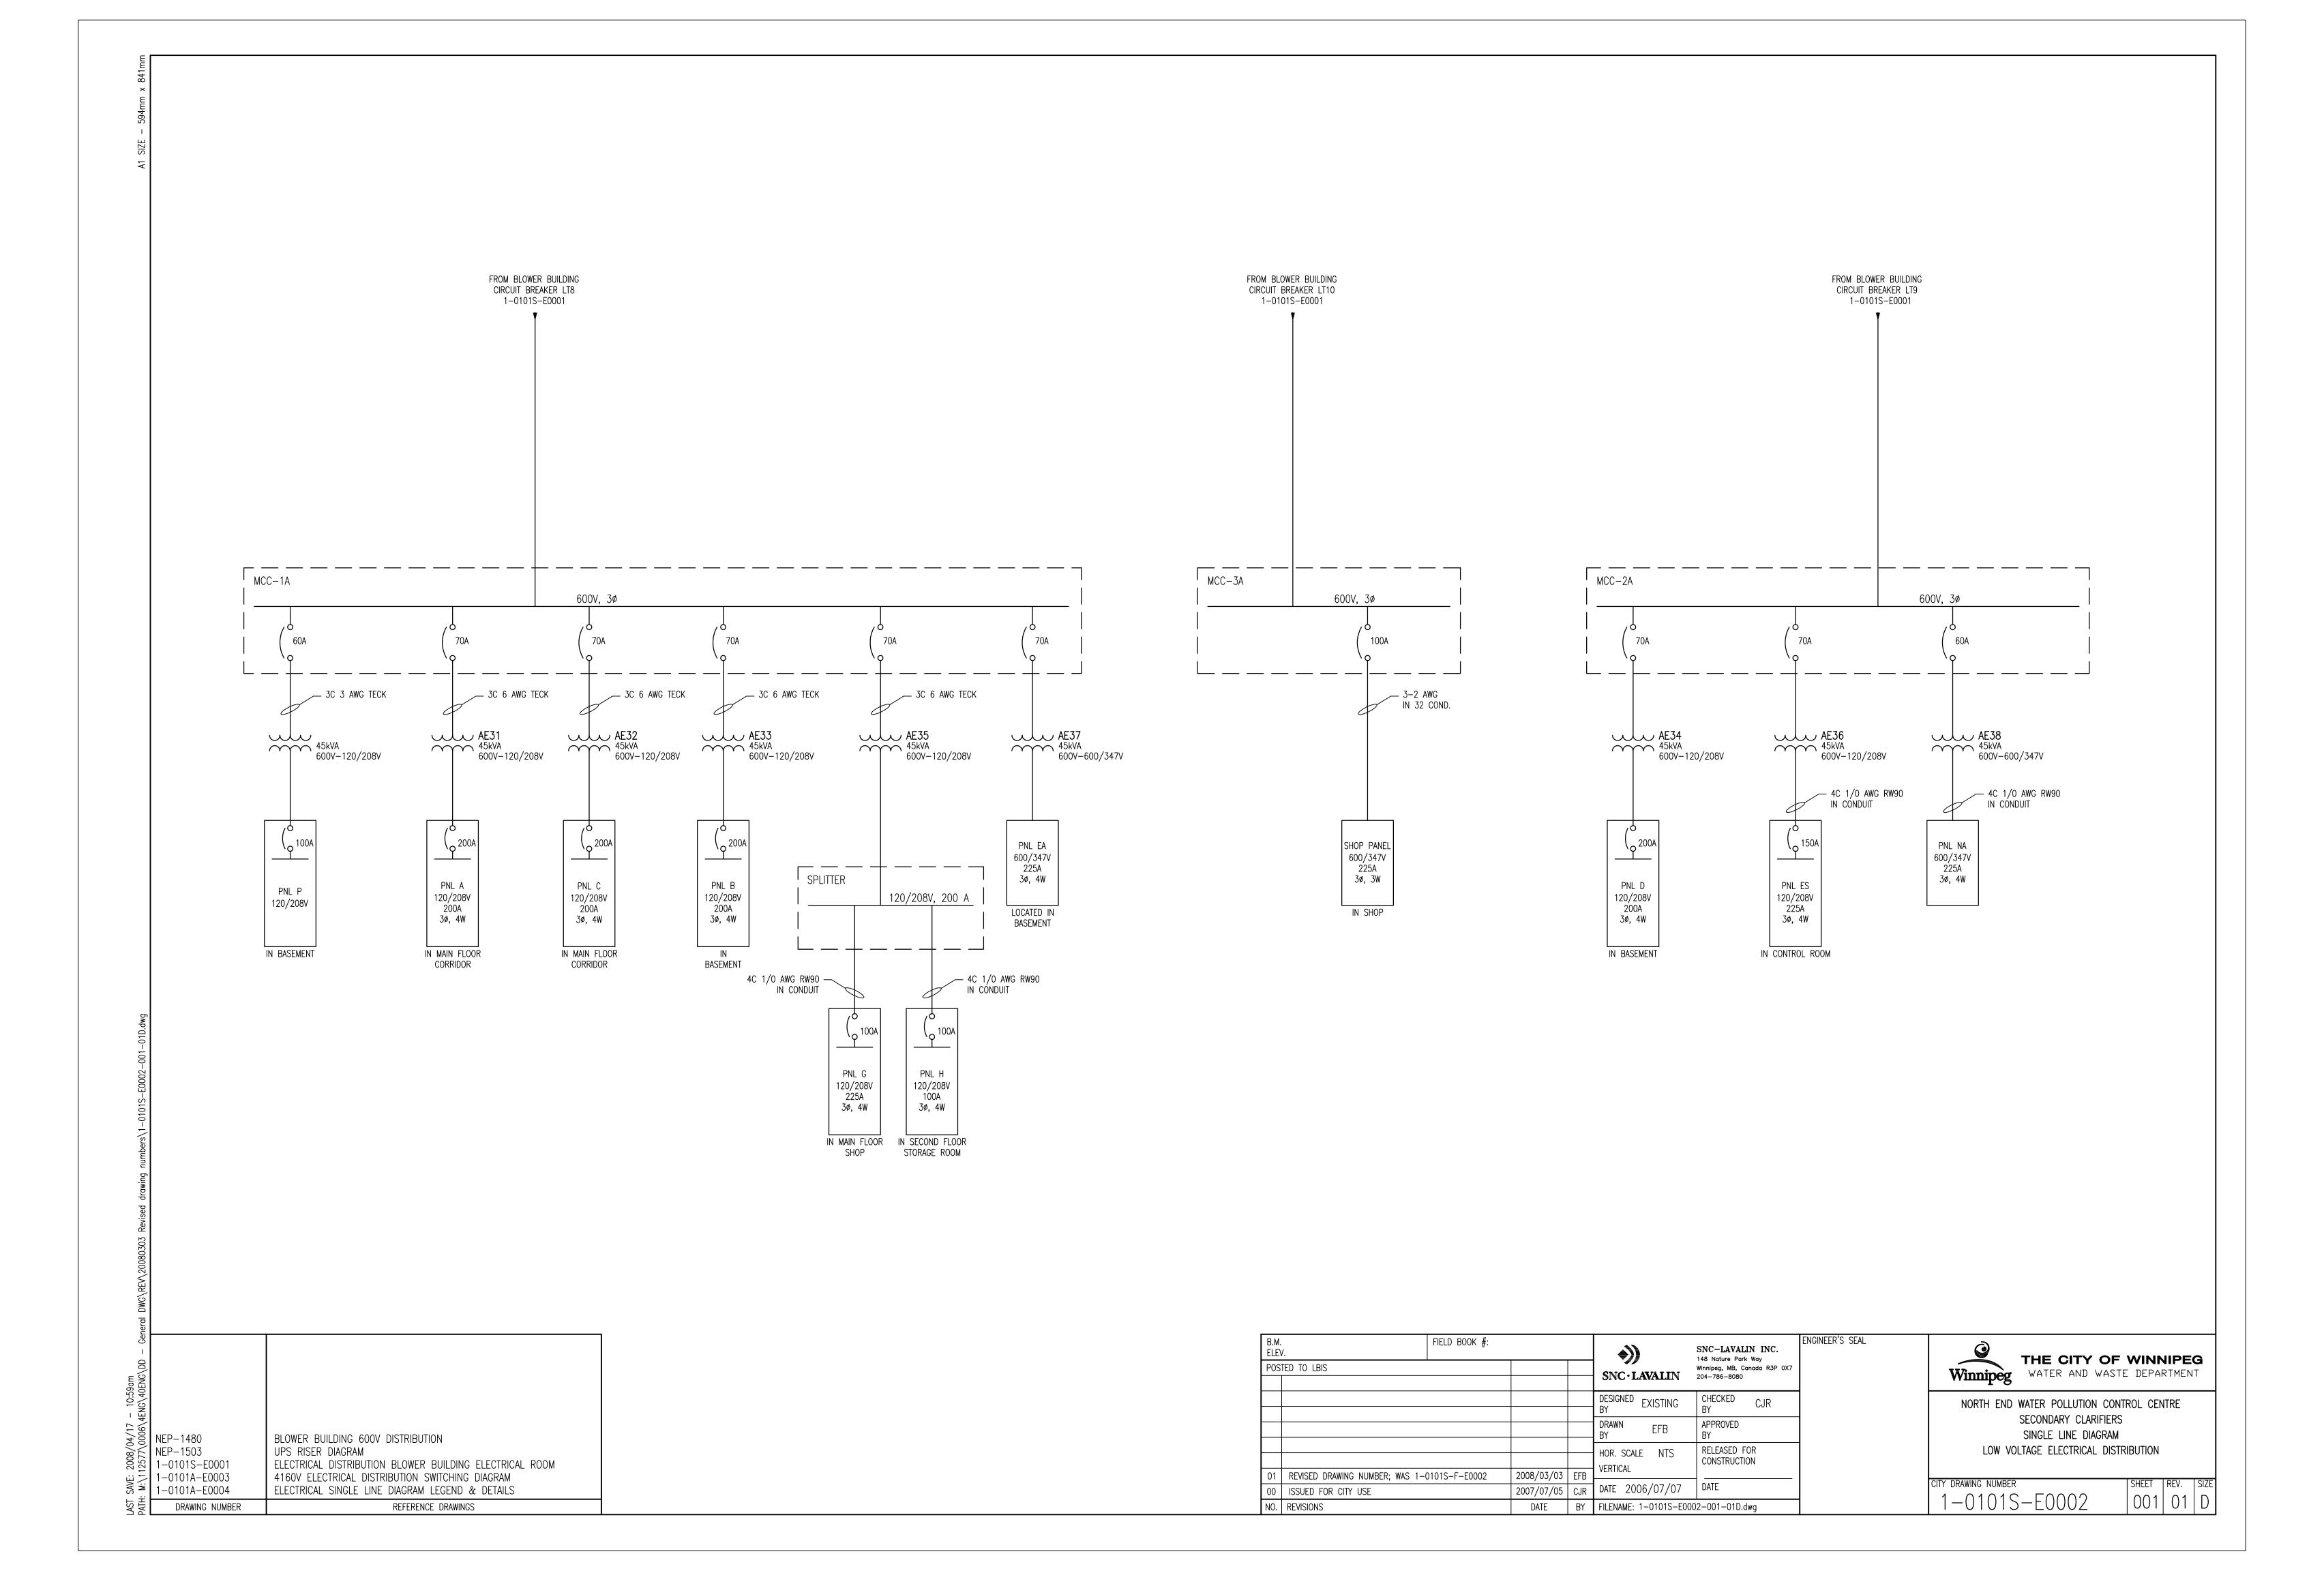

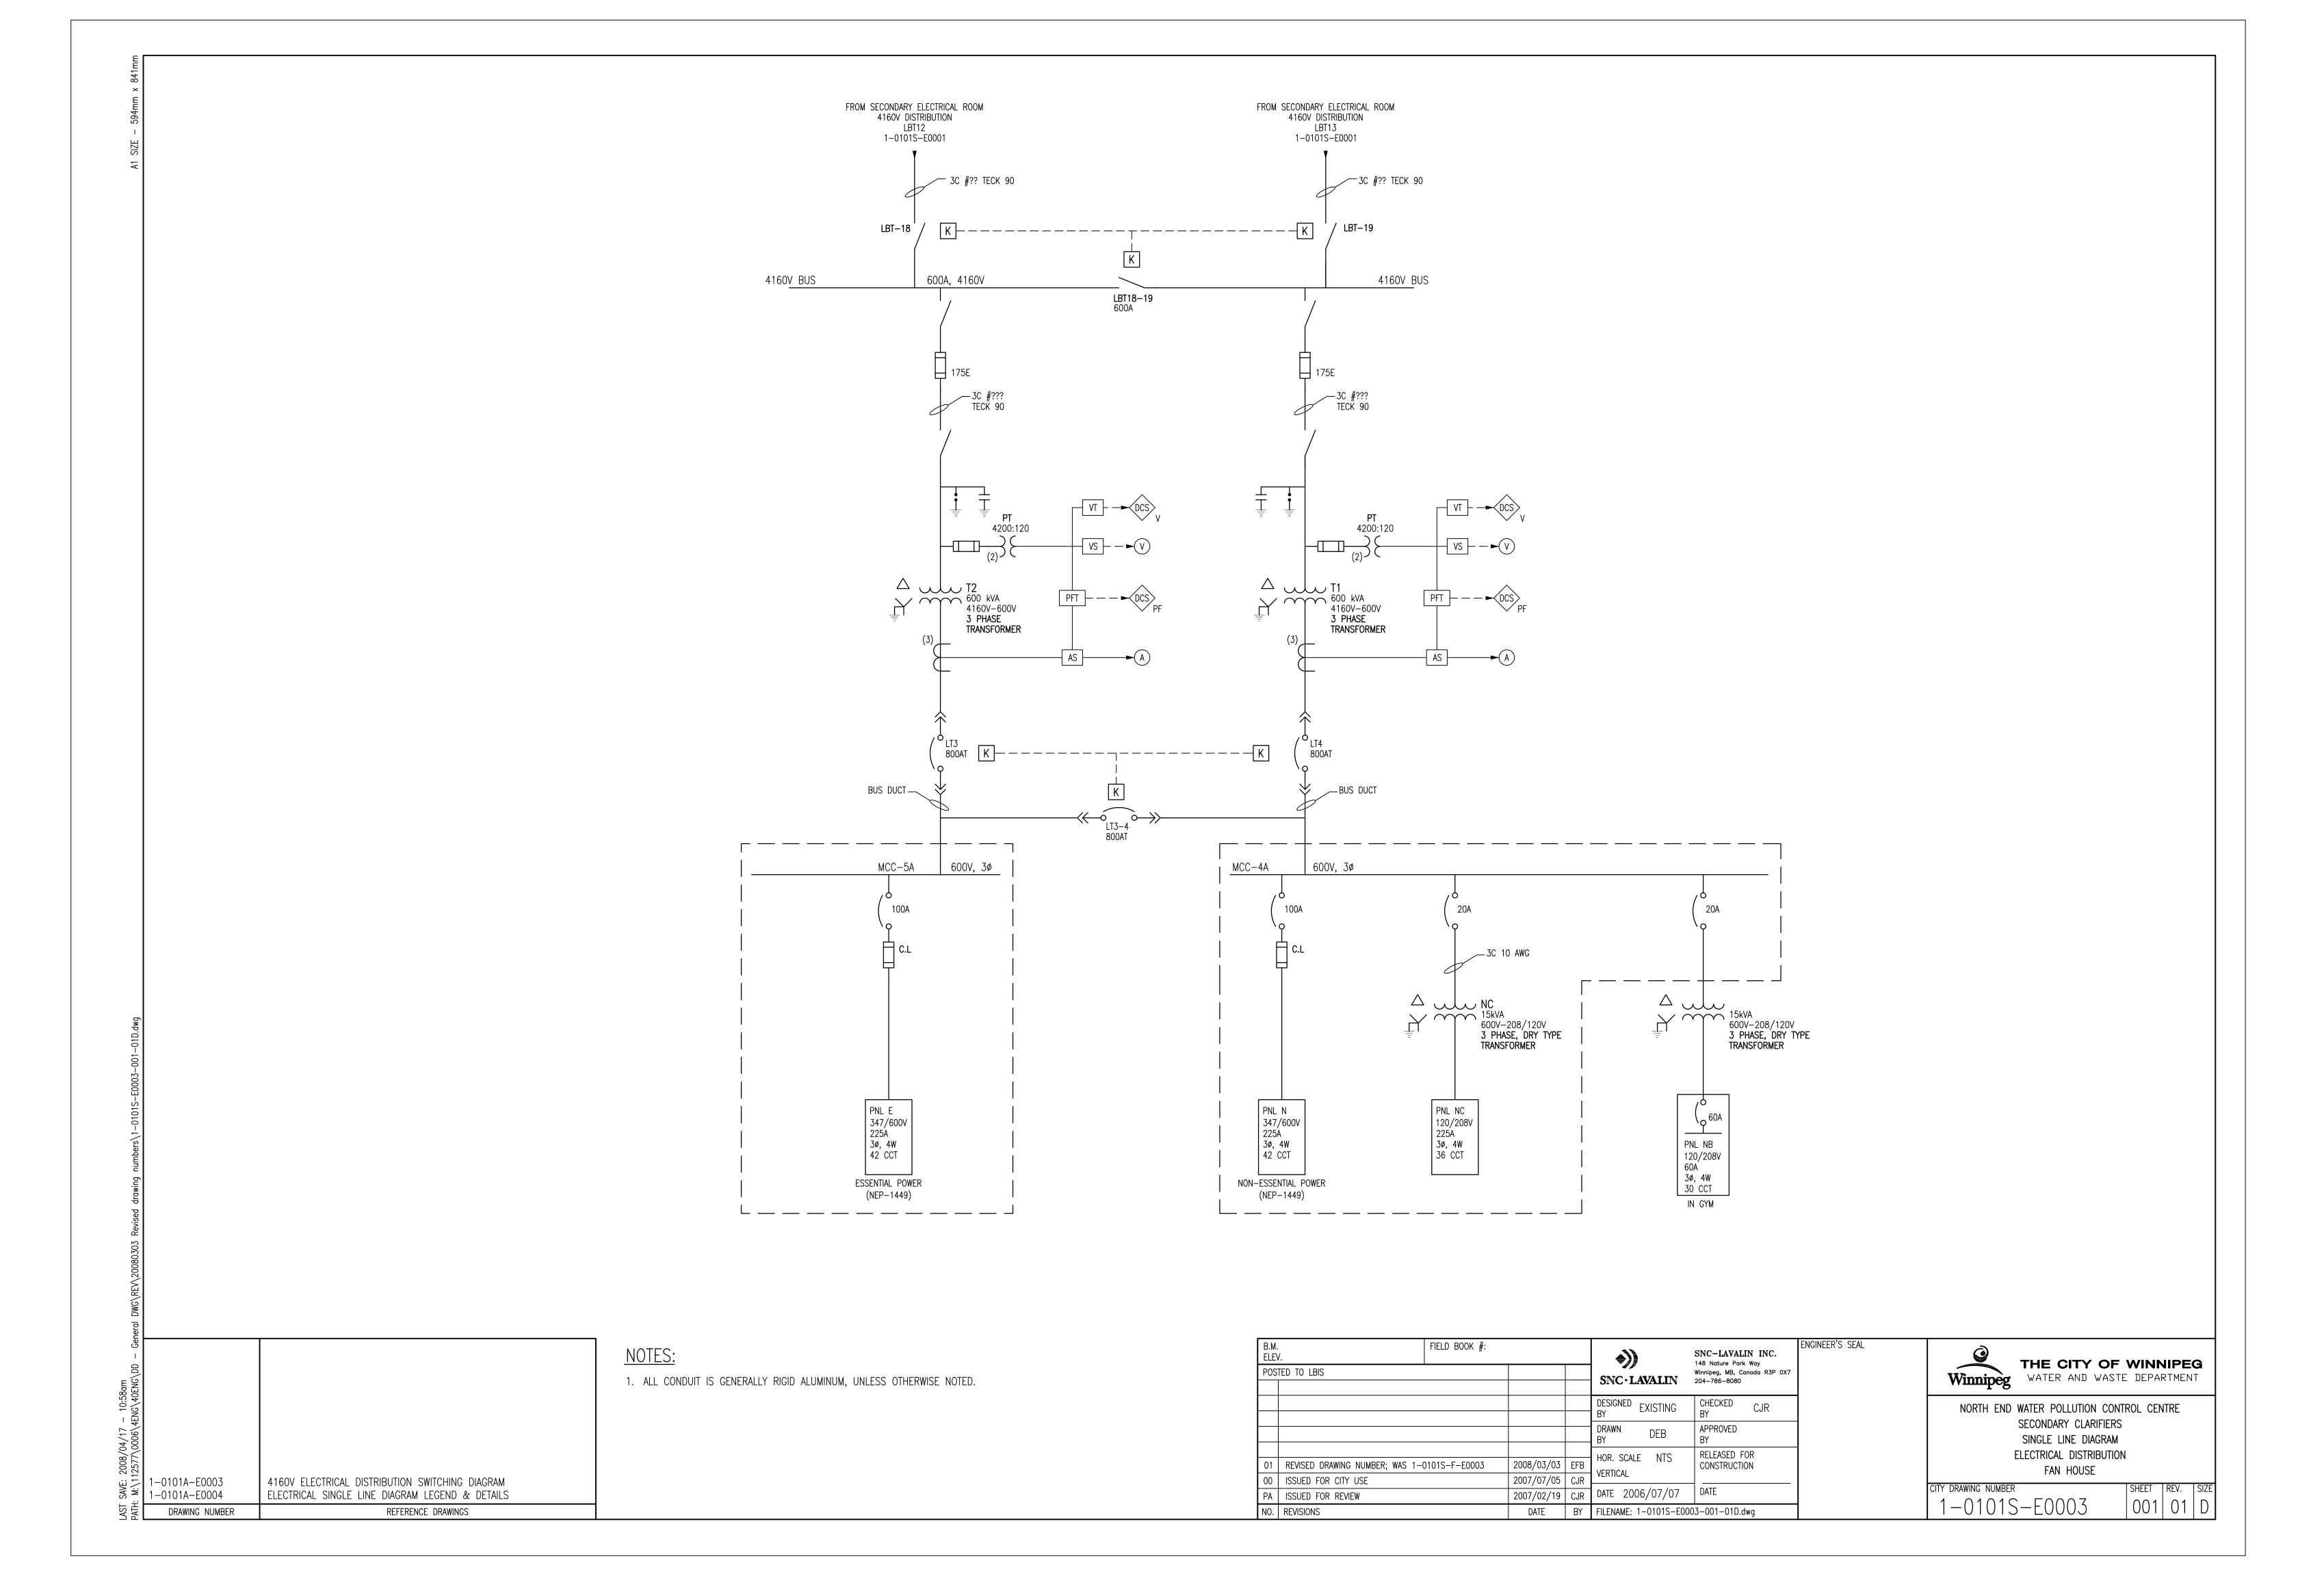

FROM SECONDARY ELECTRICAL ROOM FROM SECONDARY ELECTRICAL ROOM 4160V DISTRIBUTION LBT12 4160V DISTRIBUTION 1-0101S-E0001 1-0101S-E0001 ___3C-350 MCM TECK 90 ___3C-350 MCM TECK 90 **LB1** 600A K-----K **LB2** 600A 4160V BUS 600A, 4160V 4160V BUS ′ LB1−2 600A 3C-350 MCM TECK 90 T1 1000 kVA 4160V-600V T2 1000 kVA 4160V-600V 4160V-600V 4160V-600V 3 PHASE 3 PHASE TRANSFORMER TRANSFORMER 600:120 600:120 1200AT K ---- K 1200AT 1600AF __6-750 MCM RW90 __6-750 MCM RW90 IN 2-100mm PVC CONDUIT IN 2-100mm PVC CONDUIT 1200AT 1600AF 600V, 1200A MCC-2R 600V, 1200A MCC-1R 1RE13 125A 2RE2 100A 2RE6 125A ____3-#2 AWG RW90 IN CONDUIT 1RE1 45 kVA 600V-208/120V 3 PHASE, DRY TYPE 2RE8 45 kVA 600V-208 75 kVA 600V-208 600V-208/120V 3 PHASE, DRY TYPE 600V-208/120V 3 PHASE, DRY TYPE TRANSFORMER TRANSFORMER TRANSFORMER ___4-250 MCM IN CONDUIT 120/208V 225A 3ø, 4W 120/208V 225A 400A, 120/208V, SPLITTER 42 CCT 42 CCT 4-#3/0 AWG RW90 IN CONDUIT 4-#3/0 AWG RW90 IN CONDUIT ESSENTIAL POWER NORMAL POWER (NEP-1097) (NEP-1098) ^{125A} PNL H 120/208V 225A 120/208V 225A 3ø, 4W 42 CCT 42 CCT IN ELECTRICAL ROOM IN ELECTRICAL ROOM (NEP-1091) (NEP-1091) ENGINEER'S SEAL FIELD BOOK #: Winnipeg THE CITY OF WINNIPEG WATER AND WASTE DEPARTMENT SNC-LAVALIN INC. 148 Nature Park Way SNC • LAVALIN
Winnipeg, MB, Canada R3P 0X7
204-786-8080 POSTED TO LBIS 1. ALL CONDUIT IS GENERALLY RIGID ALUMINUM, UNLESS OTHERWISE NOTED. DESIGNED EXISTING CHECKED CJR NORTH END WATER POLLUTION CONTROL CENTRE REACTORS APPROVED BY DRAWN DEB SINGLE LINE DIAGRAM RELEASED FOR ELECTRICAL DISTRIBUTION HOR. SCALE NTS REVISED DRAWING NUMBER; WAS 1-0101R-F-E0001 2008/03/03 EFB CONSTRUCTION VERTICAL 2007/07/05 CJR 1-0101A-E0003 4160V ELECTRICAL DISTRIBUTION SWITCHING DIAGRAM 0 | ISSUED FOR CITY USE CITY DRAWING NUMBER 2007/02/19 CJR DATE 2006/07/07 DATE ELECTRICAL SINGLE LINE DIAGRAM LEGEND & DETAILS 1-0101A-E0004 PA ISSUED FOR REVIEW 001 01 D NO. REVISIONS DATE BY | FILENAME: 1-0101R-E0001-001-01D.dwg DRAWING NUMBER REFERENCE DRAWINGS

