


PRIMARY CLARIFIER NO. 1


PRIMARY CLARIFIER NO. 2

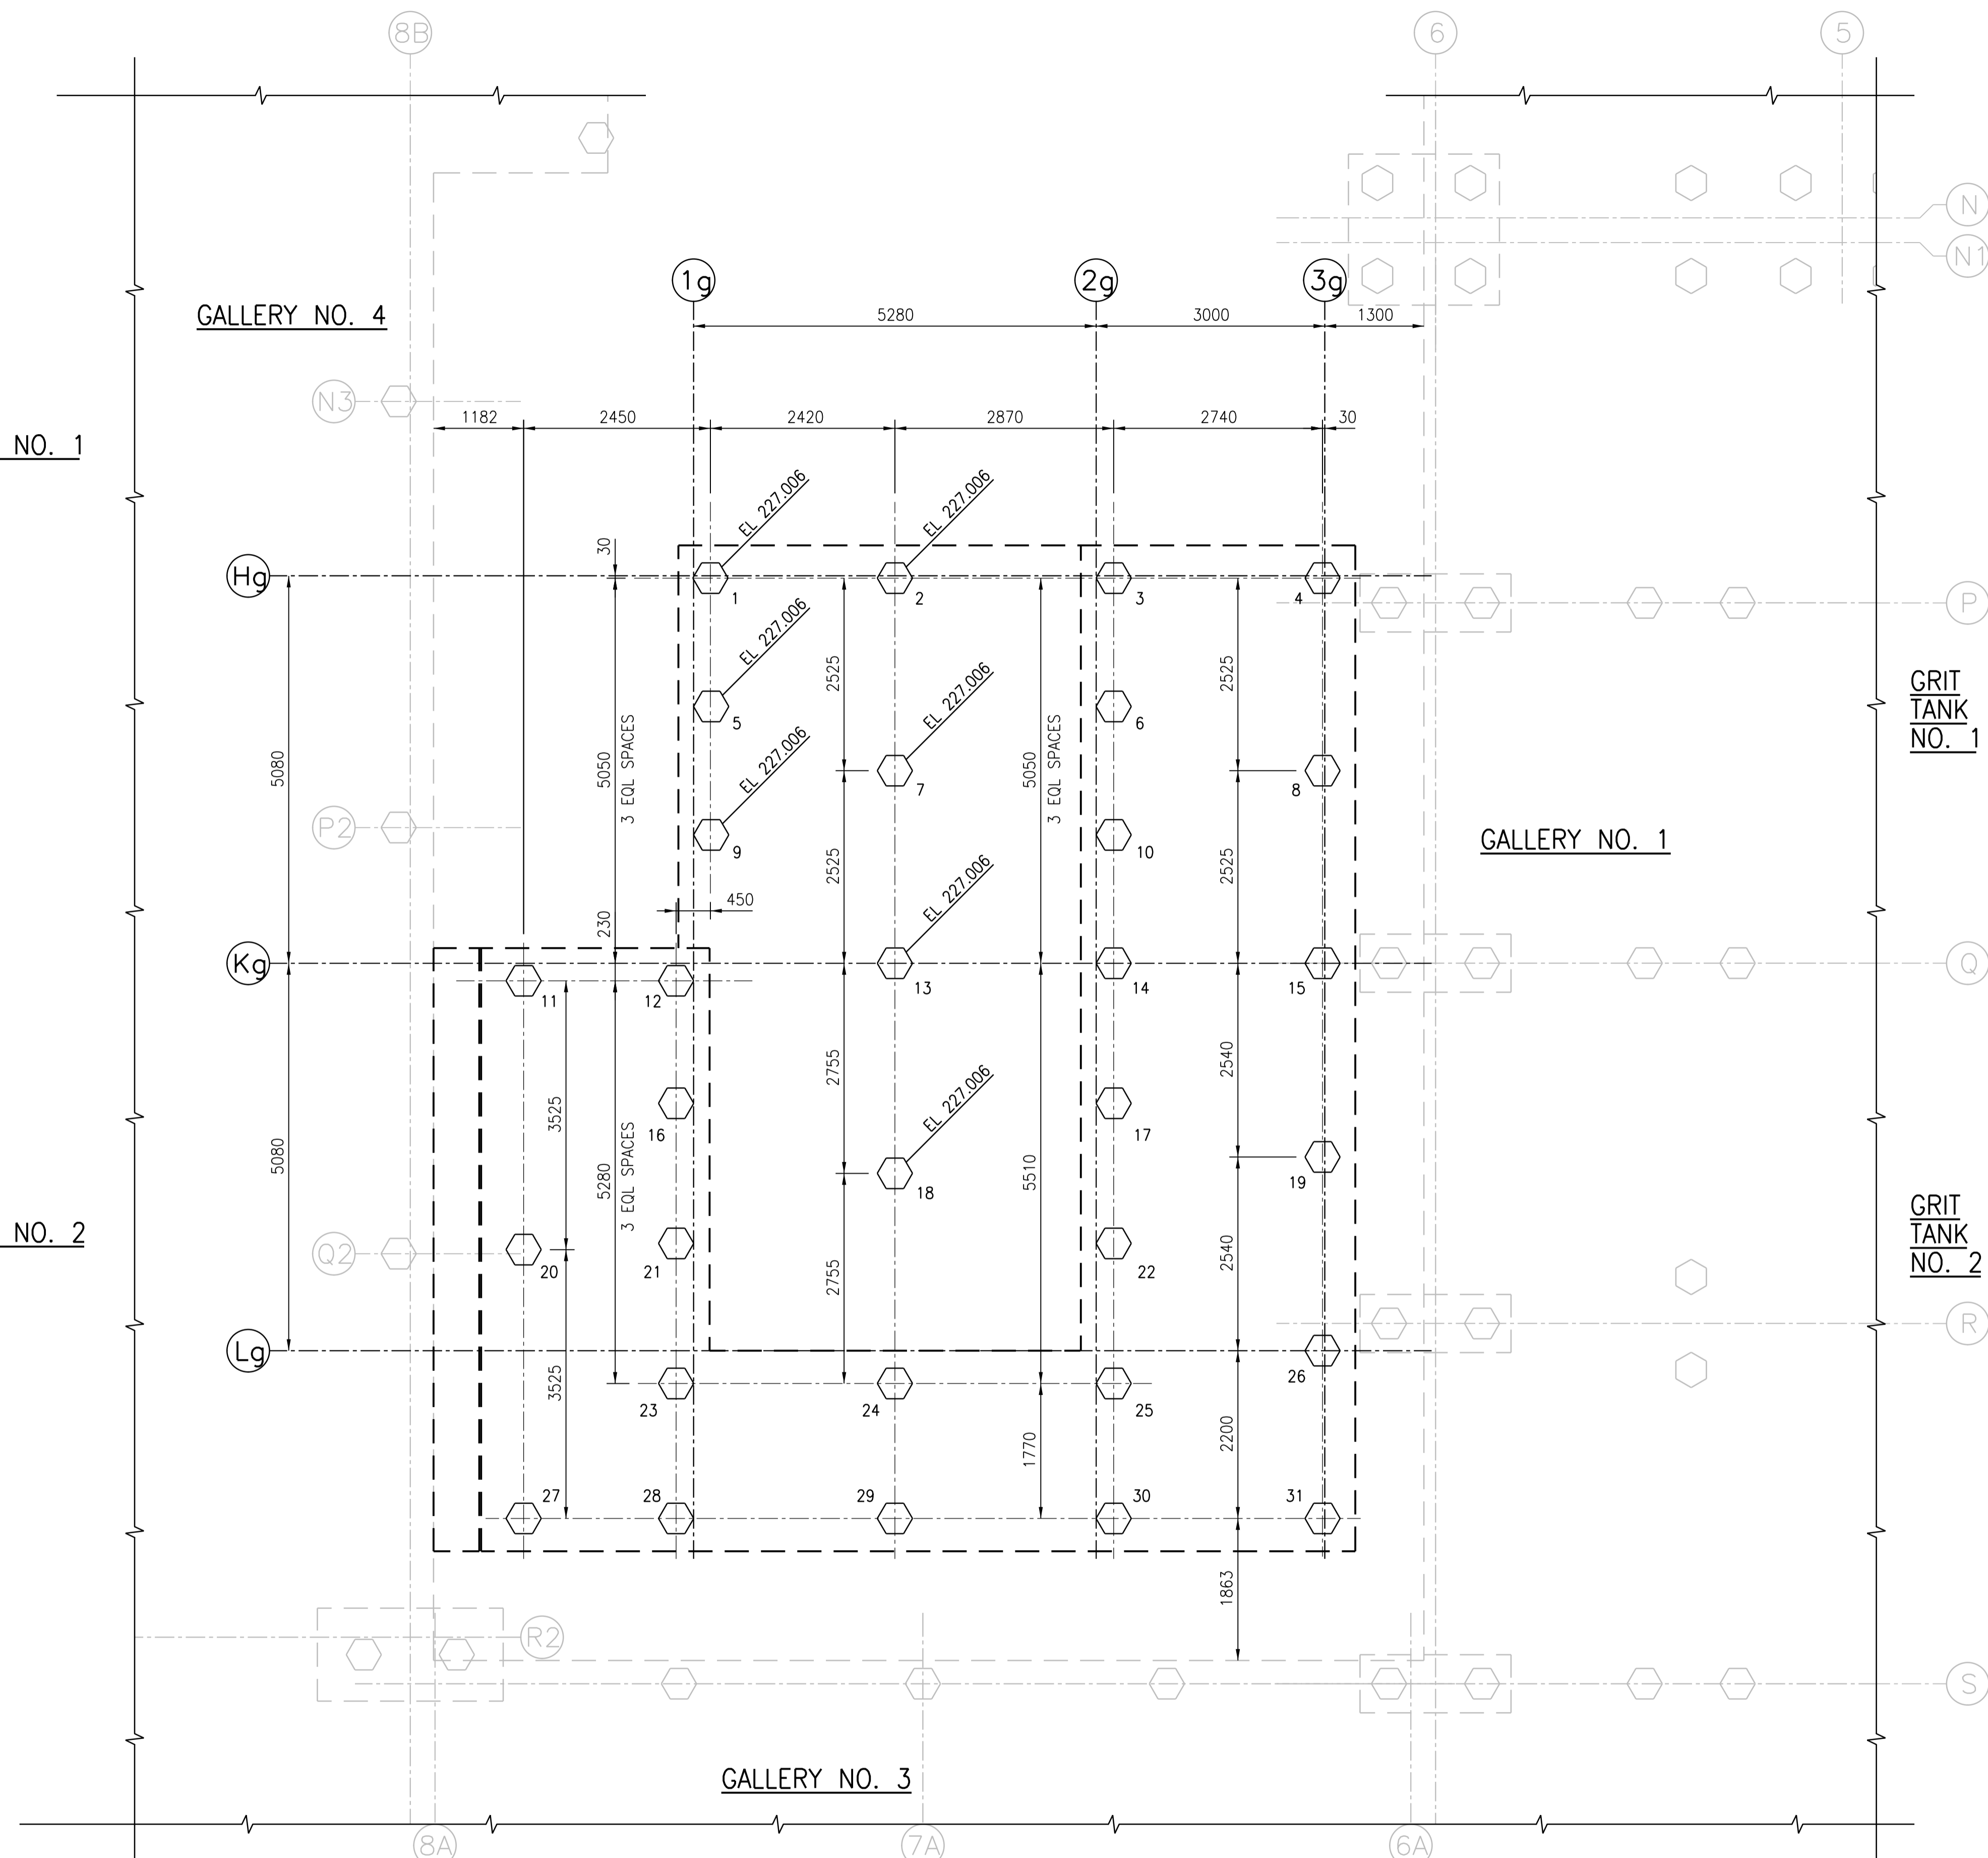

NOTES:

1. REFER TO DWG 1-0102-SGAD-A001 FOR GENERAL NOTES.
2. REFER TO DWG 1-0102-SGAD-A002 FOR OVERALL SITE PLAN AND SEQUENCING.
3. PILE DIAMETER (D) = 400mm
4. PILE CUT-OFF ELEVATION = 227.553 UNLESS NOTED OTHERWISE.
5. ESTIMATED PILE REFUSAL EL 212.000

PILING PLAN
1:50

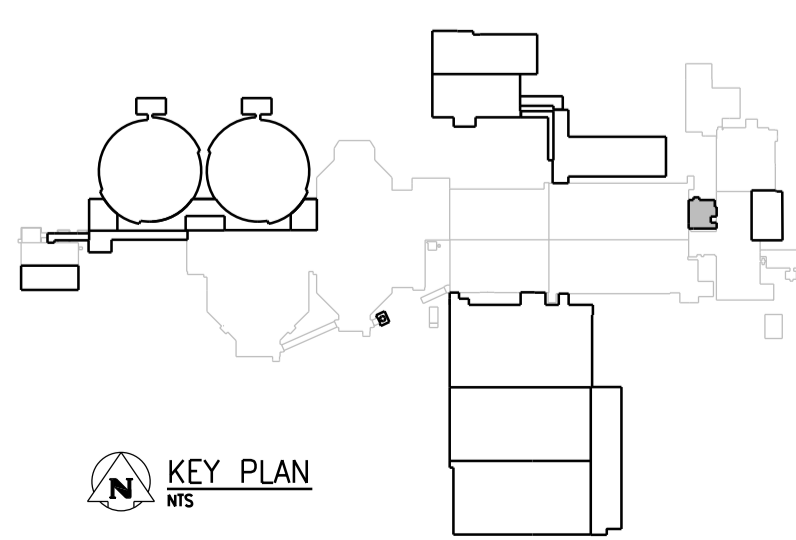


NO.	REVISIONS	DATE	DESIGN	CHECK
00	ISSUED FOR TENDER	06/2014	G.O.	B.W.

CH2MHILL
SNC-LAVALIN

DESIGNED BY: E. LUI
DRAWN BY: G. OMORI
SCALE: 1:50
DATE: 2014/06/27
CONSULTANT NO.: 474248

CHECKED BY: B. WILLIAMSON
APPROVED BY: E. LUI
ISSUED FOR CONSTRUCTION BY:
DATE:

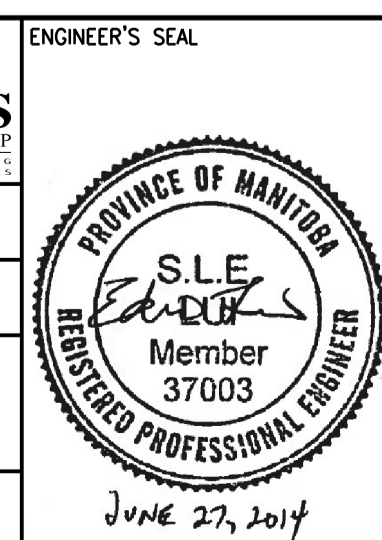

THE CITY OF WINNIPEG
Winnipeg WATER AND WASTE DEPARTMENT

SOUTH END WATER POLLUTION CONTROL CENTRE
SEWPCC UPGRADING/EXPANSION PROJECT
STRUCTURAL
VORTEX GRIT BUILDING
PILING PLAN

CITY DRAWING NUMBER: 1-0102-SFDW-G002
SHEET: 001
REV.: 00
SIZE: A1