

LEGEND:

POLE MOUNTED LUMINAIRE

UNDERGROUND CABLE ROUTE (NOTE 10)

VERTICAL CONDUIT (EXISTING)

HORIZONTAL CONDUIT (EXISTING)

THE CURRENT EDITION OF THE CANADIAN ELECTRICAL CODE, PROVINCIAL, MUNICIPAL AND OTHER CODES, RULES AND REGULATIONS.

1. ELECTRICAL INSTALLATION SHALL BE IN ACCORDANCE WITH

2. PREPARE AND SUBMIT TO THE PROPER AUTHORITIES ALL NECESSARY PERMITS AND PAY ALL FEES.

NOTES:

3. UPON COMPLETION AND BEFORE FINAL PAYMENT IS MADE, PRESENT TO THE CONTRACT ADMINISTRATOR A CERTIFICATE OF APPROVAL FOR ALL ELECTRICAL WORK FOR THE INSPECTION DEPARTMENT HAVING JURISDICTION.

4. THE CONTRACTOR SHALL GUARANTEE THE SATISFACTORY OPERATION OF ALL WORK AND APPARATUS INCLUDED AND INSTALLED UNDER THIS SECTION OF THE SPECIFICATION FOR THE PERIOD OF 12 MONTHS AFTER THE CERTIFICATE OF TOTAL PERFORMANCE IS ISSUED.

5. MOUNT POLES ON CONCRETE BASES CENTRED PLUMB AND TRUE, UTILIZING METAL SHIMS AS REQUIRED. ENSURE COMPLETE ELECTRICAL CONNECTION AND SECURELY ANCHOR POLES TO CONCRETE PILES.

6. EXACT LOCATION OF THE LIGHT POLES SHALL BE INSPECTED AND APPROVED BY THE CONTRACT ADMINISTRATOR PRIOR TO EXCAVATION FOR NEW CONCRETE PILES. AIMING ANGLE OF FIXTURES TO BE DETERMINED WITH ENGINEER DURING FINAL COMMISSIONING.

7. PROVIDE SLACK LOOP OF CABLES AT ALL FIXTURE LOCATIONS TO ALLOW FOR GROUND MOVEMENT.


8. EXISTING 4" CONDUIT. REMOVE EXISTING CABLE BEFORE USE. SEAL BOTH END PENETRATIONS AFTER PULLING LIGHTING POWER CABLES.


9. PROVIDE 8x 1C#8 AWG TO NEW LIGHTING CONTROL PANEL. CONTRACTOR TO VERIFY APPROPRIATE ROUTING ON SITE.


10. ALL CABLE AND CABLE TRENCH SHALL REMAIN OUTSIDE PERIMETER OF RINK. NO CABLE OR CABLE TRENCH TO CROSS UNDER ICE SURFACE.

11. SUPPLY AND INSTALL NEW LIGHTING CONTROL PANEL INCLUDING TWO (2) 50A, 3P LIGHTING CONTACTORS (NEMA RATED), TWO (2) SELECTOR SWITCHES (HEAVY DUTY OIL TIGHT) AND TWO (2) PILOT LIGHTS (HEAVY DUTY OIL TIGHT) PROVÍDE FUSED CONTROL CIRCUIT DERIVED FROM INCOMING POWER CABLE. ENCLOSURE SHALL BE NEMA 12 AND c/w PROVISION FOR LOCKING.

12. PROVIDE AND INSTALL 2 NEW BREAKERS IN PANEL 'M'. MATCH EXISTING.

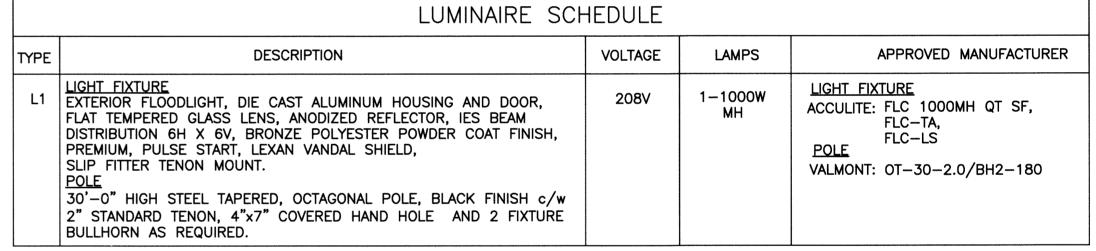

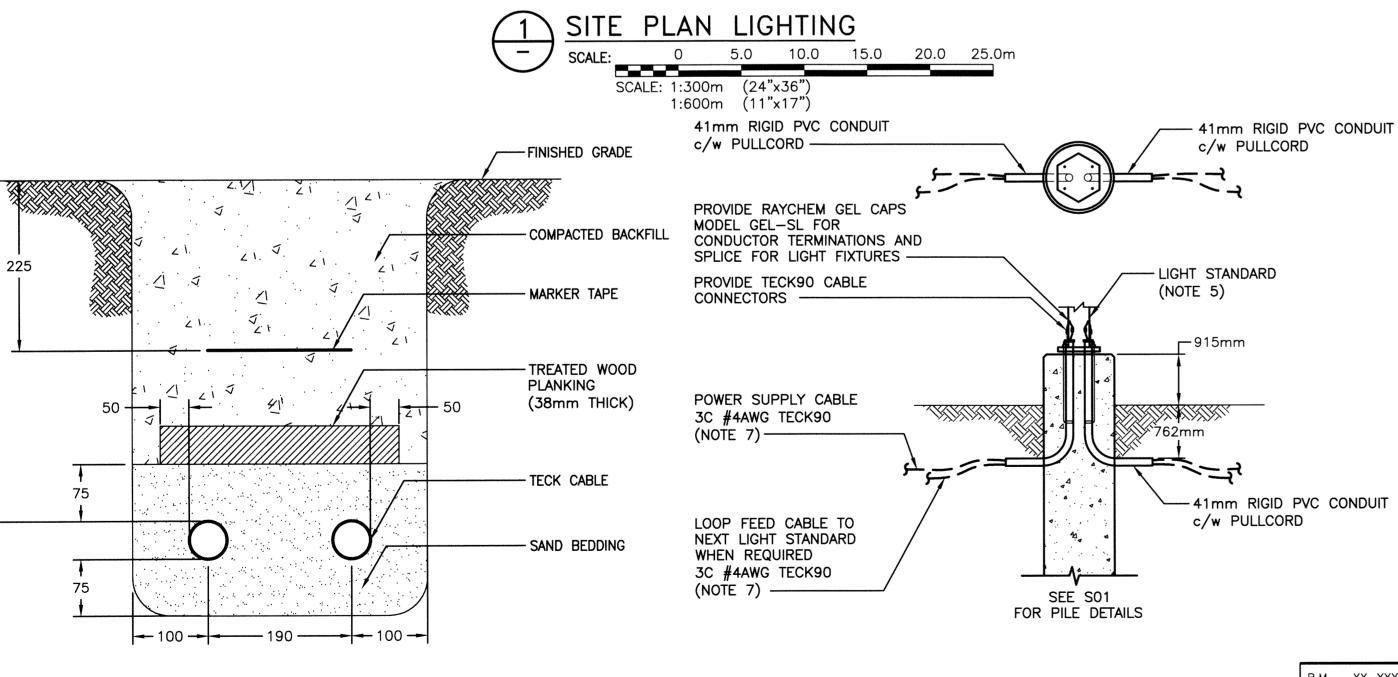

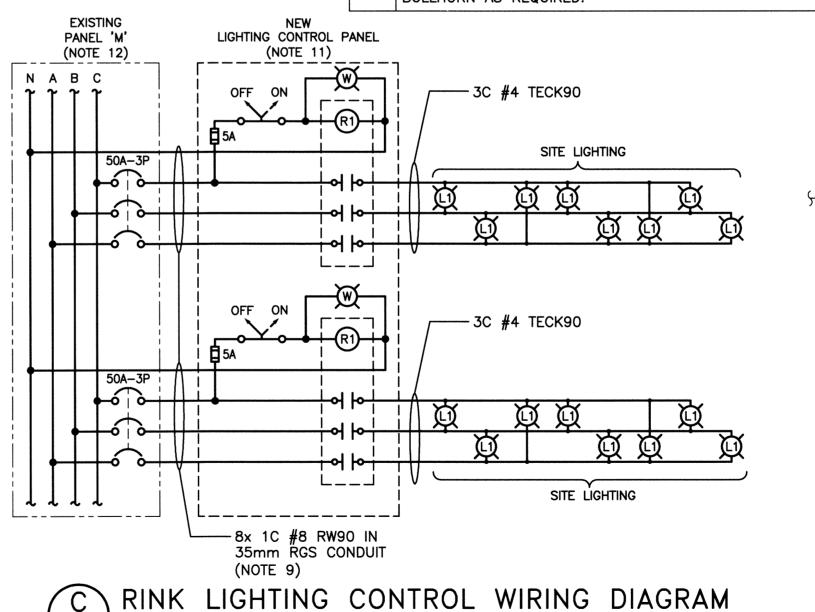

- EXISTING CONDUIT (NOTE 8) - EXISTING LIGHTING - NEW RINK LIGHTING /-CONTROL PANEL CONTROL PANEL (NOTE 11) -----EXISTING PANEL 'M'

ELECTRICAL ROOM SCALE: NTS

ZAPEGN Certificate of Authorization KGS Group

No. 245



CABLE TRENCH DETAIL


SCALE: NTS

LIGHT POLE DETAIL

SCALE: NTS

B.M. XX-XXX DESCRIPTION **KGS** ELEV. 2XX.XXX GROUP CONSULTING ENGINEERS DESIGNED CHECKED APPROVED DRAWN JPL RELEASED FOR HOR. SCALE: AS NOTED CONSTRUCTION: CONSULTANT DRAWING NO. VERTICAL: 13/03/27 RIGG 0 ISSUED FOR TENDER 12-0107-016_E01 12/11/15 NO. REVISIONS DATE BY DATE

SCALE: NTS

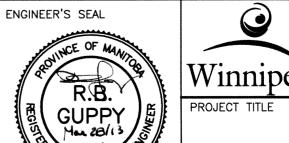

Winnipeg

THE CITY OF WINNIPEG PLANNING, PROPERTY AND DEVELOPMENT

STURGEON HEIGHTS COMMUNITY CENTRE SITE DEVELOPMENT PROJECT BID OPPORTUNITY 169-2013 ELECTRICAL - SITE PLAN AND DETAILS

09 COMPUTER FILE NAME 12-0107-016 CITY DRAWING NUMBER E01