




DETAIL - TRANSIT SHELTER FOUNDATION PLAN 8 19 SCALE NTS

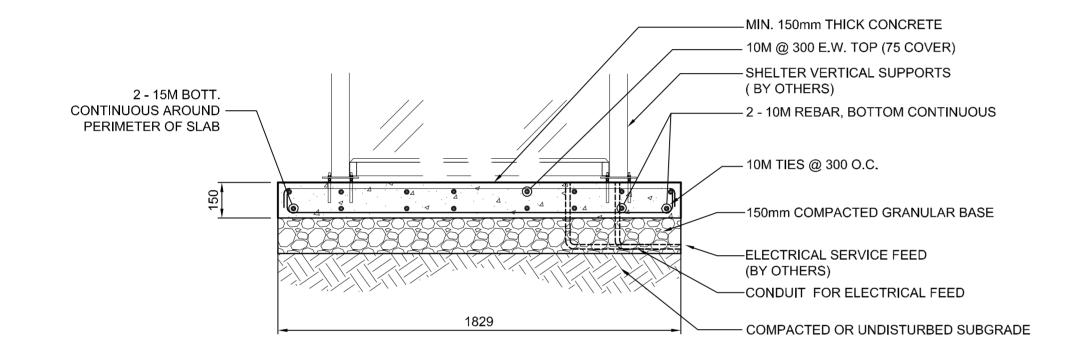


SECTION - TRANSIT SHELTER FOUNDATION SECTION SCALE NTS

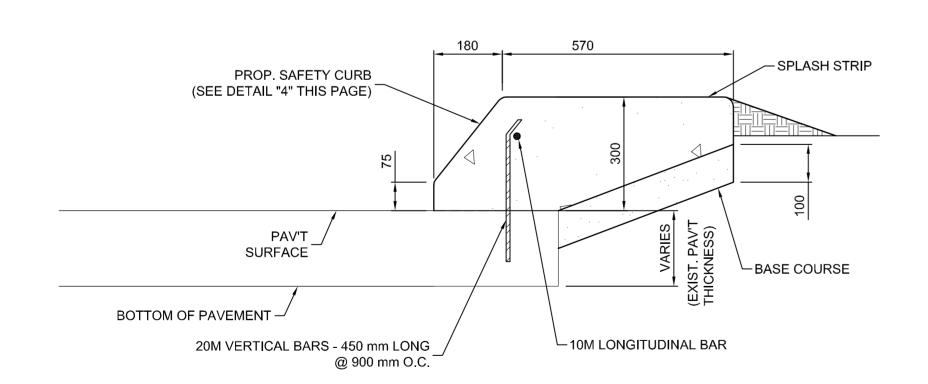


DETAIL - SAFETY CURB C/W SPLASH STRIP SCALE 1:10

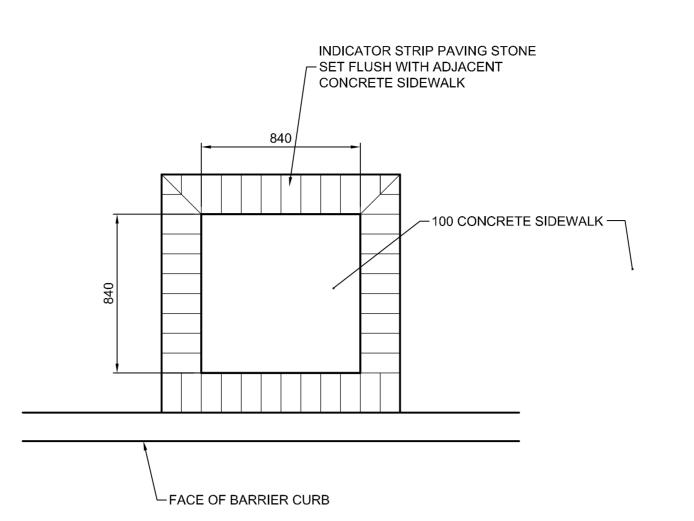

DETAIL - BUS STOP INDICATOR PAVING SQUARE SCALE NTS

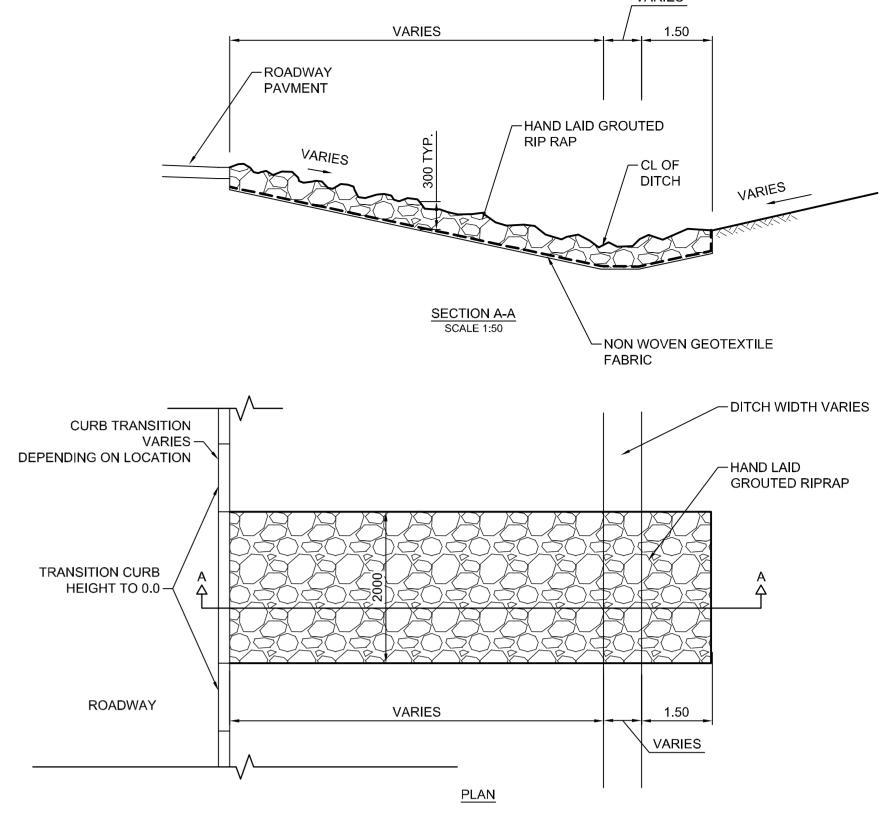

GROUTED STONE RIPRAP

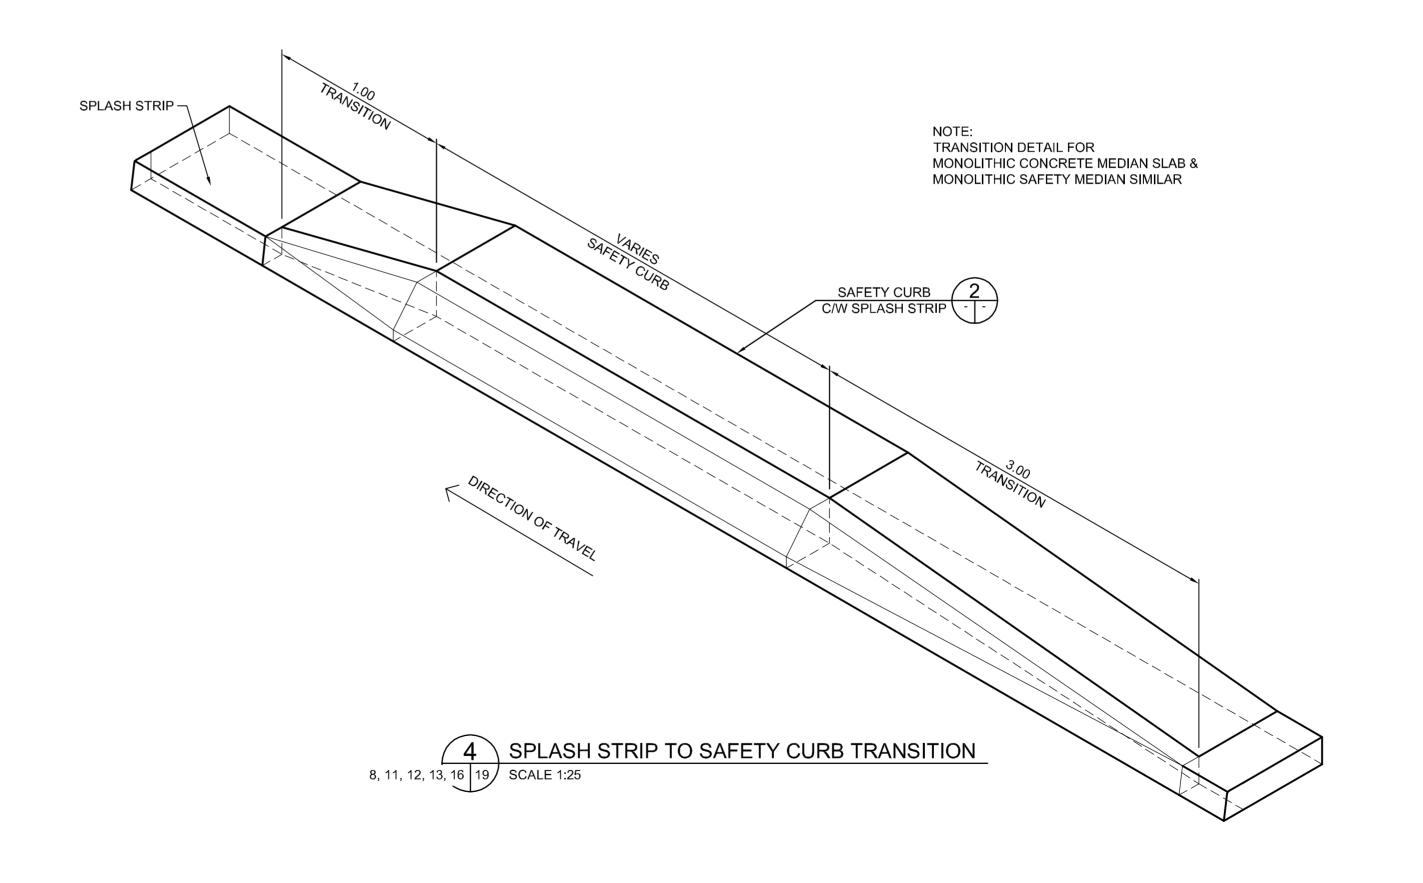

METRIC

WHOLE NUMBERS INDICATE MILLIMETRES DECIMALIZED NUMBERS INDICATE METRES

WARNING

IF POWER EQUIPMENT OR EXPLOSIVES ARE TO BE USED FOR EXCAVATION ON THIS PROJECT THE CONTRACTOR MUST:

- 1. NOTIFY THE GAS COMPANY OF THE PROPOSED LOCATION OF EXCAVATION.
- TAKE PRECAUTION TO AVOID DAMAGE TO GAS COMPANY INSTALLATIONS SEE PROVINCIAL REGULATION 210/72 FOR DETAILS.
- 3. OBTAIN EXCAVATION PERMITS PRIOR TO

CONSTRUCTION.

CITY DRAWING NUMBER

P-3327-19

| ≥ | | | | | | | | | | |
|-----------|-----------------|---------------------|-------------|--------------|----------------------|----------|--------------------|---------------------|---------------|--------------------------|
| дwо | 150 . <u>WM</u> | WATERMAIN | 150 . WM | HYDRO | HYDRO | HYDRO | 150 mm W.M. | WATERMAIN | 150 mm W.M. | |
| Roa | ф | HYDRANT | • | MTS | M.T.S. | MTS | | HYDRANT | + |] UN |
| nt/ | \otimes | VALVE | \otimes | | CONCRETE | | | VALVE | X | |
| urre | 300 LDS | LAND DRAINAGE SEWER | 300 LDS | | ASPHALT | | 300 mm L.D.S. | LAND DRAINAGE SEWER | 300 mm L.D.S. | |
| t/c | 250 WWS | WASTE WATER SEWER | 250 WWS | | PLANING | | 250 mm W.W.S. | WASTE WATER SEWER | 250 mm W.W.S. | SUF COM |
| rac | 0 | MANHOLE | • | | SIDEWALK | | —· × ·— | ℚ PROFILE | | |
| Cont | | CATCH BASIN | | | PAVING STONES | | | NORTH/WEST GUTTER | | NC |
| 587\(| ∇ | CURB INLET | ▼ | | PARTIAL DEPTH REPAIR | 7///// | | SOUTH/EAST GUTTER | | LOC |
| 458 | | JUNCTIONS | | | PROPERTY LINE | | | NORTH/WEST T/LANE | | AVA |
| /11 | [] | CULVERT | | + | SURVEY BAR | | | SOUTH/EAST T/LANE | | THA THA |
| CAD | 100 .GAS | GAS | 100 GAS | | CURB RAMP | | | | | CON LOC OBT BEF |
|)/ (3: | EXISTING | LEGEND-PLAN | PROPOSED | EXISTING | LEGEND-PLAN | PROPOSED | EXISTING | LEGEND-PROFILE | PROPOSED | BEF |

| UNDERGROUND STRUCTURES | | B.M. 654271 N 5517192.470 E 632610.651 ELEV. 233.084 | | | | RTP | '1, | | |
|--|-------------|---|----------|-----|----------------|------------|-------------------------------|--|--|
| | | | | | DRAWN BY | PMW | | | |
| SUPV. U/G STRUCTURES DATE | | | | | - | | | | |
| COMMITTEE | | | | | CHECKED | INIO | | | |
| | | | | | BY | JNC | DILLON | | |
| NOTE: | | | | | APPROVED BY | DPK | CONSULTING | | |
| LOCATION OF UNDERGROUND STRUCTURES AS | | | | | | | | | |
| SHOWN ARE BASED ON THE BEST INFORMATION | | | | | ļ | | | | |
| AVAILABLE. BUT NO GUARANTEE IS GIVEN THAT ALL EXISTING UTILITIES ARE SHOWN OR THAT THE GIVEN LOCATIONS ARE EXACT. CONFIRMATION OF EXISTENCE AND EXACT | | | | | HOR. SCALE | AS NOTED | RELEASED FOR CONSTRUCTION | | |
| LOCATION OF ALL SERVICES MUST BE OBTAINED FROM THE INDIVIDUAL UTILITIES | UTILITIES 1 | ISSUED FOR TENDER | 11/06/23 | JNC | VERTICAL | | ORIGINAL SIGNED BY B. KIBBINS | | |
| BEFORE PROCEEDING WITH CONSTRUCTION. | NO. | REVISIONS | DATE | BY | DATE | 2011/06/23 | DATE 11/06/23 | | |

ENGINEER'S SEAL CRANG 2011/06/23

CONSULTANT PROJECT NUMBER

11-4587

Winnipeg

THE CITY OF WINNIPEG PUBLIC WORKS DEPARTMENT

| BISON DRIVE & PEMBINA HIGHWAY |
|-------------------------------|
| INTERSECTION IMPROVEMENTS |
| |

SHEET OF 19 24 CONSULTANT DRAWING NUMBER DETAILS 1, 2, 3, 4 AND 5