
INTERLOCK SCHEDULE				
INITIATING DEVICE	ACTION			
ALL	FAS-B101-R01	RELEASE MAGNETICALLY HELD OPEN FIRE DOOR		

914.4	1524.0	914.4	1524.0	
	1 CEIL - SCALE 1		M SECTION	

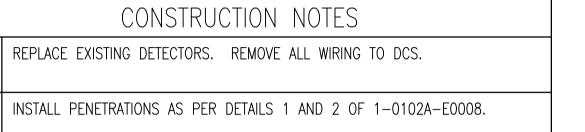


	ROOM DETAILS				
ROOM ID	HEIGHT	CEILING TYPE	REF DWG		
B101	(<18m)	SEE DETAIL 1	_		
B106	2.54m	CONCRETE (457mm DEEP BEAMS AS SHOWN)	SEP-870		
B107	2.54m	CONCRETE	SEP-870		
B108	2.60m	CONCRETE	_		
B109	2.60m	CONCRETE	_		
B110	(<18m)	SEE DETAIL 1			
B111	5.96m	SEE DETAIL 1	SEP-891		
B119	5.96m	CONCRETE	SEP-891		
B120	2.42m	SUSPENDED ACOUSTIC TILE	SEP-891		
B121	2.42m	SUSPENDED ACOUSTIC TILE	SEP-891		
B201	4.20m	CONCRETE	SEP-926		

$D = C \cup C$		NOTEC
DESIGN		$M() \vdash \subseteq$
		NOILO


FAS-B111-D01 IS INTENDED TO ACTIVATE DOOR RELEASE FAS-B101-R01 IN THE EVENT OF A FIRE.

A FIRE ALARM SYSTEM WILL NOT BE INSTALLED IN THE CHEMICAL STORAGE BUILDING, AS IT WILL BE DEMOLISHED AS PART OF FUTURE PLANT UPGRADES.

AS THE DEPTH OF THE WALL SECTION ABOVE THE DOOR IS LESS < 600mm ON THE STAIRWELL SIDE OF THE DOOR, DETECTION FOR THE DOOR RELEASE IS NOT REQUIRED ON BOTH THE STAIRWELL AND WORKSHOP SIDE OF THE

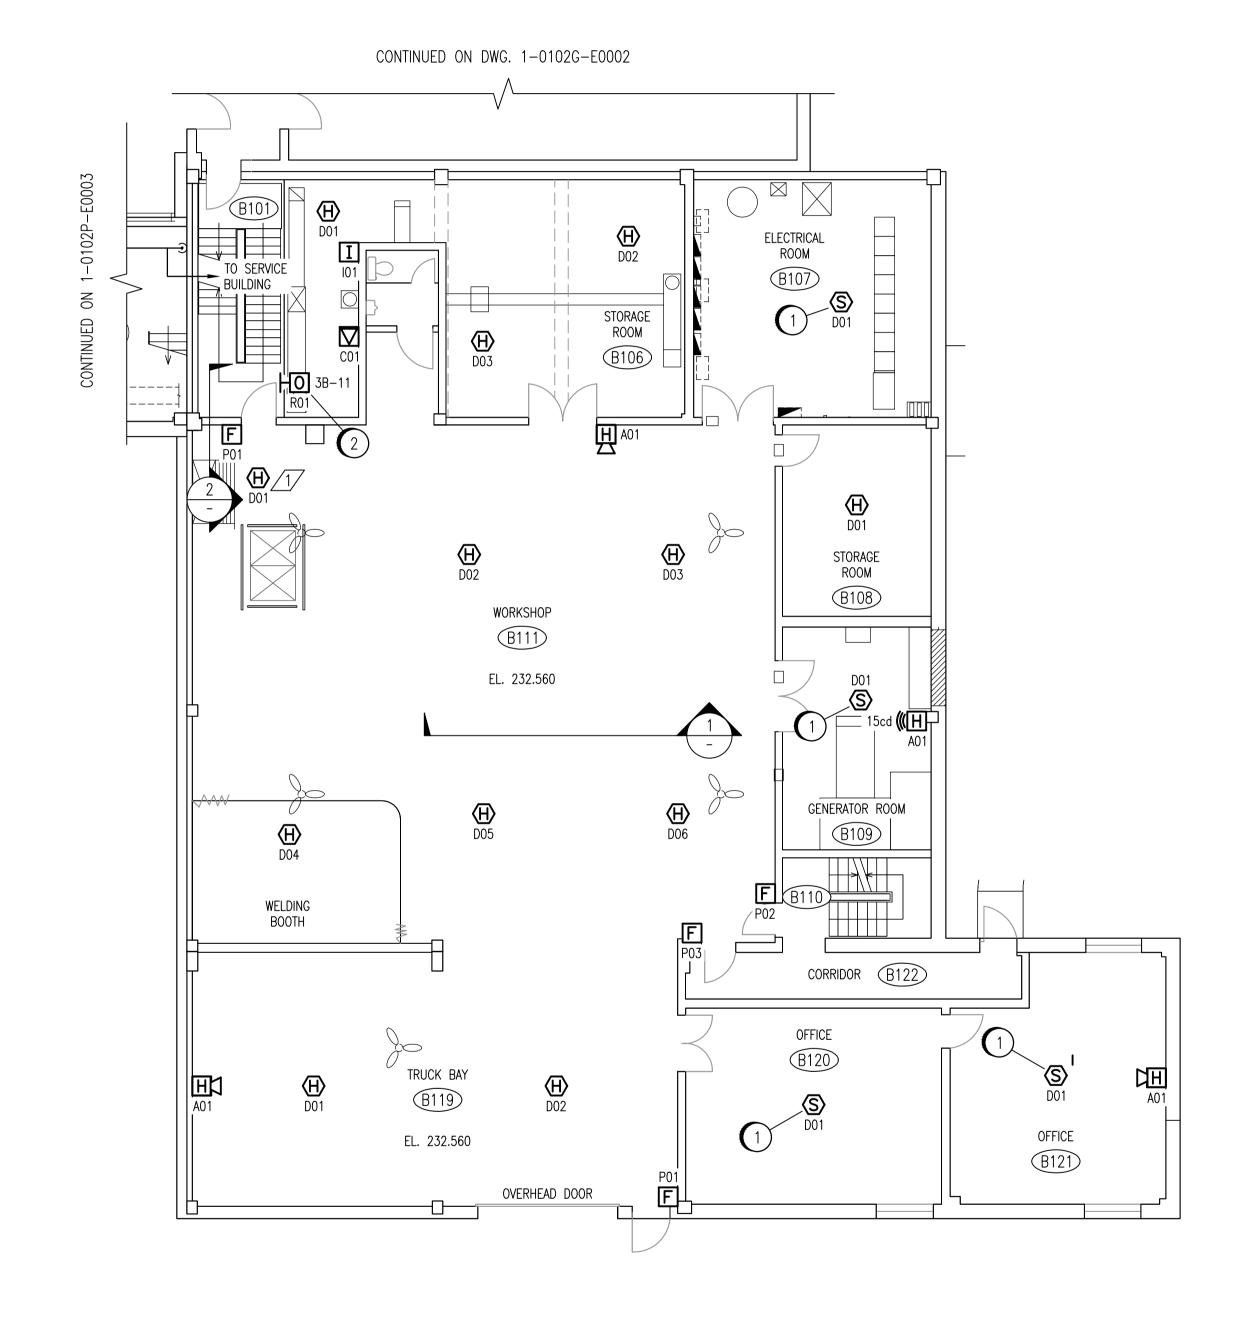


BOILER BUILDING - MAIN LEVEL SCALE 1:100

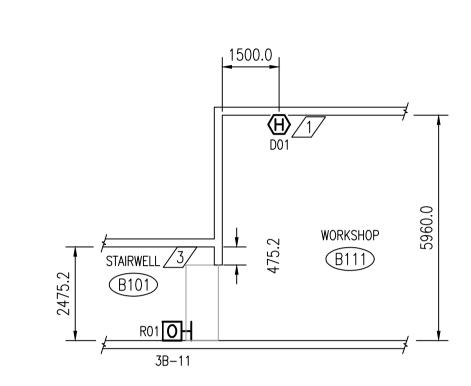

DOOR RELEASE SMOKE DETECTOR PLACEMENT

SCALE 1:100

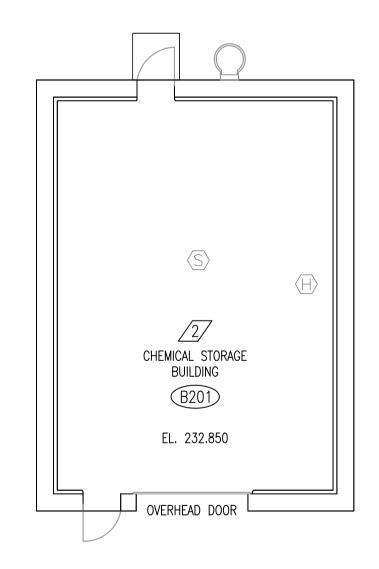

CHEMICAL STORAGE BUILDING SCALE 1:100

ENGINEER'S SEAL

ORIGINAL DRAWING SEALED BY:

C. J. REIMER

SNC-LAVALIN


MEMBER #21968

2011/03/25 REV. 00

SEP-2135	SMOKE DETECTORS LOOPS B533/B542
SEP-2132	SMOKE DETECTORS LOOPS B504/B507/B508
SEP-906	LIGHTING & BUILDING SERVICES — FLOOR PLAN
1-0102B-E0006	PLAN LAYOUT — ELECTRICAL ROOM
1-0102B-E0008	PANEL SCHEDULE - SERVICE BUILDING
1-0102B-E0009	ELECTRICAL CLASSIFICATION PLAN
1-0102A-E0001	FIRE ALARM LEGEND AND DETAILS

REFERENCE DRAWINGS

DRAWING NUMBER

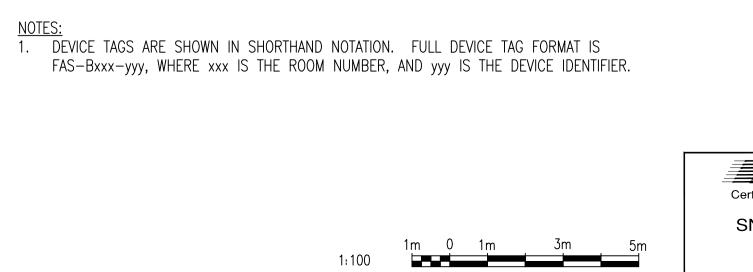

						<b>7</b> ))	SNC-LAVALIN INC.  148 Nature Park Way Winnipeg, MB, Canada R3P 0)  204-786-8080
						DESIGNED BY: E. BOHNCKE	CHECKED BY: C. REIMER
<b>A</b> PEGN						DRAWN BY: E. BOHNCKE	APPROVED BY: C. REIMER
ertificate of Authorization						SCALE: AS SHOWN	RELEASED FOR CONSTRUCTION BY: N. HARRINGTON
SNC-Lavalin Inc.			/			DATE: 2009/03/20	DATE: 2011/03/11
No. 4489	00	ISSUED FOR TENDER, BID OPP. 209–2011	2011/03/11	EFB	CHECK	CONSULTANT NO.: 112577-	-0101-47DD-0031

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THE CITY OF WINNIPEG WATER AND WASTE DEPARTMENT

SOUTH END WATER POLLUTION CONTROL CENTRE FIRE ALARM UPGRADE PLAN LAYOUT FIRE ALARM — SERVICE BUILDING MAIN LEVEL

SHEET REV. SIZE 1-0102B-E0001 001 00 A1

1-0102B-E0001-001-00.dwg