


GENERAL CONSTRUCTION NOTES:

1. ALL PRODUCTS INCORPORATED IN THE WORK SHALL CONFORM TO THE CITY WINNIPEG "STANDARD CONSTRUCTION SPECIFICATIONS" AND BE REGISTERED IN THE CITY OF WINNIPEG LISTING OF APPROVED PRODUCTS OR AS SPECIFIED ON THIS DRAWING. ALL CONSTRUCTION SHALL CONFORM TO THE CITY OF WINNIPEG "STANDARD CONSTRUCTION SPECIFICATIONS", LATEST EDITION.
2. IT IS THE RESPONSIBILITY OF THE CONTRACTOR TO VERIFY THE LOCATIONS OF ALL UTILITIES, PIPES, SURVEY MARKERS, OR STRUCTURES, AND TO NOTIFY ALL RELEVANT UTILITIES PRIOR TO COMMENCEMENT OF CONSTRUCTION. THE CONTRACTOR SHALL NOTIFY THE CONTRACT ADMINISTRATOR OF ANY ERROR OR OMISSION PRIOR TO CONSTRUCTION.
3. IN ACCORDANCE TO THE CITY OF WINNIPEG SURVEY INFRASTRUCTURE PROTECTION PROGRAM, THE CONTRACTOR SHALL NOTIFY THE GEOMATICS BRANCH A MINIMUM 3 DAYS PRIOR TO START OF CONSTRUCTION.
4. DESCRIPTION OF PROPERTY LIMITS, AND EXISTING AND/OR PROPOSED FEATURES RELATIVE TO THESE LIMITS AS SHOWN ON THIS DRAWING DO NOT REPRESENT A LEGAL SURVEY. GENIVAR MAKES NO REPRESENTATION OR GUARANTEE THAT THE PROPERTY LIMIT INFORMATION IS ACCURATE. GENIVAR ACCEPTS NO RESPONSIBILITY FOR DAMAGES, IF ANY, SUFFERED BY ANY THIRD PARTY AS A RESULT OF DECISIONS OR ACTIONS BASED ON THIS DRAWING.
5. ALL AREAS AFFECTED BY CONSTRUCTION TO BE RESTORED TO THE ORIGINAL CONDITION OR BETTER UNLESS NOTED OTHERWISE ON THE DRAWING. ALL REGRADED/DISTURBED SOD AREAS TO RECEIVE TOPSOIL AND SOD UNLESS NOTED OTHERWISE.

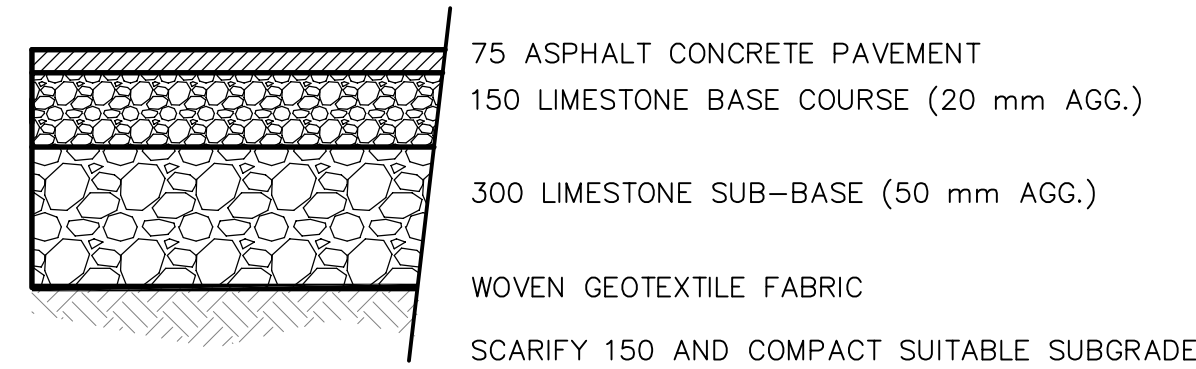

150 WM	WATERMAIN	150 WM	---	---	GAS	---	---	---
○	HYDRANT	●	---	---	HYDRO	---	---	---
⊗	VALVE	⊕	---	---	M.T.S.	---	---	---
300 LDS	LAND DRAINAGE SEWER	300 LDS	⊠	---	PEDESTAL	---	---	---
250 WWS	WASTE WATER SEWER	250 WWS	○	230.000	GROUND ELEVATION	30.00	---	---
○	MANHOLE	●	---	---	PAVEMENT ELEVATION	(30.00)	---	---
□	CATCH BASIN	■	---	---	PROPERTY LINE	---	---	---
△	CURB INLET	▲	---	---	SURVEY BAR	---	---	---
▽	SIGN	⊕	---	---	CURB STOP	---	---	---
○	LAMP STANDARD	●	---	---	TESTHOLE	---	---	---
•	UTILITY POLE	•	---	---	---	---	---	---
EXISTING	LEGEND - PLAN	PROPOSED	EXISTING	LEGEND - PLAN	PROPOSED	EXISTING	LEGEND - PROFILE	PROPOSED

LOCATION APPROVED
UNDERGROUND STRUCTURES

SUPV. U/G STRUCTURES COMMITTEE DATE

NOTE:
LOCATION OF UNDERGROUND STRUCTURES AS SHOWN ARE BASED ON THE BEST INFORMATION AVAILABLE BUT NO GUARANTEE IS GIVEN THAT ALL EXISTING UTILITIES ARE SHOWN OR THAT THE GIVEN LOCATIONS ARE EXACT. CONFIRMATION OF EXISTENCE AND EXACT LOCATION OF ALL SERVICES MUST BE OBTAINED FROM THE INDIVIDUAL UTILITIES BEFORE PROCEEDING WITH CONSTRUCTION.

C.W.B.M. 78-022 232.982m

84R671 - W. SIDE DAKOTA ST. ON CURVE N. OF PADDINGTON RD., TBLT. ON TOP OF 0.05m DIA. X 2.4m IRON PIPE, 1.5m W. OF W. CURB OF DAKOTA ST. & 24m N. OF 5th LAMP STANDARD FROM PADDINGTON RD.

0	ISSUED FOR REVIEW	11/01/25	R.C.
NO.	REVISIONS	DATE	BY

GENIVAR
10 PRAIRIE WAY WINNIPEG, MANITOBA R2J 3J8
PH: (204)-477-6650 FAX: (204)-474-2864

DESIGNED BY R.C.	CHECKED BY D.T.B.
DRAWN BY R.C.	APPROVED BY B.D.E.
HOR. SCALE: 1:100	RELEASED FOR CONSTRUCTION
VERT. SCALE:	DATE
DATE JANUARY 2011	

ENGINEER'S SEAL

PROVINCE OF MANITOBA
REGISTERED PROFESSIONAL ENGINEER
R. CABICTING
Member 24617

CONSULTANT DRAWING NO.
08173-C02-R0

THE CITY OF WINNIPEG
PLANNING, PROPERTY & DEVELOPMENT

Winnipeg

IMPROVEMENTS TO SITE DRAINAGE FOR THE DAKOTA COMMUNITY CENTRE
SITE PLAN - REAR ENTRANCE

CITY DRAWING NO. 10-2011-C02
SHEET 2 OF 2
REV. 2 0

METRIC
WHOLE NUMBERS INDICATE MILLIMETRES
DECIMALIZED NUMBERS INDICATE METRES

APEGM
Certificate of Authorization
GENIVAR Inc.
No. 5079 Date/January 25, 2011