


1 FIRE ALARM RISER DIAGRAM
E6.3 SCALE: N.T.S.

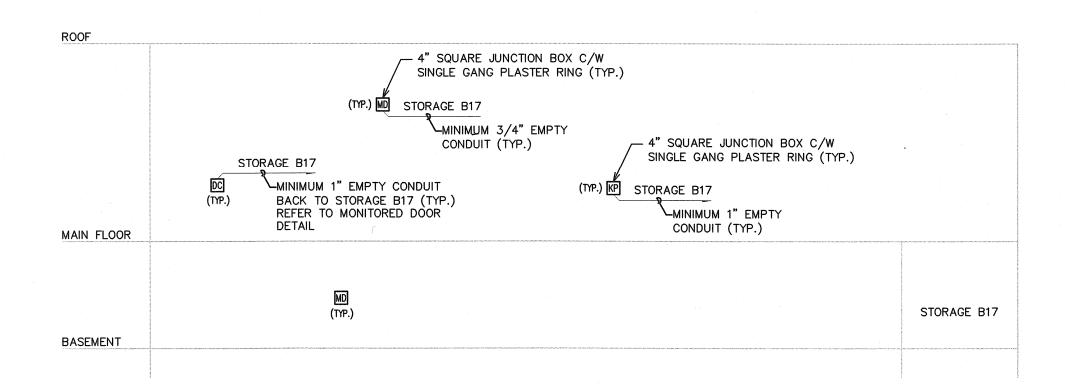

## 2 SECURITY SYSTEM ROUGH—IN RISER DIAGRAM E6.3 SCALE: N.T.S.

## <u>NOTES:</u>

- 1. PROVIDE ROUGH-IN ONLY FOR SECURITY SYSTEM.
- 2. PROVIDE PLASTER BUSHINGS AND PULLWIRE FOR ALL EMPTY CONDUIT.

## NOTES:

- 1. PROVIDE ISOLATION MODULES ENTERING AND LEAVING EACH ZONE DEFINED BY THE LATEST VERSION OF THE NATIONAL BUILDING CODE AND ULC-S524-06.
- 2. ALLOW MAXIMUM OF 80 ADDRESSABLE DETECTION/ALARM DEVICES PER ADDRESSABLE LOOP MODULE.
- 3. PROVIDE CLASS B SIGNAL CIRCUITS FOR CORRIDOR AUDIBLE SIGNALS.
- 4. PROVIDE CLASS A CIRCUITS FOR DETECTION/ALARM DEVICES.
- 5. THIS FIRE ALARM RISER SHALL BE UTILIZED AS A GUIDE FOR THE CONTRACTOR TO PRICE ONLY. THE CONTRACTOR SHALL PROVIDE AN UPDATED RISER AS CREATED BY THE FIRE ALARM SYSTEM SUPPLIER TO ENSURE CODE CONFORMANCE BASED ON THEIR SYSTEM REQUIREMENTS.

FIRE ALARM ZONE SCHEDULE

6. PROVIDE MINIMUM 1 HOUR FIRE RATED CABLING FOR ANNUNCIATOR RISER CABLING.

	ABBREVIATIONS:	HD — HEAT DI SD — SMOKE DSD — DUCT SI	PULLSTATION ETECTOR DETECTOR MOKE DETECTOR ISED VALVE	FS - FLO SC - SU	ESSURE SI DW SWITCH PERVISORY ARM CHEC	CONTACT
ZONE	DESCRIPTION		INITIATING I	DEVICES	ALARM	TROUBL
Z1	BASEMENT FLOOR		MPS/HD/SD		0	***************************************
Z2	MAIN FLOOR		MPS/HD/SD		0	
Z3	STAIR S01		SD		0	
Z4	STAIR S02		SD		0	***************************************
Z5	FUTURE ELEVATOR PIT		HD		0	
Z6	FUTURE ELEVATOR TOP OF SHAFT		HD		0	
Z7	AHU-2		DMSD		8	
Z8	FF-1		DMSE	)	0	
Z9	SF-1		DMSE	)	0	
Z10	SPARE					
Z11	SPARE					
Z12	SPARE					
Z13	SPARE					
Z14	SPARE					
Z15	SPACE					
Z16	SPACE					
Z17	SPACE					
Z18	SPACE			***************************************		
Z19	SPACE			***************************************		***************************************



Certificate of Authorization
MCW/AGE Consulting
Professional Engineers
No. 589 Expiry: April 30, 2010

D ISSUED FOR TENDER
C ISSUED FOR 99% REVIEW
B ISSUED FOR 90% REVIEW
A ISSUED FOR 60% REVIEW

FEB 26, 2010 FEB 10, 2010 JAN 08, 2010 DEC 02, 2009

This drawing must not be scaled.

The general Contractor must verify all dimensions, datums and levels prior to commencement of work. All errors and omissions must be reported immediately to the Architect.

Variations and modifications to work shown on this drawing shall not be carried out without written permission from the Architect.

This drawing is the exclusive property of the Architect and cannot be reproduced without written permission of the Architect. Reproduction must bear the name of the Architect. Copyright © 2009.



MCW / AGE

Consulting Professional Engineers
210-1821 Wellington Avenue
Winnipeg, Manitoba, R3H 0G4
Phone - (204) 779-7900 Fax - (204) 779-1119

E-Mail: mcw\_wpg@mcw.com



project

SINCLAIR COMMUNITY
CENTRE
ADDITION & RENOVATIONS
490 Sinclair Street, Winnipeg

sheet title

RISER DIAGRAMS

project number: 5878 drawing number: scale: N.T.S. drawn by: P.A.S. approved by: K.B.G. date: 2010-02-26