

TYPICAL EXPOSED CEILING ROOF CONSTR.

- MOD BIT CAP SHEET AS PER SPEC
- MOD BIT BASE SHEET AS PER SPEC
- SLOPED INSULATION AS REQ'D.
- 75mm SOPREMA COLGRIP A INSULATION - PERPENDICULAR TO BASE LAYER
- 75mm SOPREMA COLGRIP B INSULATION - INSULATION ADHERED WITH DUOTACK
- ROOF VAPOUR BARRIER AS PER SPEC
- 13mm GYPSUM BOARD
- 38mm DECK & OWSJ - SEE STRUCT.

INSTALL ALUM. AIR VENT GRILLE

CAULK ALL AROUND PENETRATION

19mm MDF

PROVIDE 38x89 WOOD FRAME BOX-IN AROUND RWL PLUMBING

PROVIDE 38x89 WOOD BLOCK FRAME FOR AIR VENT GRILLE


INSTALL ALUM. AIR VENT GRILLE

RUBBER BASE AS PER SPEC


TYPICAL STRUCTURAL SLAB - SEE STRUCT.

- STRUCTURAL SLAB - SEE STRUCT.
- 10mil POLY VAPOUR BARRIER
- 3mm UNTEMPERED MASONITE
- 150mm VOIDFORM
- 50mm SAND



1 RWL WALL PENETRATION SECTION DETAIL - TYP.
A-5.2 SCALE 1:20

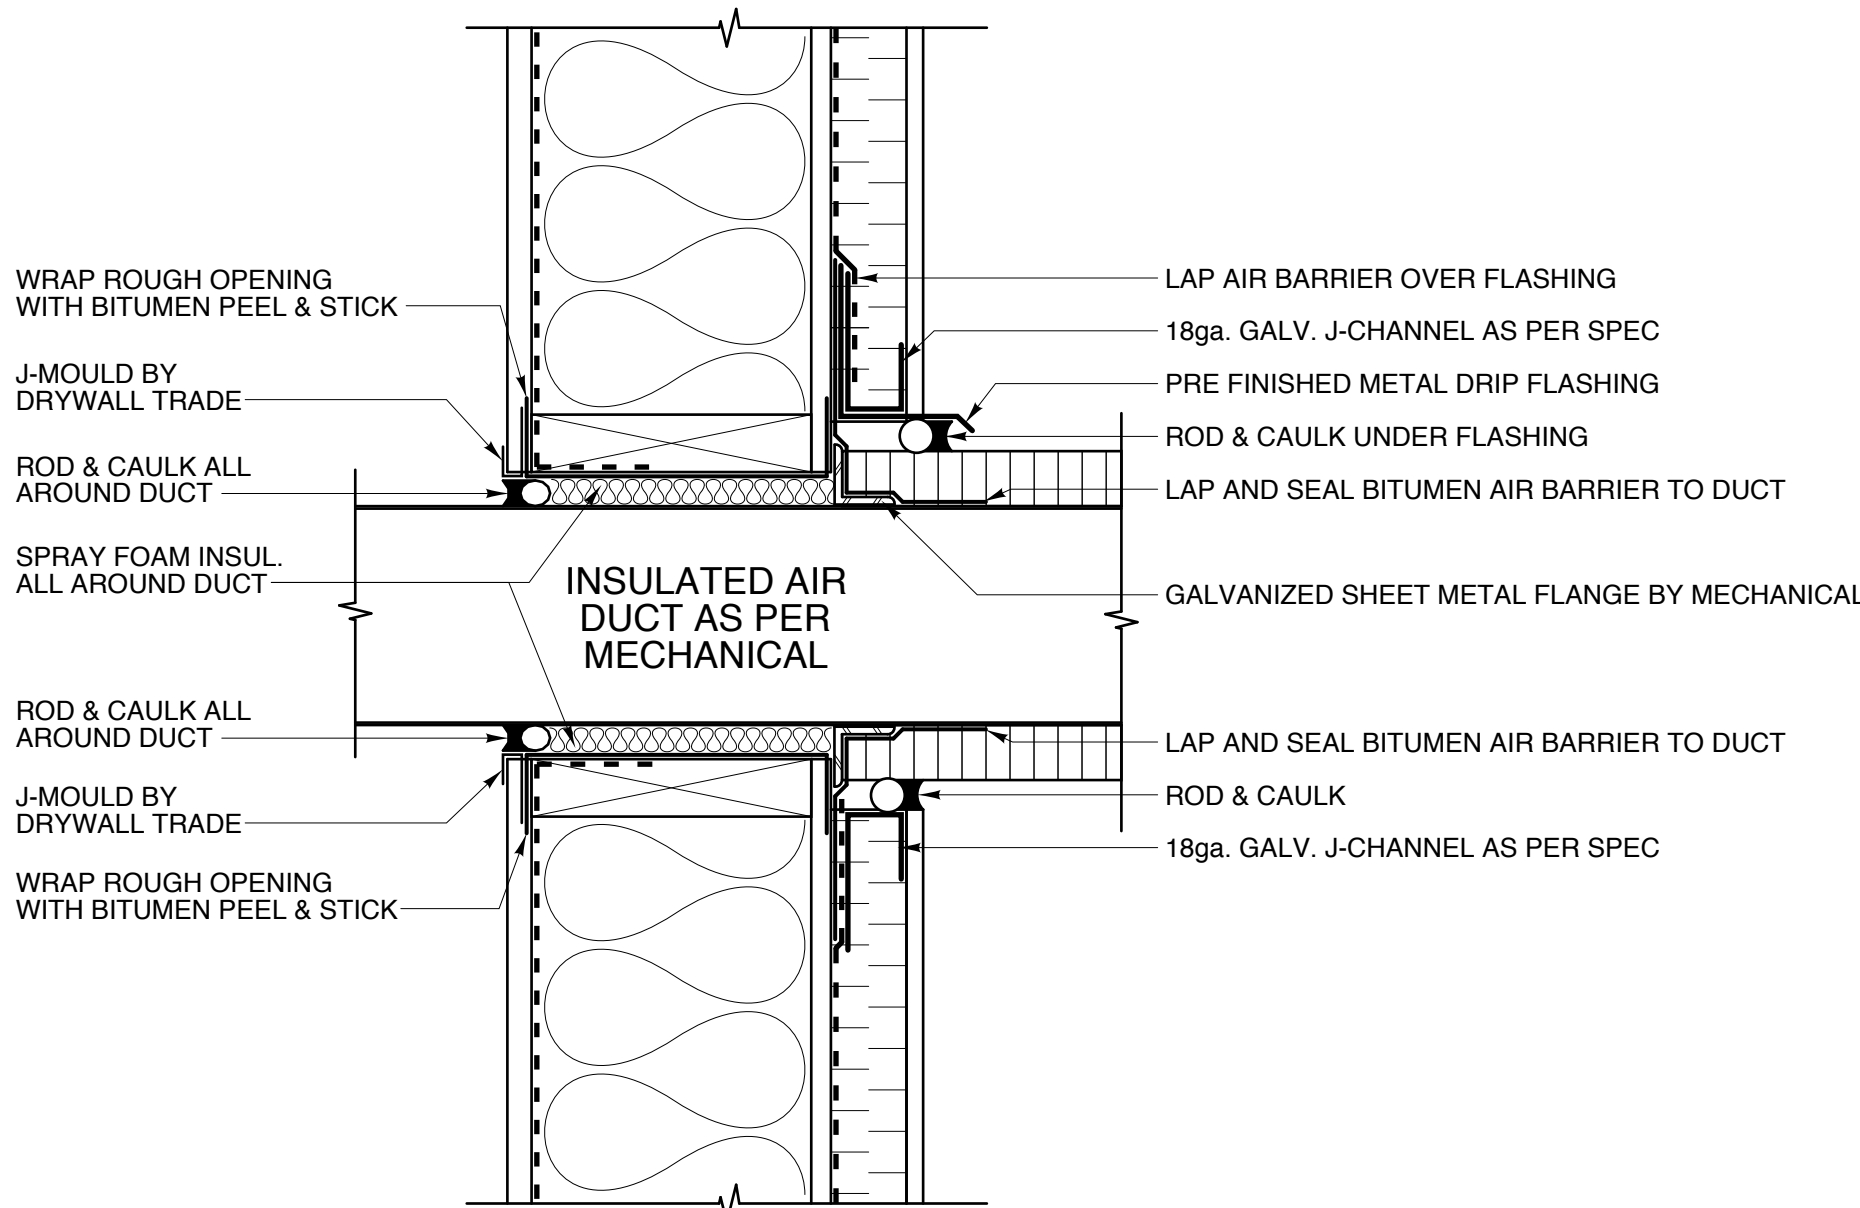


2 AIR DUCT WALL PENETRATION SECTION DETAIL
A-5.2 SCALE 1:5

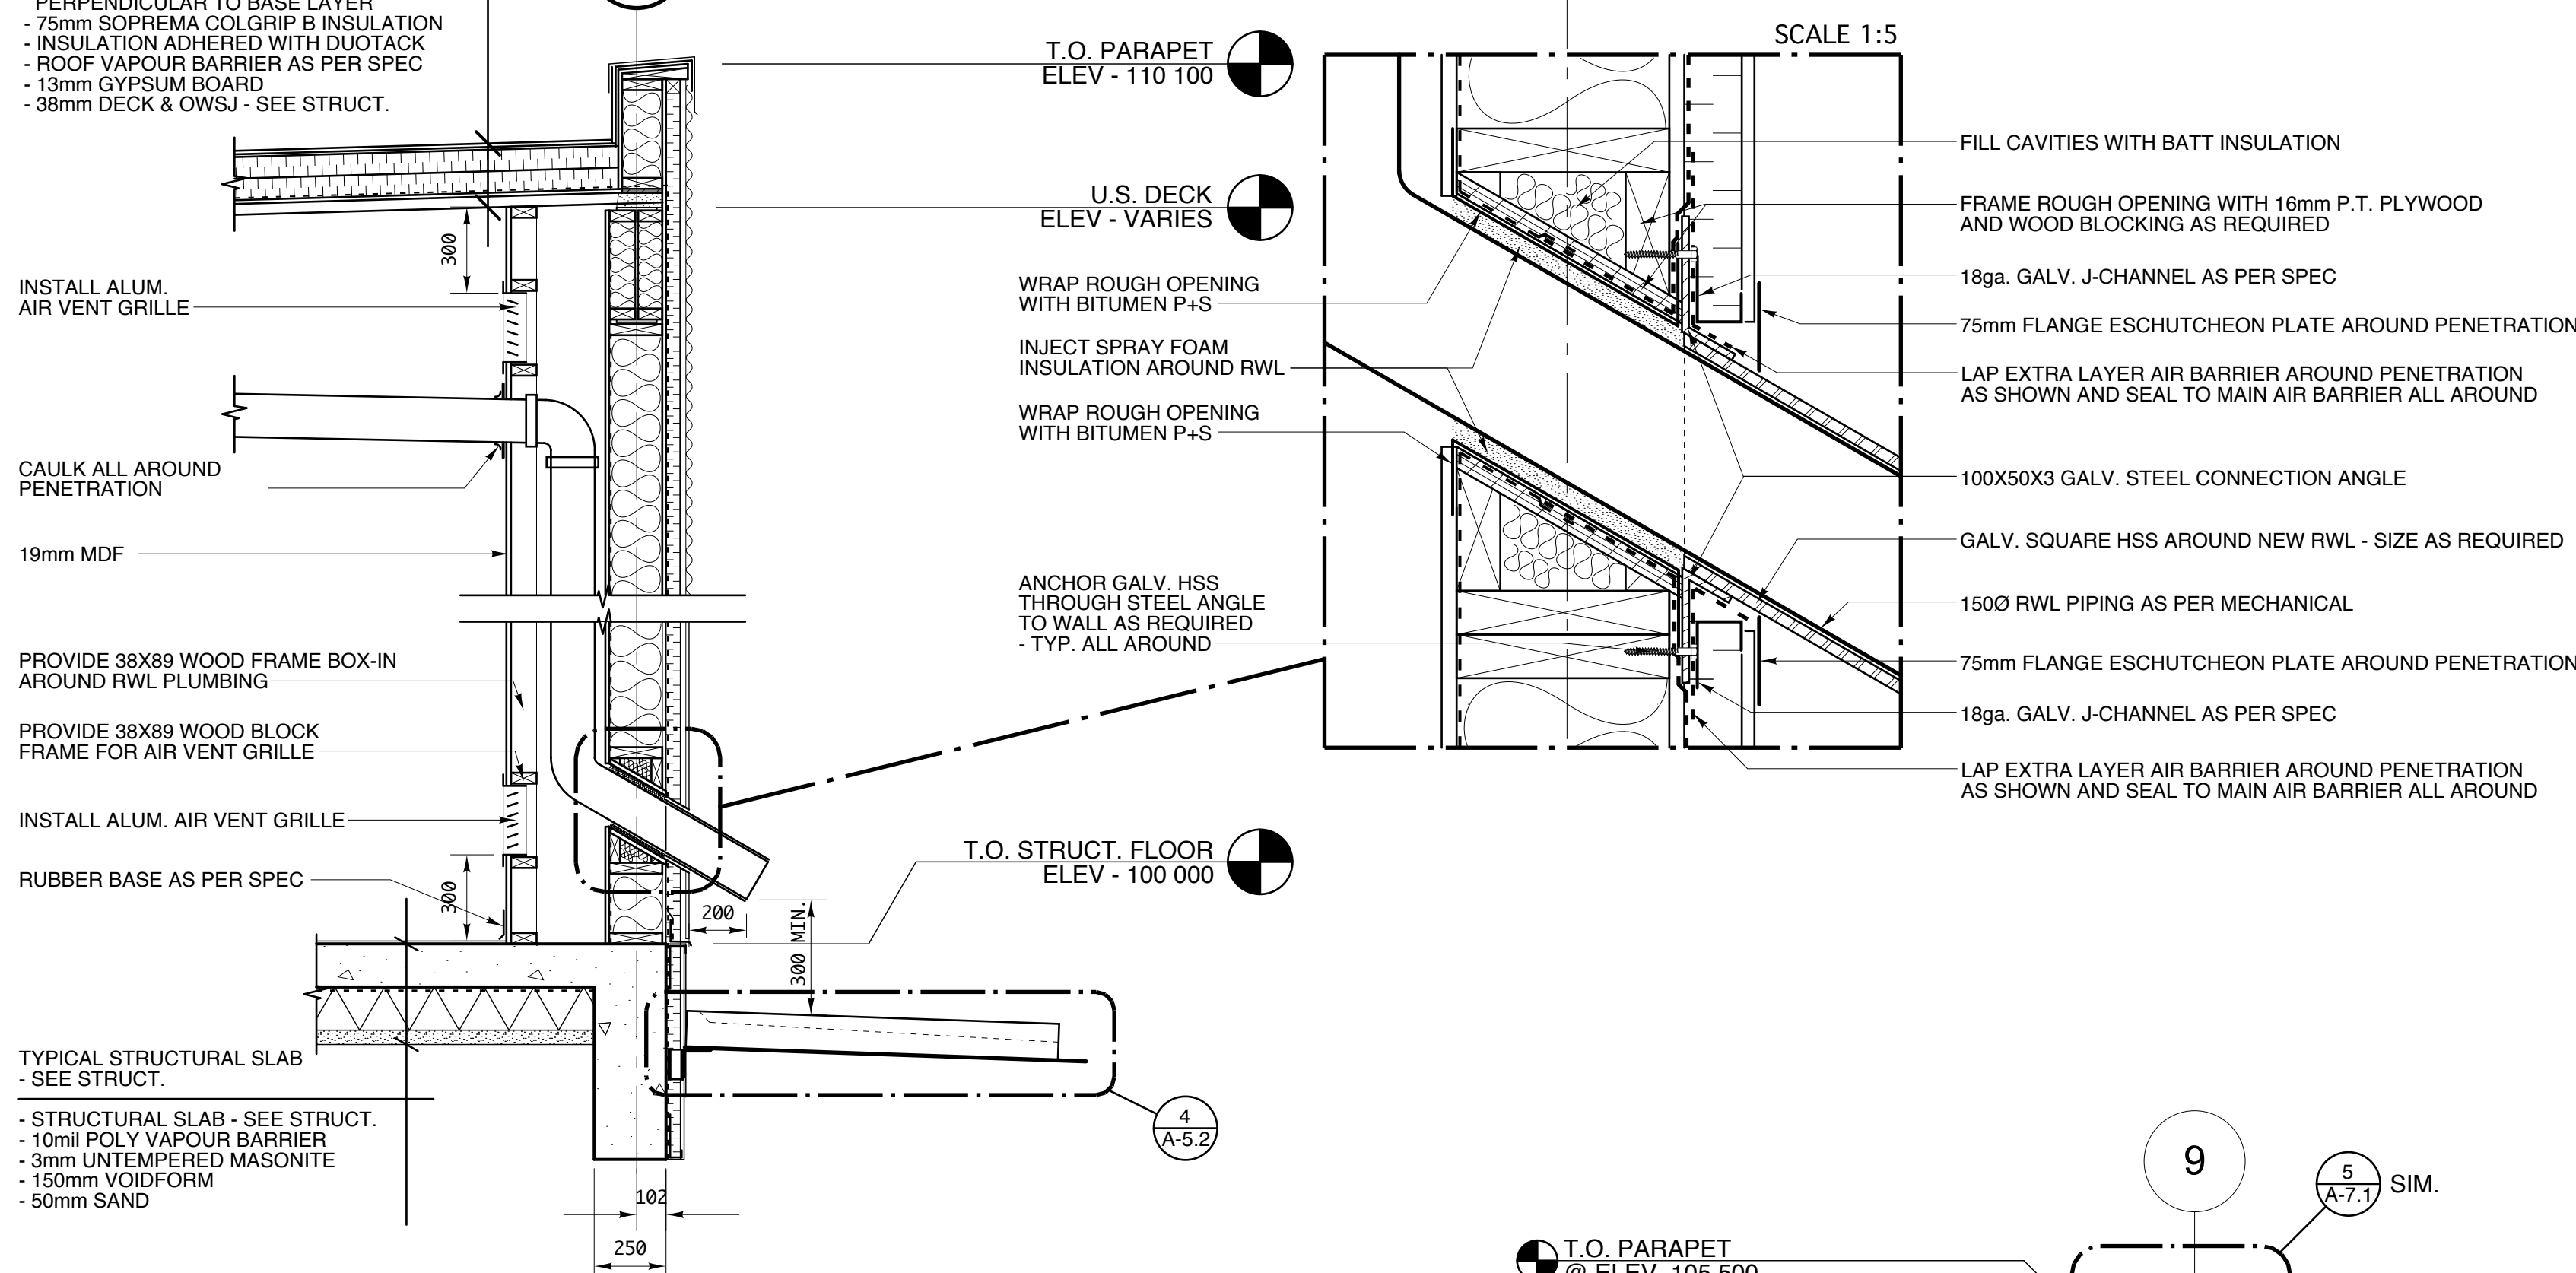


3 SCUPPER / DOWNSPOUT SECTION DETAIL
A-5.2 SCALE 1:10

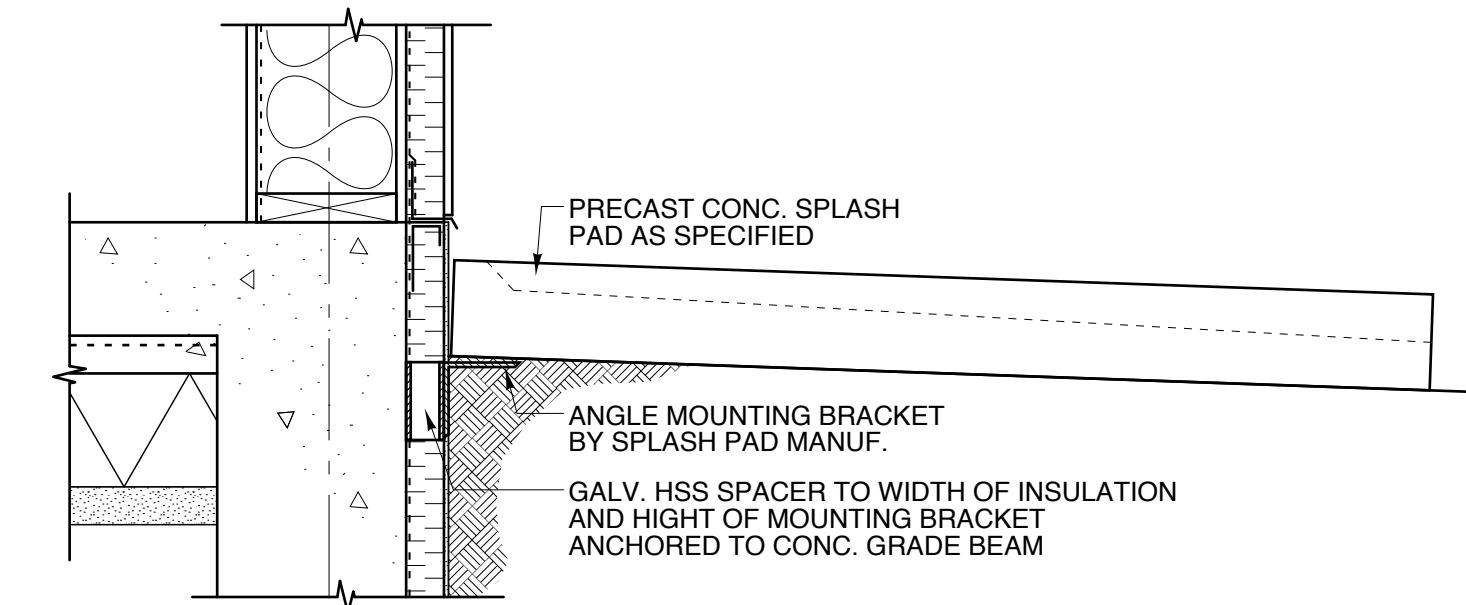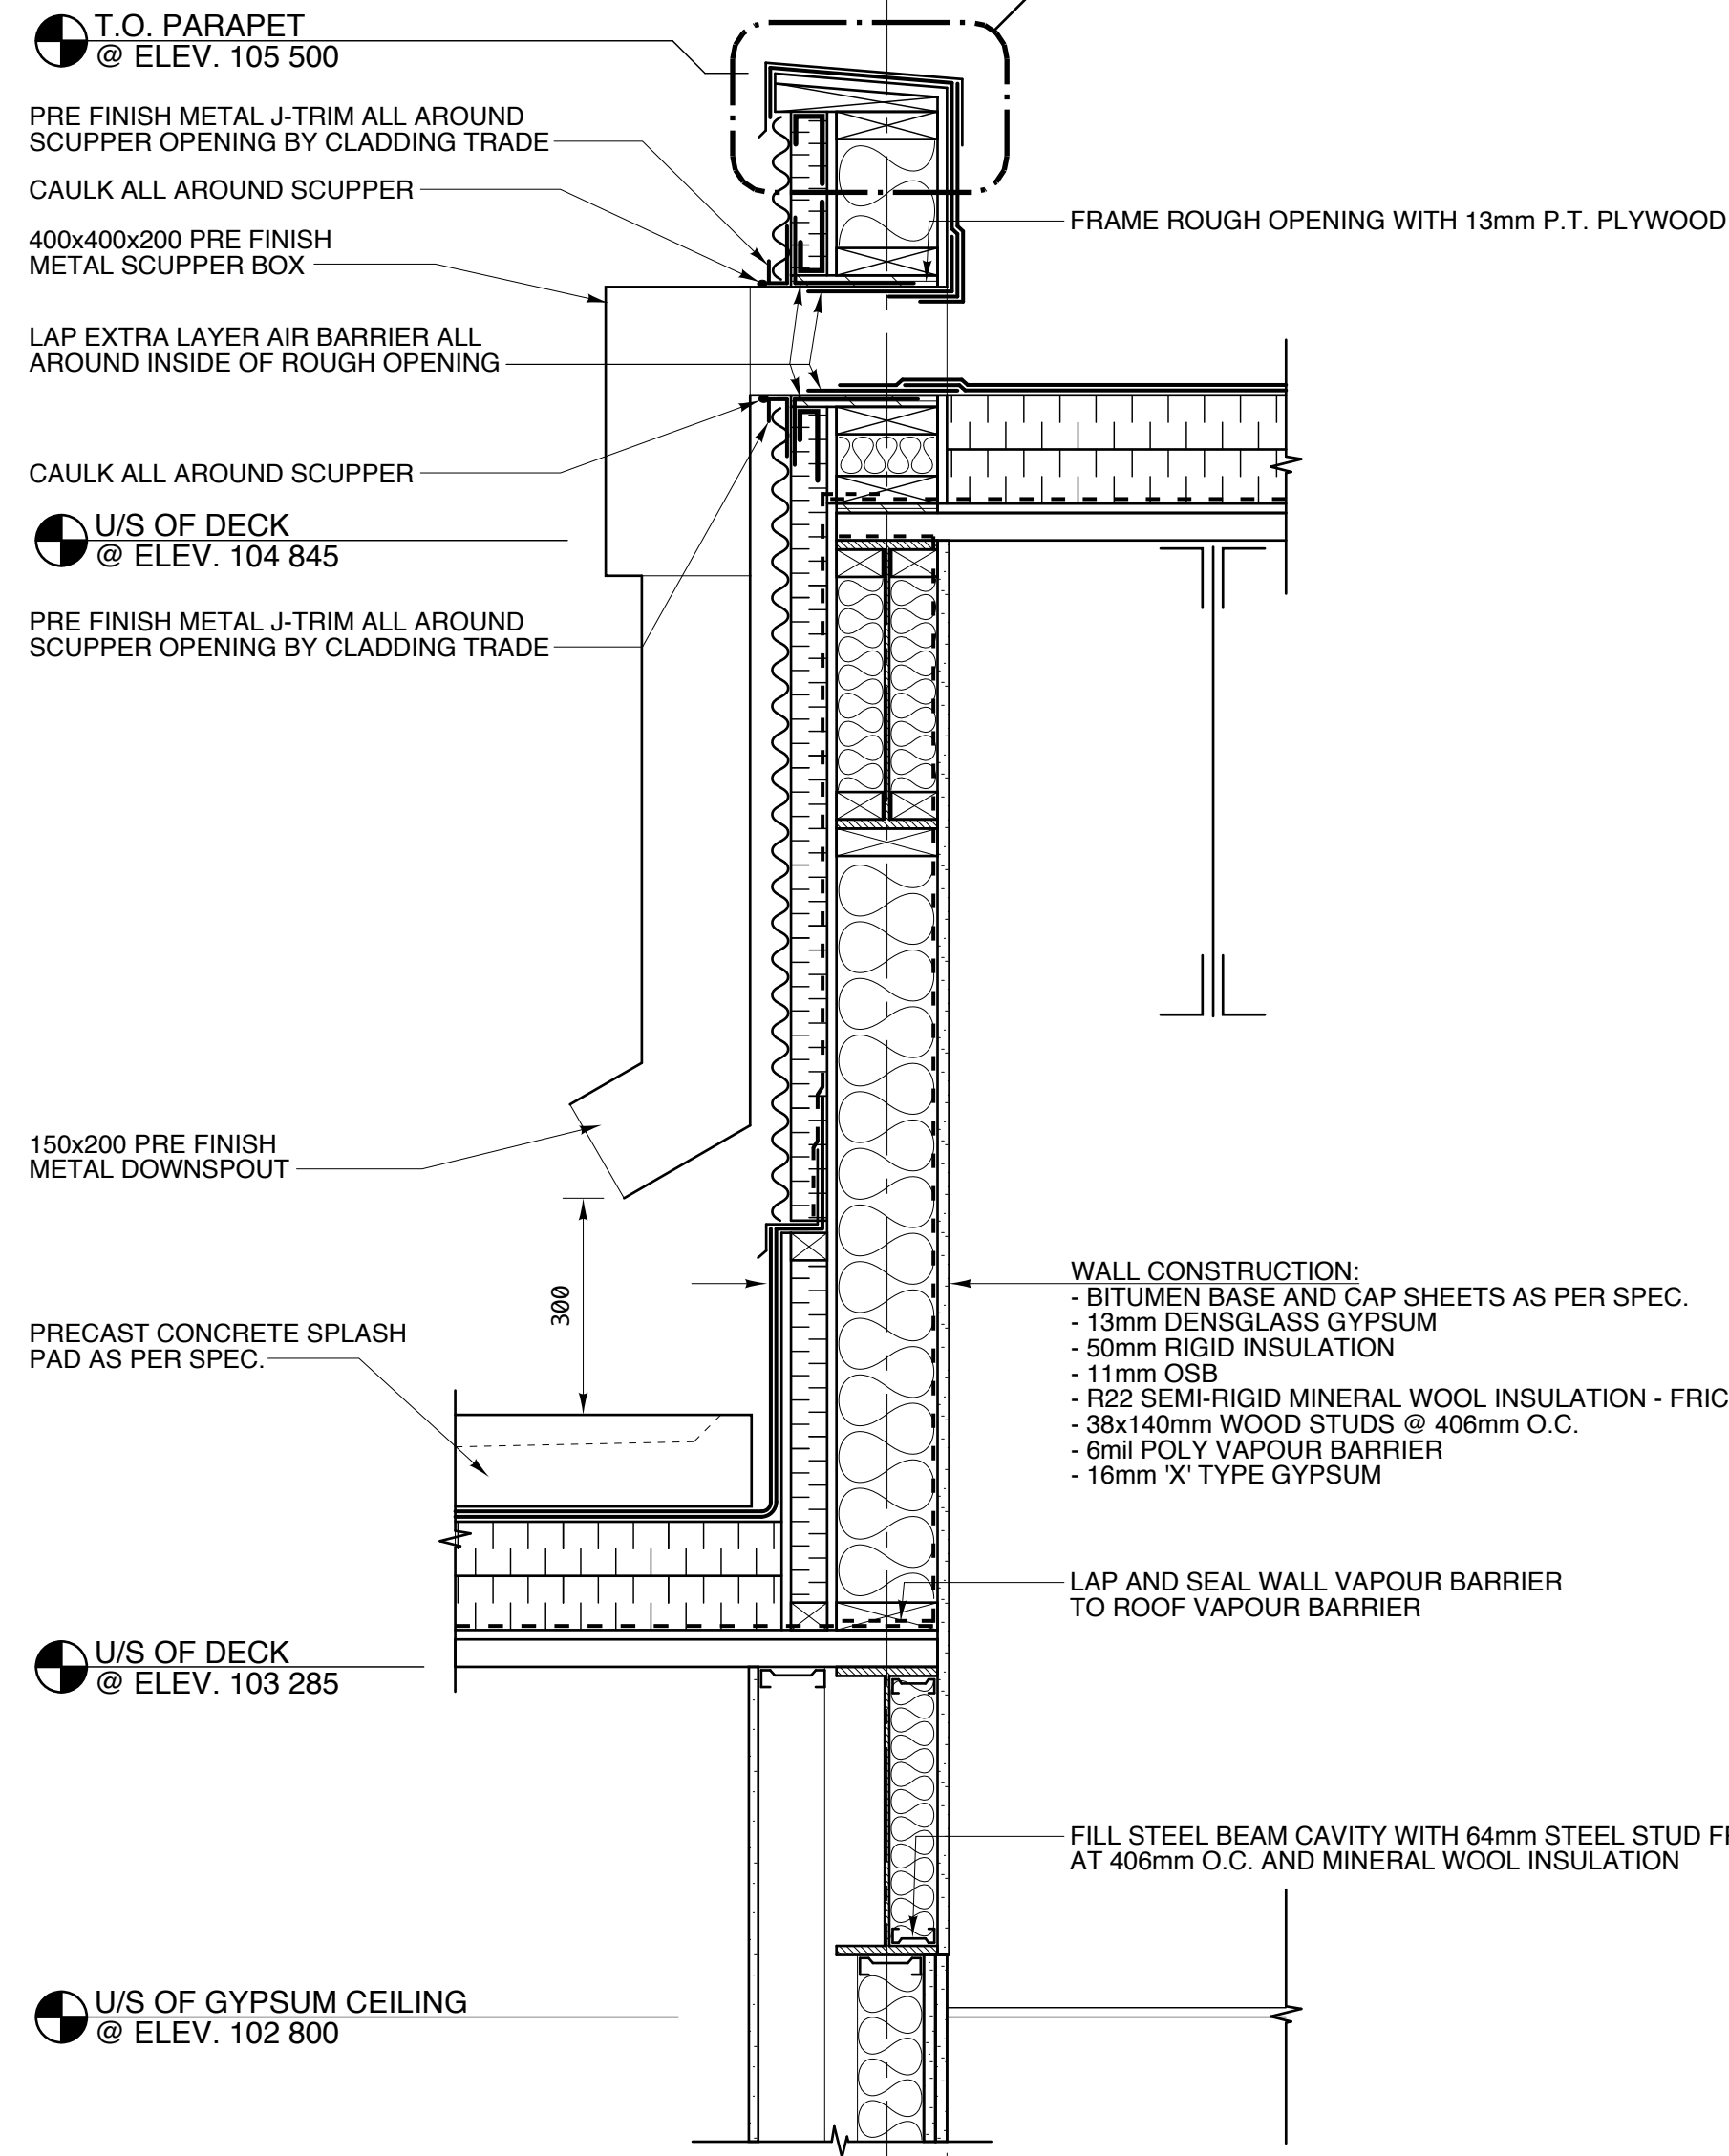

4 SPLASH PAD MOUNTING DETAIL
A-5.2 SCALE 1:10

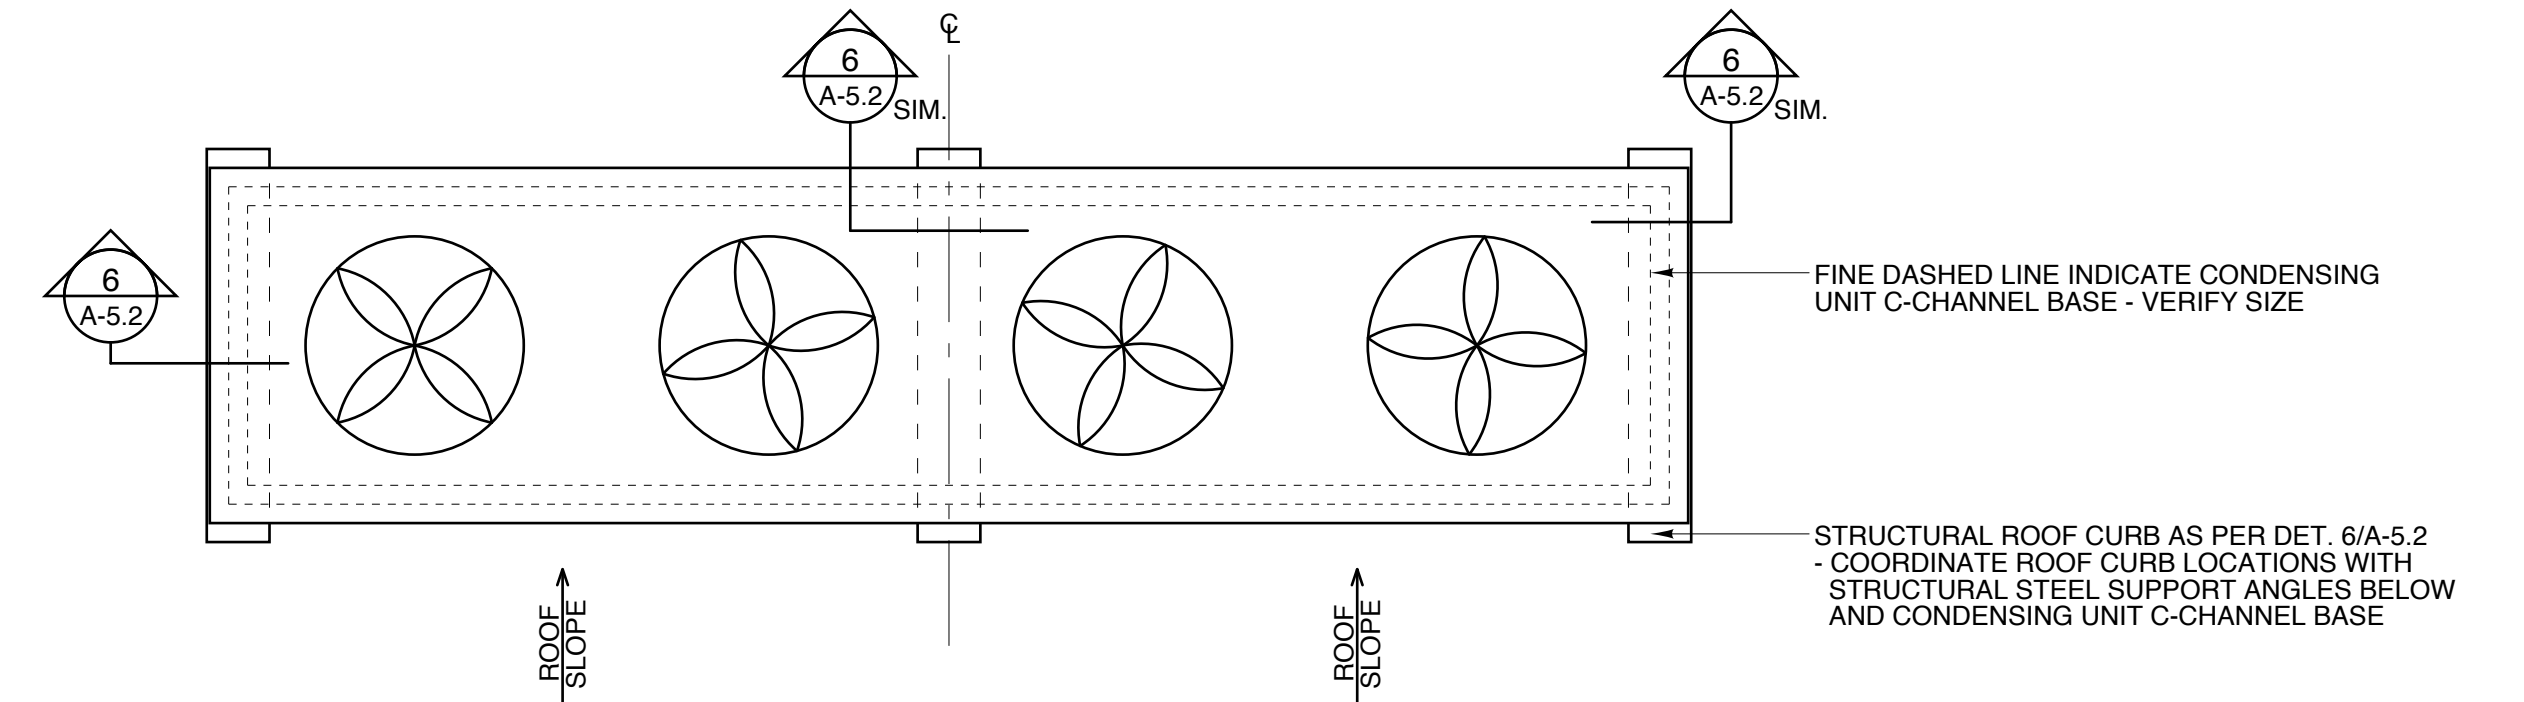

5 CONDENSING UNIT ENLARGED PLAN
A-5.2 SCALE 1:20

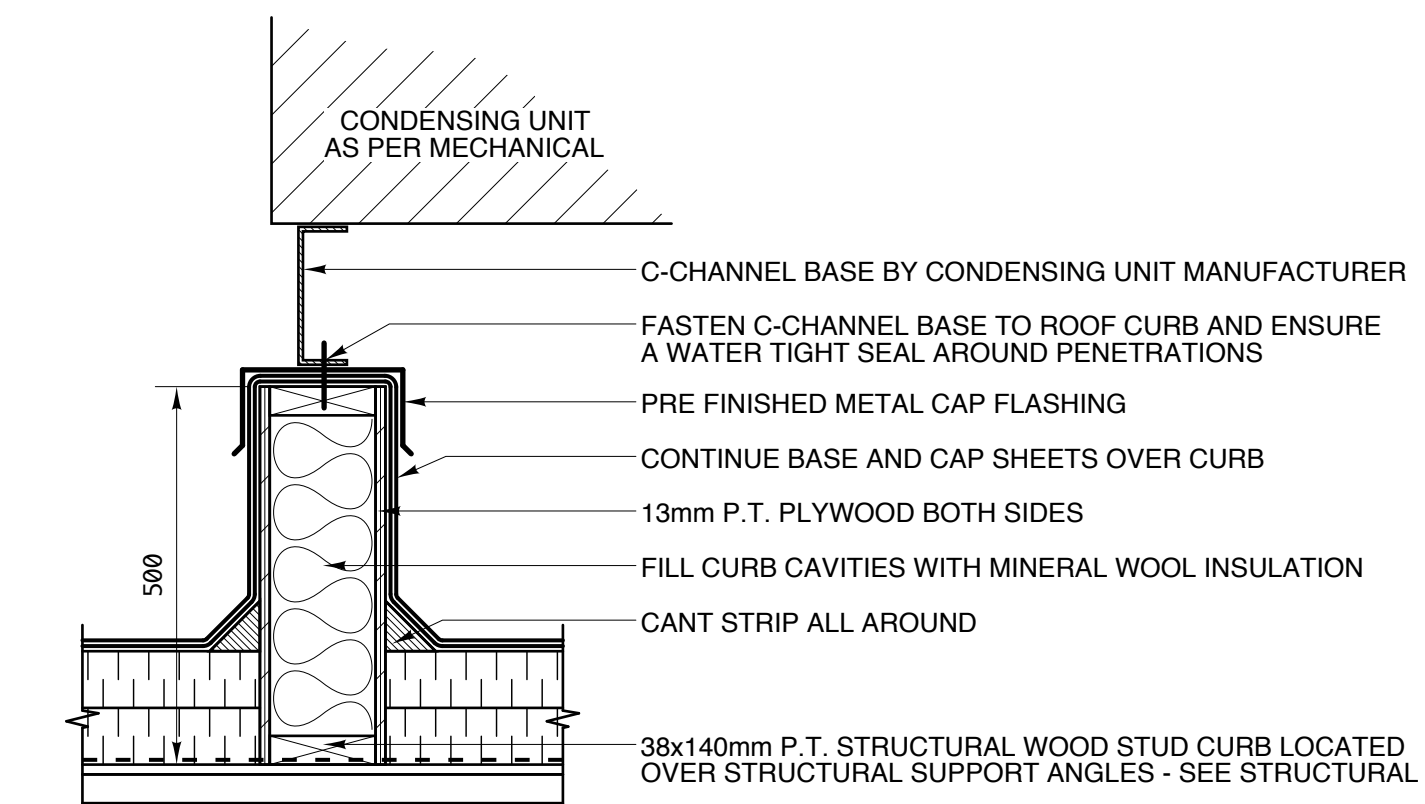

6 CONDENSING UNIT ROOF CURB SECTION DETAIL
A-5.2 SCALE 1:10

revision

This drawing must not be scaled.

The Contractor must verify all dimensions, datums and levels prior to commencement of work. All errors and omissions must be reported immediately to the Contract Administrator.

Variations and modifications to work shown on this drawing shall not be carried out without written permission from the Contractor Administrator.

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project

SINCLAIR PARK COMMUNITY CENTRE
Winnipeg, Manitoba

sheet title

ROOF PLAN DETAILS

project number: 08-011 **drawing number:** AS SHOWN
scale: C.G. **A-5.2**
drawn by: H.F.
approved by: H.F.
date: 26th FEB 2010