


## PLUMBING DEMOLITION NOTES


- REMOVE DRAIN TILES & PERIMETER WEEPING TILE AS SHOWN. CONSULT WITH CLIENT ON CONDITION OF DRAINAGE STONES TO BE REPLACED OR NOT.
- 2 AREA OF BASEMENT CONCRETE SLAB CUT-OUT FOR REPLACEMENT/NEW DRAIN TILES, NEW SUMP PIT, BACKWATER VALVE, CLOSET FLANGES, FLOOR DRAINS SHOWER DRAINS, SEE BASEMENT PLUMBING RENOVATION DRAWING.
- DIMENSION GOVERNED BY ACTUAL EXISTING LOCATION OF DRAIN TILES & SANITARY SEWER, CUT WIDTH SHALL BE 18" WIDE FROM CENTERLINE.
- REMOVE EXISTING CLOSET FLANGE & LINE CONNECTION TO SANITARY SEWER. REWORK SECTION TO ACCEPT RENOVATION.

## PLUMBING RENOVATION NOTES: SUPPLY & INSTALL, UNLESS OTHERWISE NOTED.

- 1 REPLACE EXISTING DRAIN TILES FROM NEW PERIMETER WEEPING TILES TO EXISTING CATCH BASIN. SIZE TO MATCH
- 2 SUMP PIT REPLACE EXISTING CB DRAIN TILE LINE WITH NEW 3" PVC PIPE SLOPE TO DRAIN INTO NEW SUMP PIT.
- CONNECT NEW WEEPING TILE FOR NEW LIFT VESTIBLE TO NEW BUILDING PERIMETER WEEPING TILE SYSTEM.
- 4 IN-FLOOR CONDENSATE 1-1/2" PVC PIPE TRANSITION FROM SOUTH WALL TO NEW FLOOR DRAIN, SEE DRAWING M5.
- 5 PLUMBING DWV STACK SHALL BE PLUMBED AND CENTERED WITH NEW BASEMENT SHOWER WALL & MAIN FLOOR WASHROOM WALL TO CONNECT TO EXISTING VENT STACK AT ROOF.

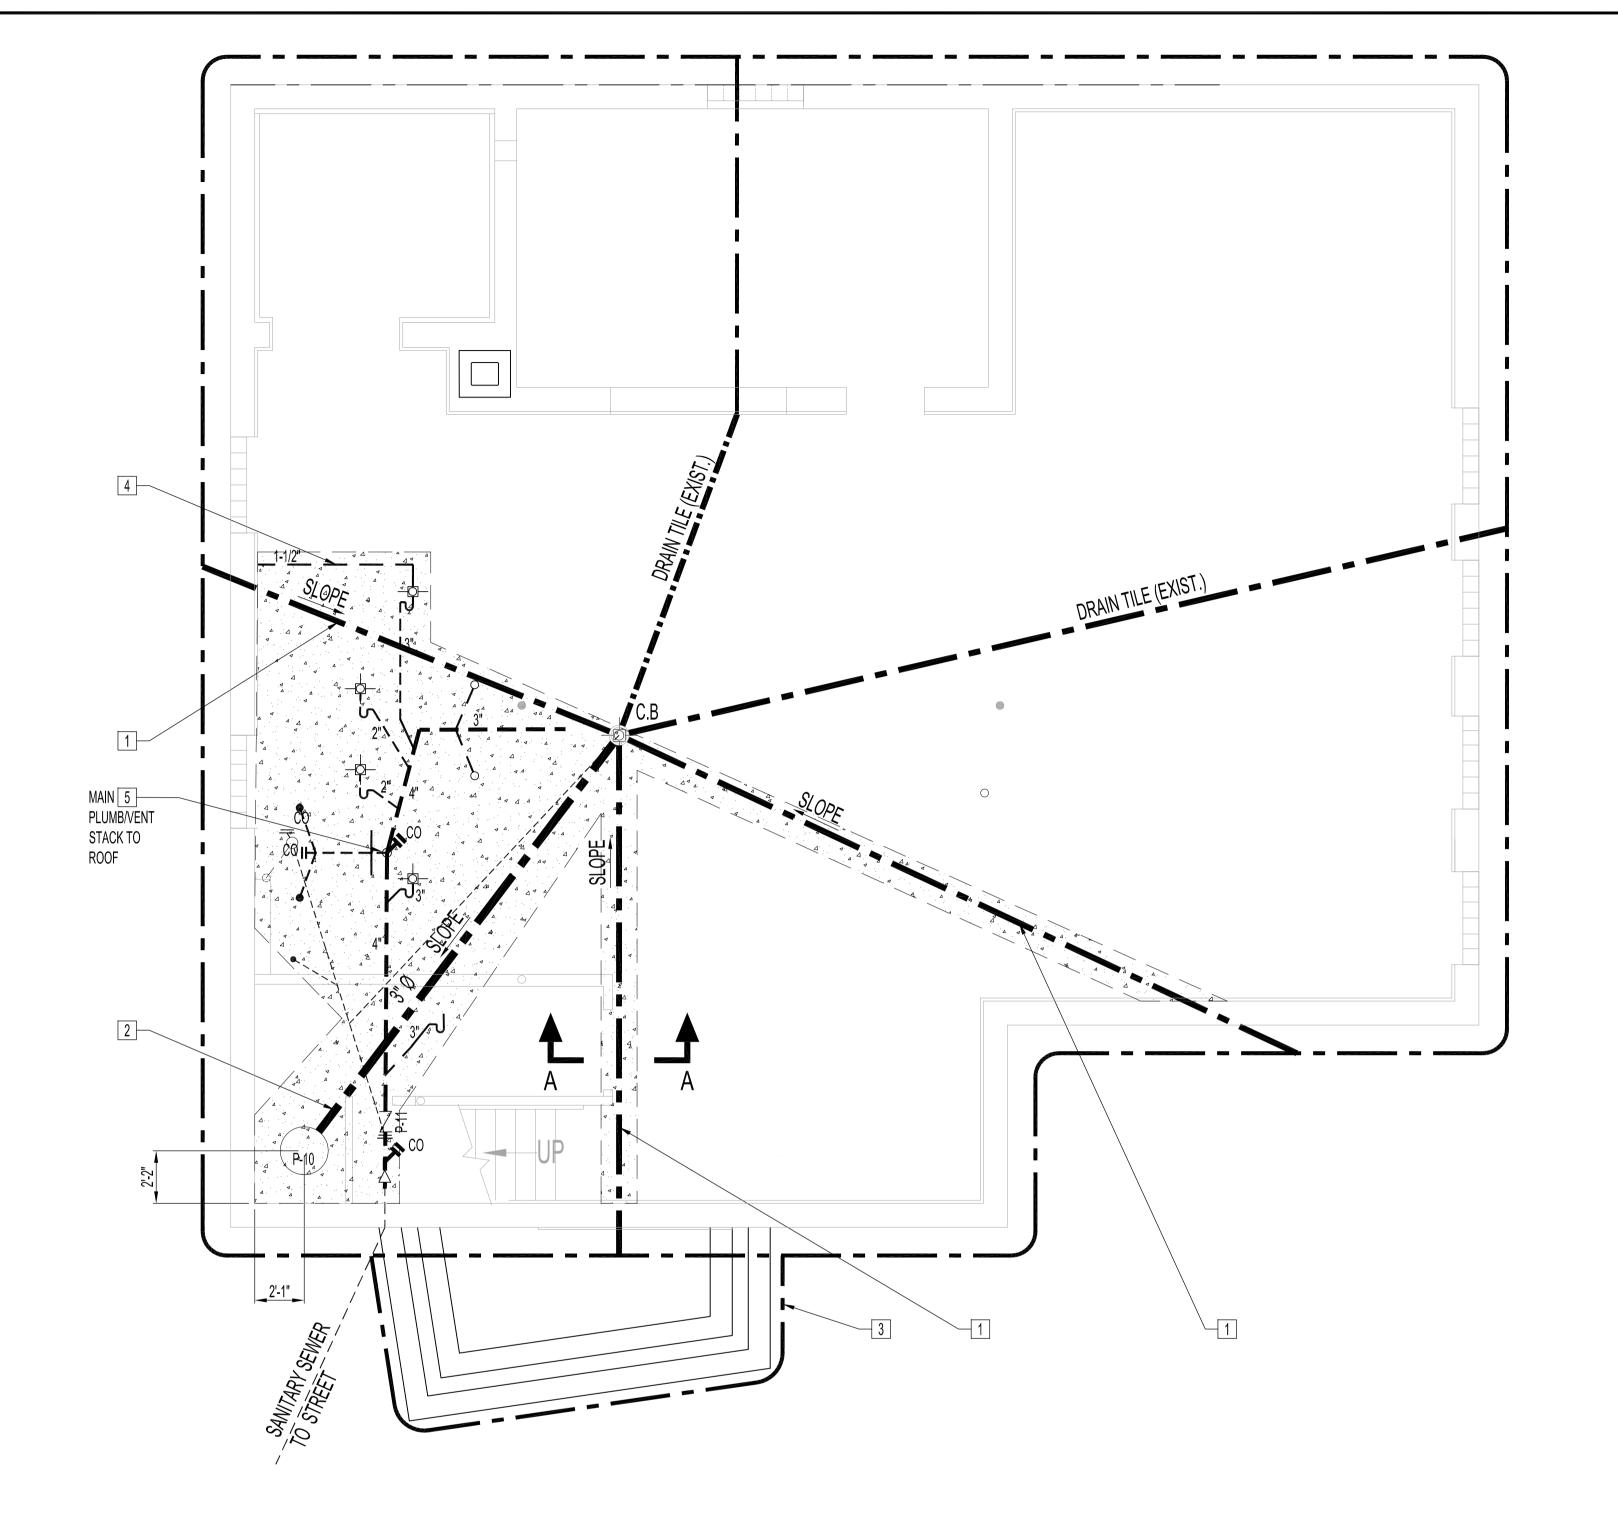



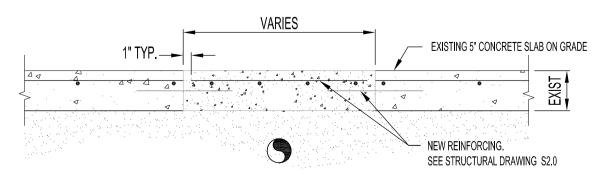

SECTION "A-A" TYPICAL CONCRETE FLOOR CUT SCALE: 1"=1'-0"

ORIGINAL STAMPED BY: DOUG PALEY, P. ENG. DATE: 2007.11.15

NOTES :

SEE NOTES ON DRAWING M1.

NEW BASEMENT CONCRETE FLOOR FINISH SHALL SLOPE TO NEW

FLOOR DRAINS & NEW SHOWER FLOOR DRAINS.

SEE ADDENDUM 4, BID OPPORTUNITY 629-2007. REVISED DUE DTA 2007.11.15 TO WASHROOMS & SHOWERS WERE SEPARATED BY WALLS & UNIVERSAL DESIGN REQUIREMENTS.

REVISION/DESCRIPTION

DRAWN BY DTA CHECKED BY APPROVED 2007.10.11 USER APPROVAL



CITY OF WINNIPEG
PLANNING, PROPERTY &
DEVELOPMENT DEPARTMENT
CIVIC ACCOMMODATIONS DIVISION
300 - 65 GARRY ST. R3C 4K4

**PROJECT** 

COMMUNITY POLICE SERVICE CENTRE

1400 HENDERSON HWY.

SHEET TITLE

BASEMENT FLOOR PLAN IN-FLOOR PLUMBING & CONCRETE FLOOR DEMOLITION AND RENOVATION

SCALE PROJECT NO. SHEET NO. 2004-023 AS SHOWN

DRAWING SHEET SIZE: A1 (841mm x 594mm) PLOT 1:1