
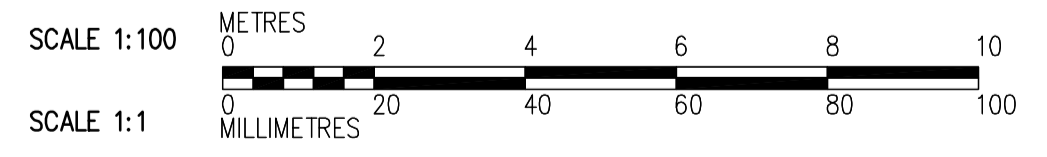


- NOTES:
- DESIGN LIVE LOAD (SNOW) IS:
  - SUPERIMPOSED DEAD LOAD IS 1.0 kPa.
  - PARAPET WALLS TO BE PROVIDED IN SEPARATE CONTRACT ALONG ALL EXTERIOR WALLS AND ALONG ALL EXPANSION JOINTS. FOR DOWEL DETAIL SEE 4 WB-S0464
  - CONNECTION BETWEEN TEE BEAM TO BE SPACED BY PRECAST SUPPLIER AS PER LOAD.
  - CAST-IN-PLACE ANGLE IN UPSTAND BEAM DESIGNED AND SUPPLIED BY PRECAST SUPPLIER, AND INSTALLED BY GENERAL CONTRACTOR.
  - PROVIDE 20mm  $\phi$  SLEEVES IN ALL DOUBLE TEE STEMS 1200mm C/C.

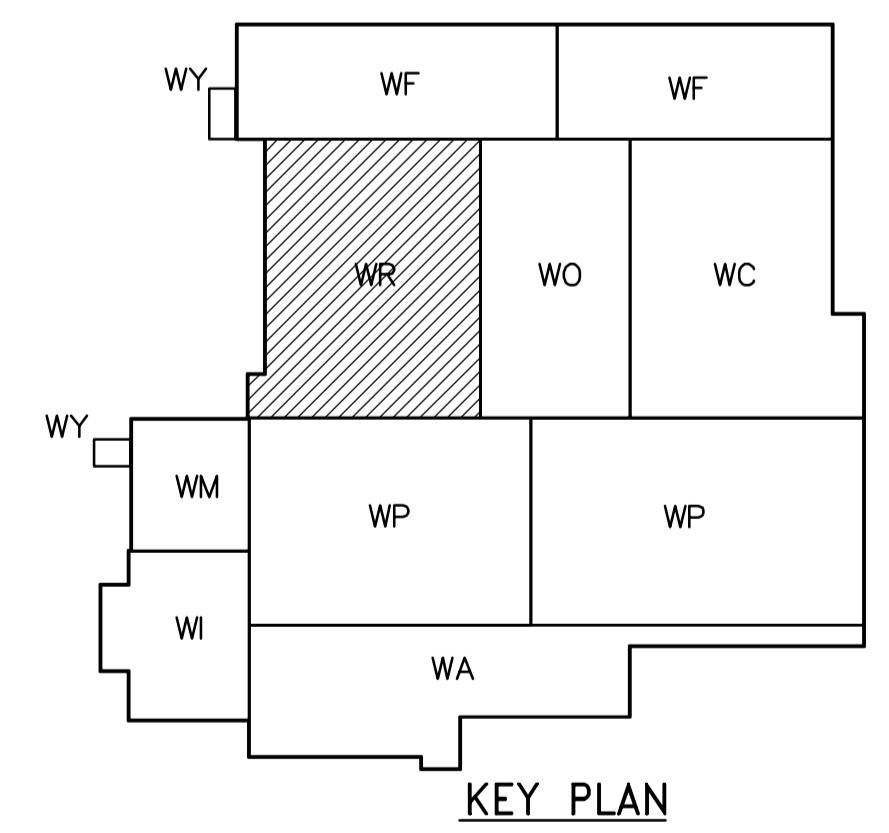

ROOF PLAN  
1:100

<p><b>APEGN</b> Certificate of Authorization CH2M HILL Canada Ltd. No. 1441 Expiry: April 30, 2006</p>	<p>Frederickson Cooper ARCHITECTS</p>		<p>EarthTech A Web International Ltd. Company</p>		<p>ENGINEER'S SEAL</p> <p>ORIGINAL SIGNED BY D. KRUGER 2006/02/06</p> <p>CONSULTANT DRAWING NO. WR-S0146</p>	<p><b>THE CITY OF WINNIPEG</b> WATER AND WASTE DEPARTMENT ENGINEERING DIVISION</p> <p>WATER TREATMENT PLANT RESIDUALS HANDLING FOUNDATIONS AND CONCRETE STRUCTURES</p> <p>STRUCTURAL RESIDUALS HANDLING AREA ROOF PLAN</p>	CITY FILE NUMBER
	DESIGNED BY DK	CHECKED BY AP	SHEET OF				
	DRAWN BY PM	APPROVED BY DJT	CITY DRAWING NUMBER				
	SCALE: 1:100	RELEASED FOR CONSTRUCTION BY: R. SOROKOWSKI	1-060R-A-50146-001-00D				
00 ISSUED FOR TENDER NO. REVISIONS	2006/02/03 DATE	DK	DATE 2005/06/28	DATE 2006/02/08			