
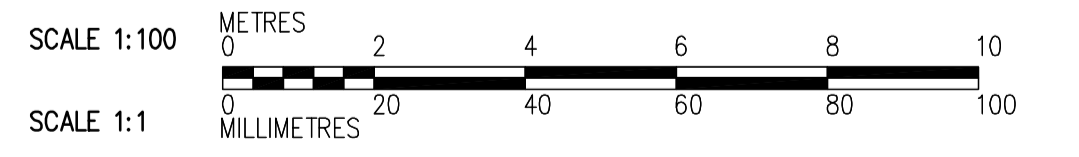


- NOTES:**
- DESIGN SNOW LOAD AS NOTED.
 - SUPERIMPOSED DEAD LOAD IS 1.0 kPa.
 - PARAPET WALLS TO BE PROVIDED IN SEPARATE CONTRACT ALONG ALL EXTERIOR WALLS AND ALONG ALL EXPANSION JOINTS. FOR DOWEL DETAIL SEE 4.
 - CONNECTIONS BETWEEN TEES TO BE SPACED BY PRECAST SUPPLIER AS PER LOADS. SEE 6.
 - CAST-IN PLACE ANGLE IN UPSTAND BEAM DESIGNED AND SUPPLIED BY PRECAST SUPPLIER, AND INSTALLED BY GENERAL CONTRACTOR, SEE 6.
 - NOTE THAT 5 MAY BE USED TO SUPPORT LIGHT FIXTURES INSTALLED UNDER SEPARATE CONTRACT. COORDINATE NUMBER AND LOCATION.
 - PROVIDE 20mm ϕ SLEEVES IN ALL DOUBLE TEE STEMS 1200mm C/C.

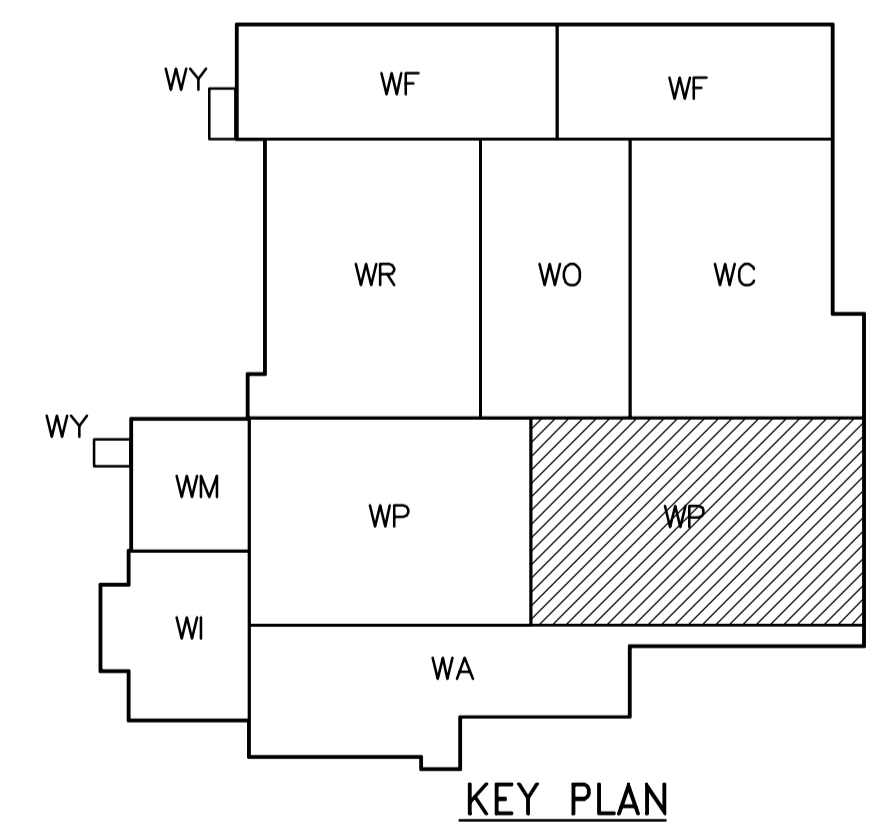

ROOF PLAN
1:100

<p>APEGN Certificate of Authorization CH2M HILL Canada Ltd. No. 1441 Expiry: April 30, 2006</p>	<p>Frederickson Cooper ARCHITECTS</p>	<p>EarthTech A Geo International Ltd. Company</p>	B.M. ELEV.	ENGINEER'S SEAL ORIGINAL SIGNED BY D. KRUGER 2006/02/06	<p>THE CITY OF WINNIPEG WATER AND WASTE DEPARTMENT ENGINEERING DIVISION</p>	
			DESIGNED BY DK CHECKED BY AP	WATER TREATMENT PLANT FLOCCULATION AND DAF FOUNDATIONS AND CONCRETE STRUCTURES		CITY FILE NUMBER
			DRAWN BY RL/PM APPROVED BY DJT	CONSULTANT DRAWING NO. WP-S0147		SHEET OF
			SCALE: 1:100 RELEASED FOR CONSTRUCTION BY: R. SOROKOWSKI	STRUCTURAL FLOC/DAF AREA 2 ROOF PLAN		CITY DRAWING NUMBER 1-060P-A-50147-001-00D
00 ISSUED FOR TENDER 2006/02/03 DK NO. REVISIONS DATE BY	DATE 2005/06/28 DATE 2006/02/08					