




PLAN
5 PILE CAP (2 REQD)

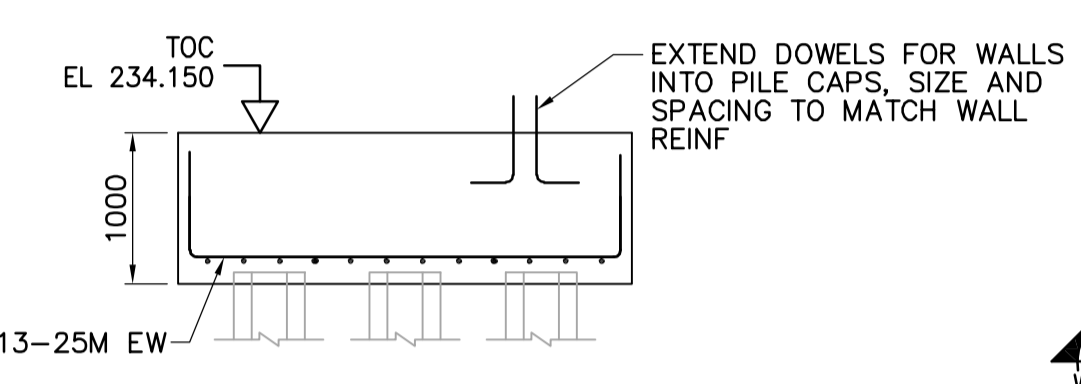

SECTION
H
1:50

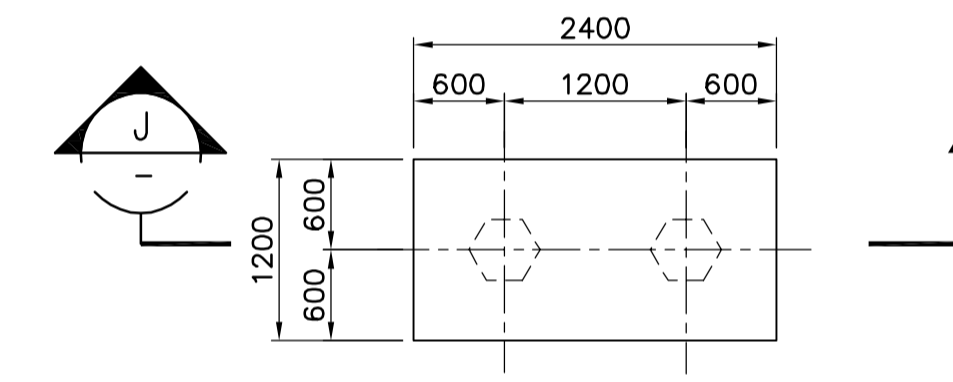

PLAN
2 PILE CAP (3 REQD)

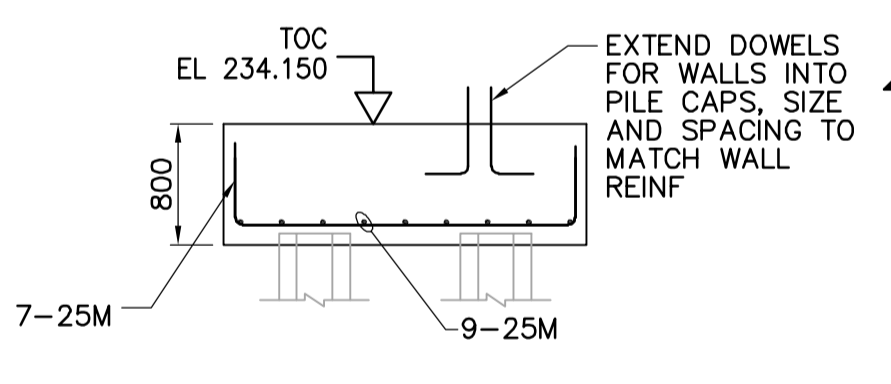

SECTION
J
1:50

PUMP SUPPORT PAD (2 REQD) APPROX. LOCATION SHOWN, TOTAL CONCRETE FOR TENDER: 4 m² X 450 mm HIGH. SEE

250X200 CURB FOR CONC. BLOCK MASONRY WB-S0456

CONCRETE APRON, TYPE "B" SEE

CONCRETE APRON, TYPE "B" SEE

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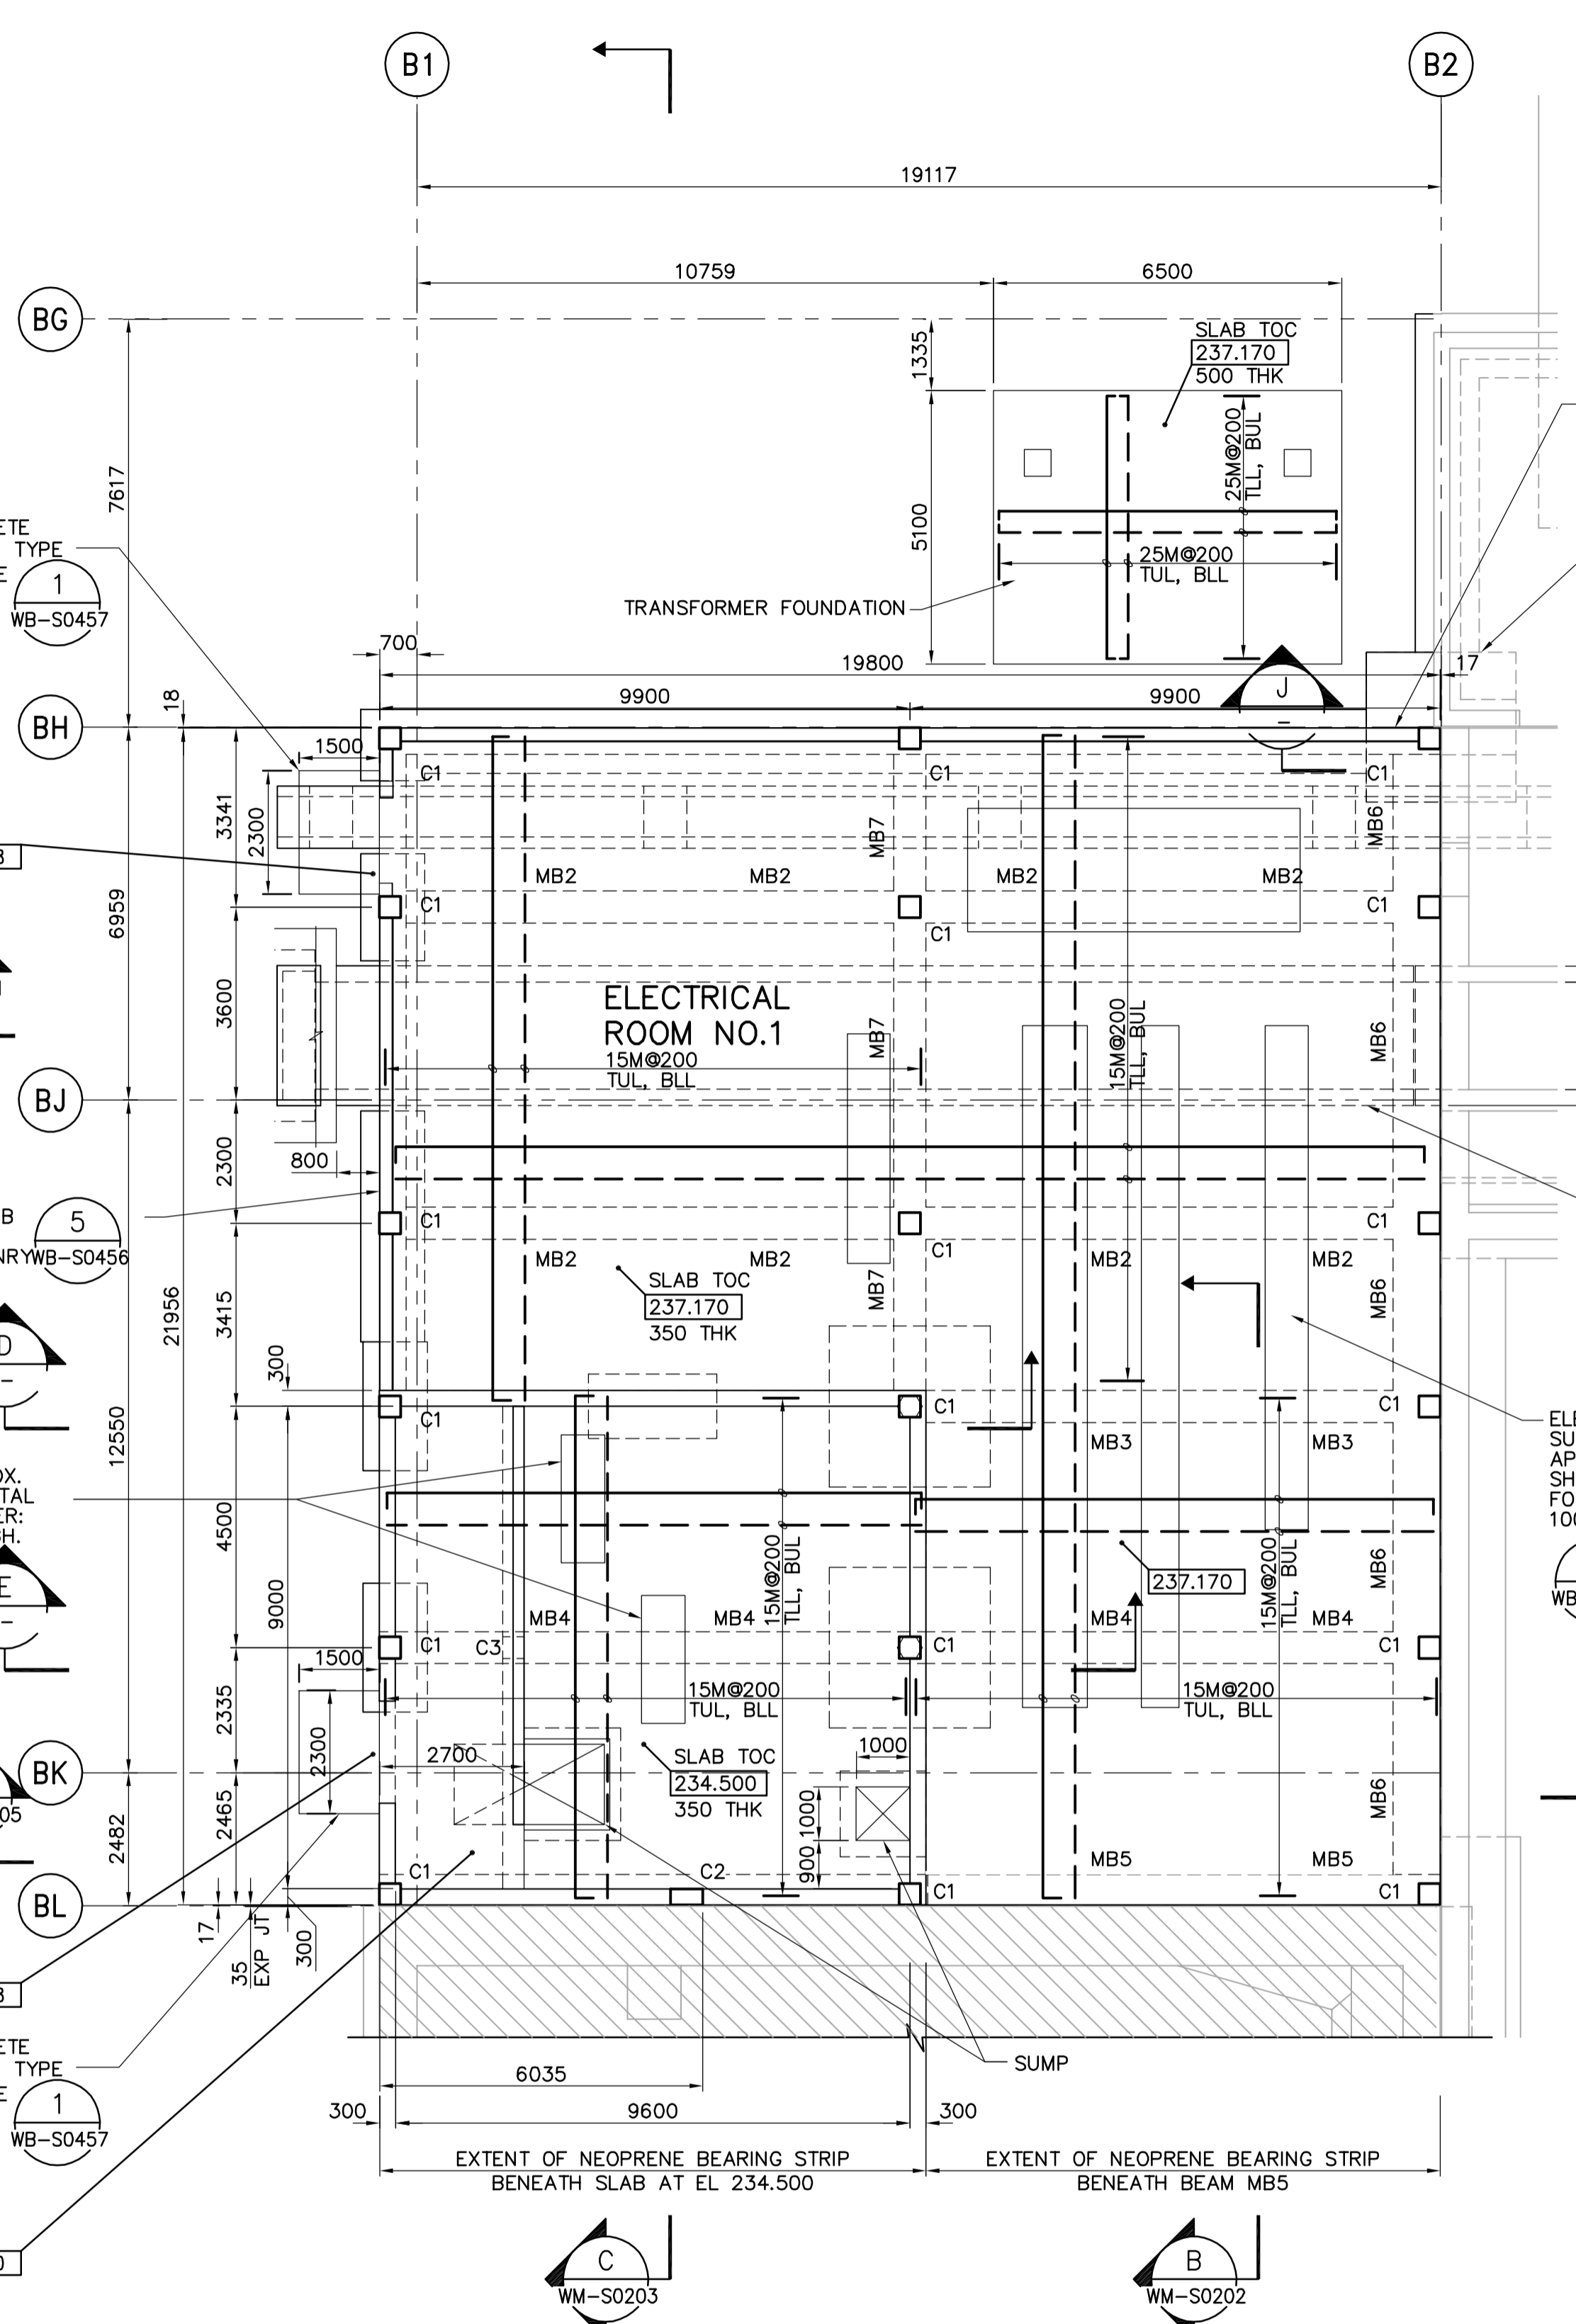
CONCRETE APRON, TYPE "B" SEE

CONCRETE APRON, TYPE "B" SEE

CONCRETE APRON, TYPE "B" SEE

CONCRETE APRON, TYPE "B" SEE

CONCRETE APRON, TYPE "B" SEE



FIRST FLOOR PLAN
1:100

- NOTES:**
- FOR GENERAL NOTES SEE DRAWING WM-S9002.
 - DESIGN LIVE LOAD IS 14.4 kPa.
 - FOR BEAM AND COLUMN SCHEDULES REFER TO DRAWING WM-S0515.
 - REBAR LEGEND: TOP BARS BOTTOM BARS
 - ENCASE ALL PIPING UNDER BUILDING IN CONCRETE.

SEE 1 WB-S0458, 2 WB-S0458, 4 WB-S0458



NOT IN CONTRACT

EXTEND PORTION OF FOUNDATION WALL ALONG GRIDLINE BH NEAR B2 DOWN TO TOP OF PILE CAP

PILE CAP TOC EL 232.500 SEE TYPE 'B' ON DWG WP-S0401

OVER FLOW CONDUIT BELOW

ELECTRICAL EQUIPMENT SUPPORT PADS TYP APPROX. LOCATION SHOWN. TOTAL CONCRETE FOR TENDER: 50 m² X 100 mm HIGH

ELECTRICAL EQUIPMENT SUPPORT PADS TYP APPROX. LOCATION SHOWN. TOTAL CONCRETE FOR TENDER: 50 m² X 100 mm HIGH

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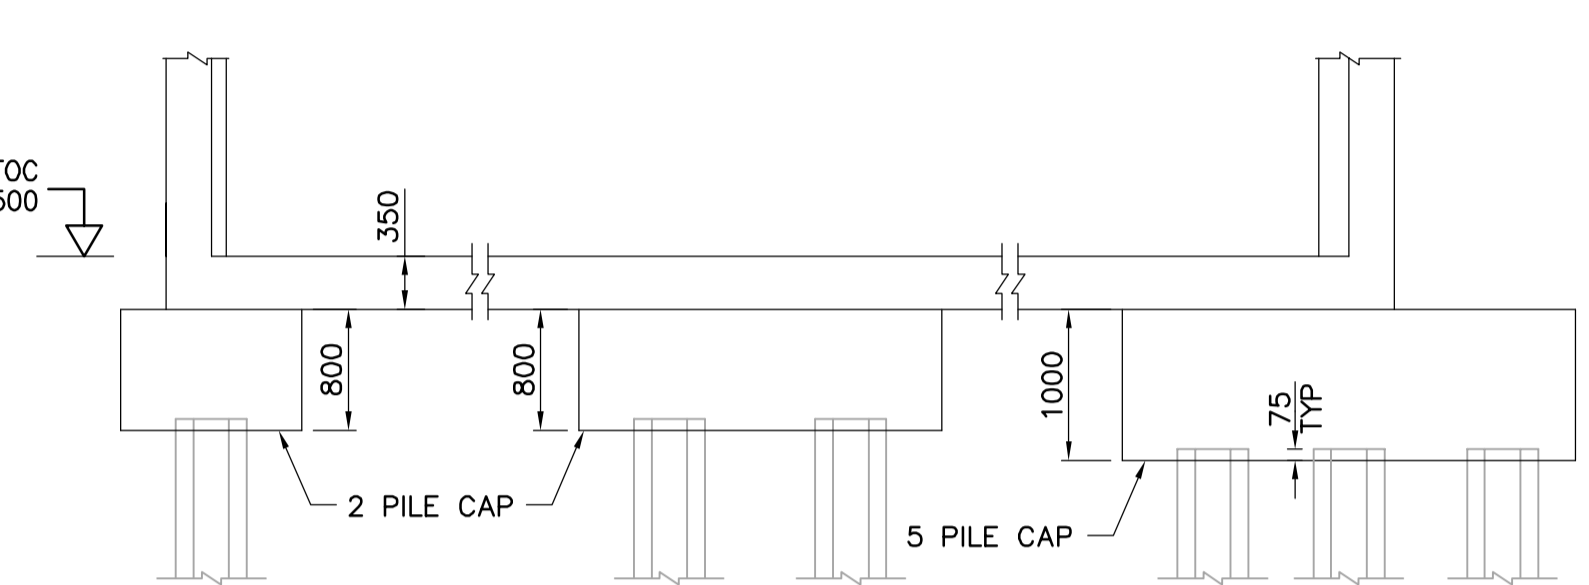
ELECTRICAL EQUIPMENT SUPPORT PADS TYP APPROX. LOCATION SHOWN. TOTAL CONCRETE FOR TENDER: 50 m² X 100 mm HIGH

ELECTRICAL EQUIPMENT SUPPORT PADS TYP APPROX. LOCATION SHOWN. TOTAL CONCRETE FOR TENDER: 50 m² X 100 mm HIGH


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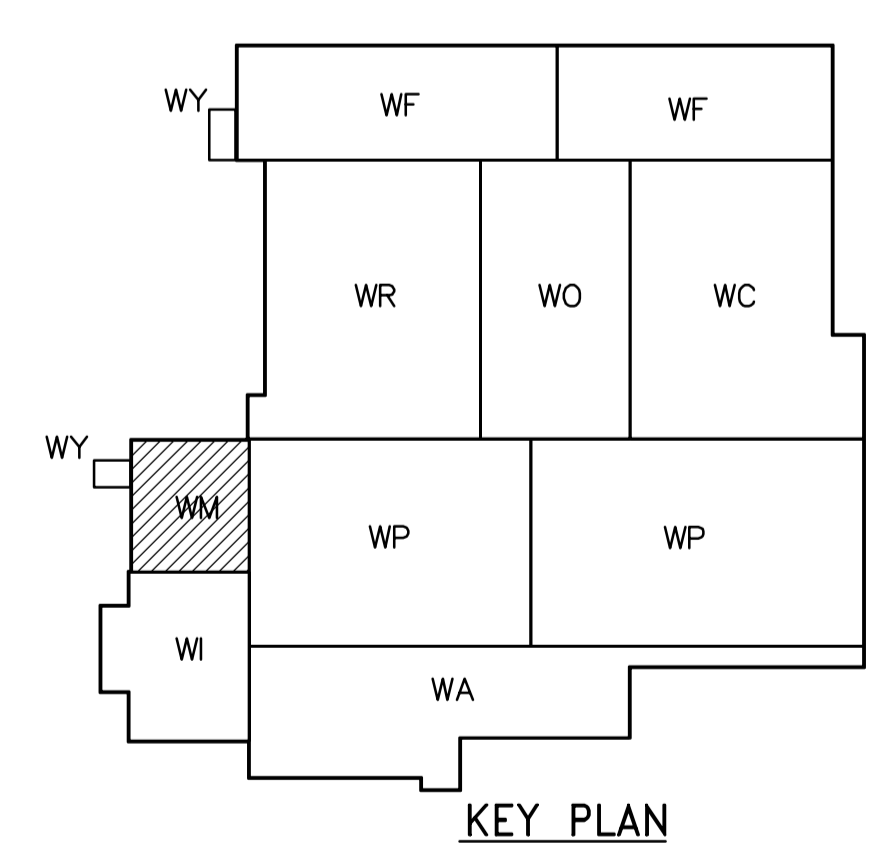
ELECTRICAL EQUIPMENT SUPPORT PADS TYP APPROX. LOCATION SHOWN. TOTAL CONCRETE FOR TENDER: 50 m² X 100 mm HIGH




SECTION
D
1:50



SECTION
E
1:50

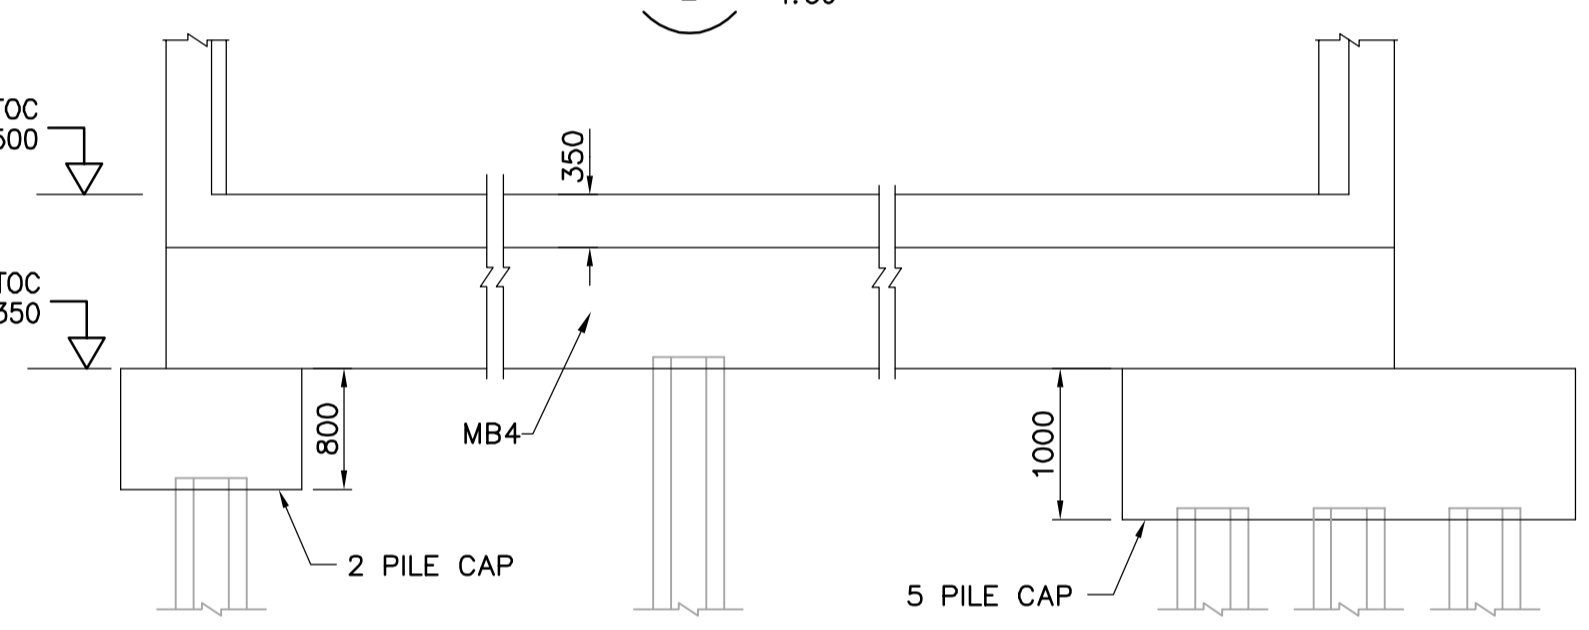

KEY PLAN

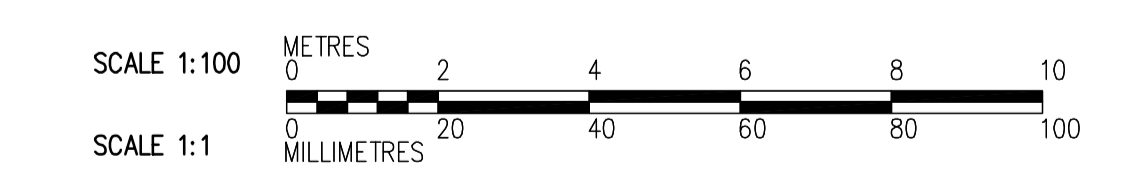

APECA
Certificate of Authorization
CH2M HILL Canada Ltd.
No. 1441 Expiry: April 30, 2006

B.M. ELEV.			
DESIGNED BY	EL	CHECKED BY	AP
DRAWN BY	RL	APPROVED BY	DJT
SCALE:	1:100	RELEASED FOR CONSTRUCTION BY:	R. SOROKOWSKI
ISSUED FOR TENDER	2006/02/03	DATE	2005/09/15
NO. REVISIONS		DATE	2006/02/08

CH2MHILL
Frederickson Cooper ARCHITECTS

EarthTech
A Geo International Ltd. Company

DESIGNED BY: EL
CHECKED BY: AP
DRAWN BY: RL
APPROVED BY: DJT
SCALE: 1:100
RELEASED FOR CONSTRUCTION BY: R. SOROKOWSKI
DATE: 2005/09/15

ENGINEER'S SEAL
ORIGINAL SIGNED BY
D. KRUGER
2006/02/06
CONSULTANT DRAWING NO.
WM-S0111

THE CITY OF WINNIPEG
WATER AND WASTE DEPARTMENT
ENGINEERING DIVISION

WATER TREATMENT PLANT
GENERAL PLANT SERVICES/MISCELLANEOUS
FOUNDATIONS AND CONCRETE STRUCTURES

STRUCTURAL
ELECTRICAL ROOM
FIRST FLOOR PLAN

CITY FILE NUMBER
SHEET OF
CITY DRAWING NUMBER
1-060M-A-S011-001-00D