
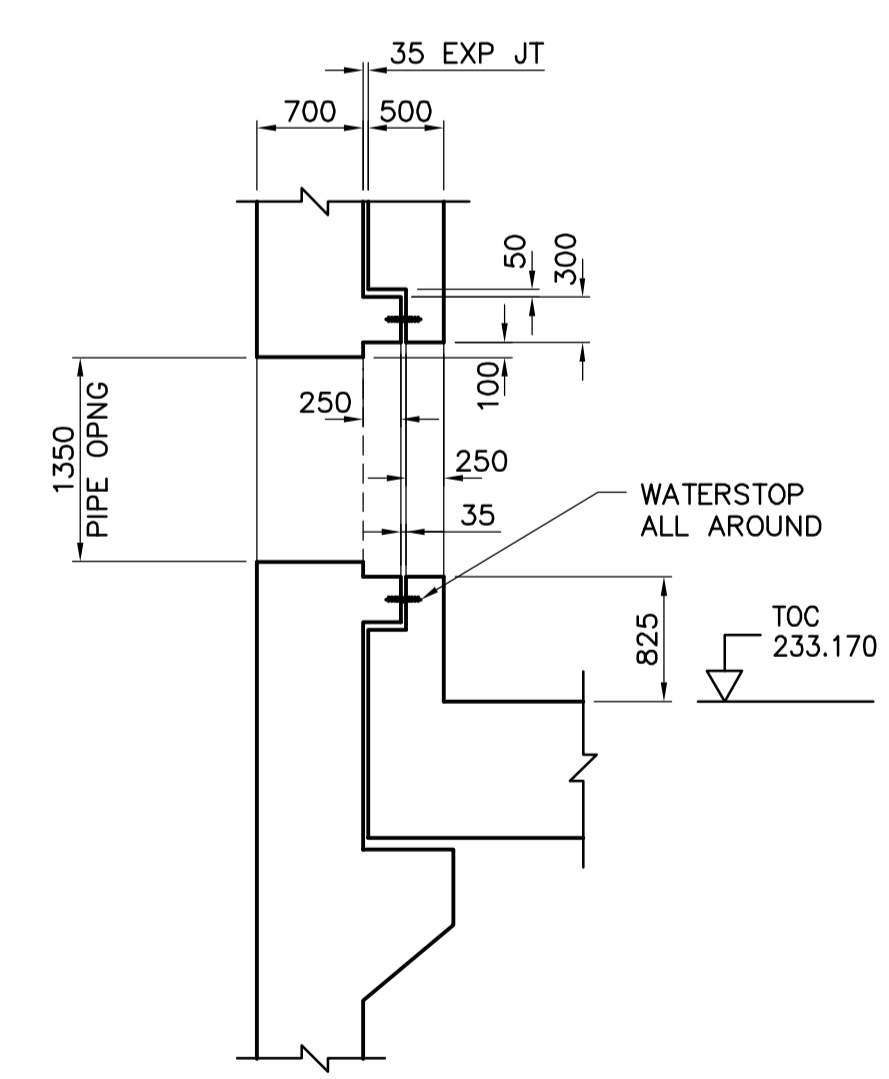


- NOTES:**
- DESIGN LIVE LOAD IS 4.8 kPa UNO.
 - FOR COLUMN AND BEAM SCHEDULE SEE DWG WA-S0515.
 - FOR WALL CORNERS REINF, SEE DWG WA-S0101.


* 300 THICK WALLS TO BE REINFORCED W/ 15M@300 EW, EF W/ MATCHING DOWELS. TYPICAL TO ABOVE

NOT IN CONTRACT

REBAR LEGEND:
 --- TOP BARS
 - - - BOTTOM BARS

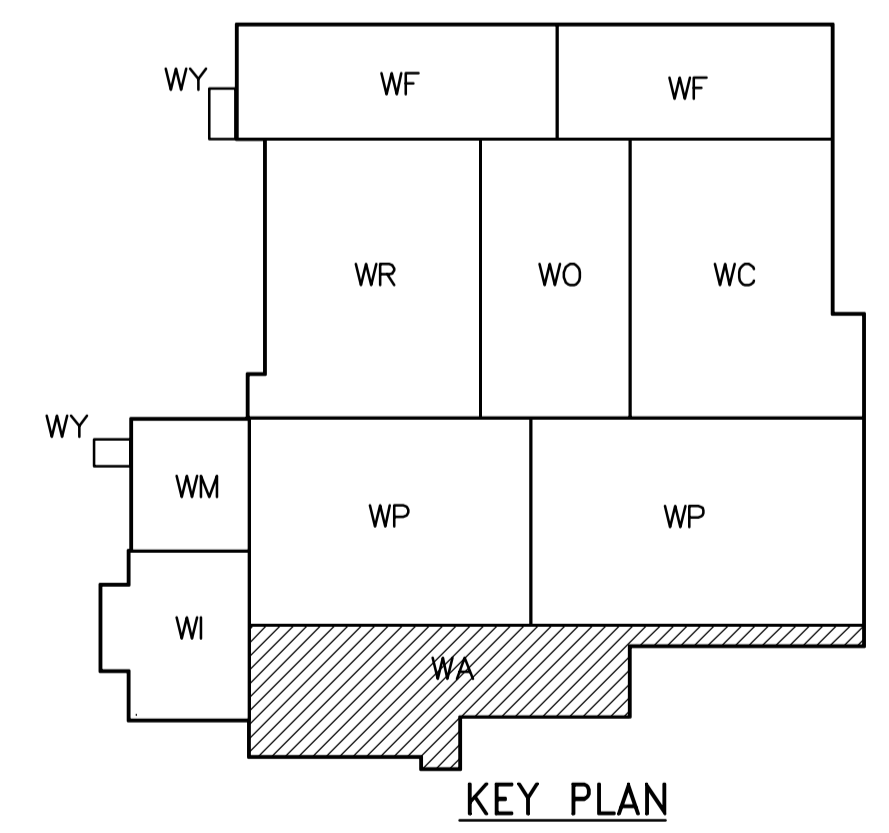

G SECTION
N.T.S.

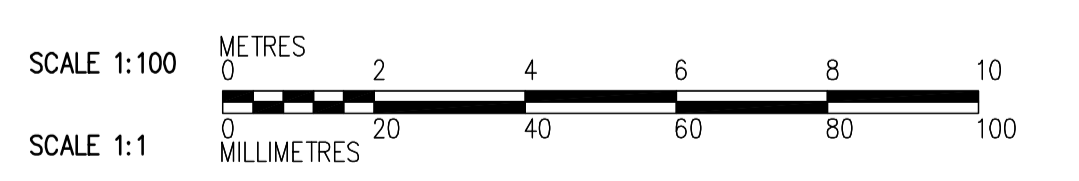

FIRST FLOOR PLAN
1:100

 Certificate of Authorization CH2M HILL Canada Ltd. No. 1441 Expiry: April 30, 2006	B.M. ELEV.	 Frederickson Cooper ARCHITECTS	 A Veolia International Ltd. Company	ENGINEER'S SEAL ORIGINAL SIGNED BY D. KRUGER 2006/02/06	 THE CITY OF WINNIPEG WATER AND WASTE DEPARTMENT ENGINEERING DIVISION WATER TREATMENT PLANT ADMINISTRATION FOUNDATIONS AND CONCRETE STRUCTURES STRUCTURAL ADMINISTRATION AREA FIRST FLOOR PLAN	CITY FILE NUMBER
	00 ISSUED FOR TENDER 2006/02/03 MC NO. REVISIONS DATE BY	DESIGNED BY MC CHECKED BY AP DRAWN BY RL APPROVED BY DJT SCALE: 1:100 RELEASED FOR CONSTRUCTION BY: R. SOROKOWSKI DATE 2005/07/04 DATE 2006/02/08	CONSULTANT DRAWING NO. WA-S0111	SHEET OF CITY DRAWING NUMBER 1-0601A-A-0011-001-00D		