
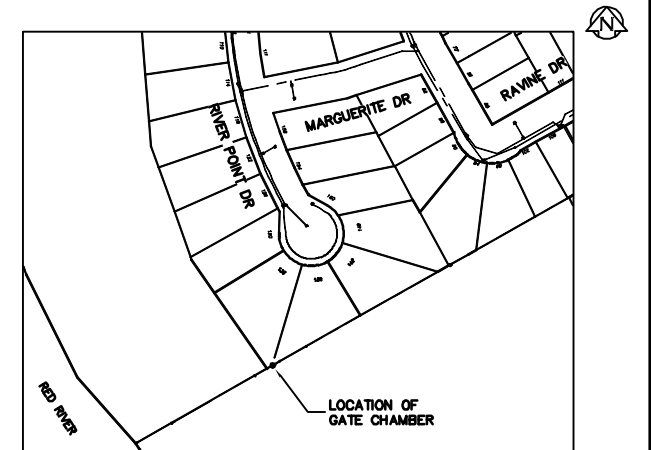


NOTE: CHAINAGES SHOWN ARE ALONG N. P. OF EASEMENT E-038

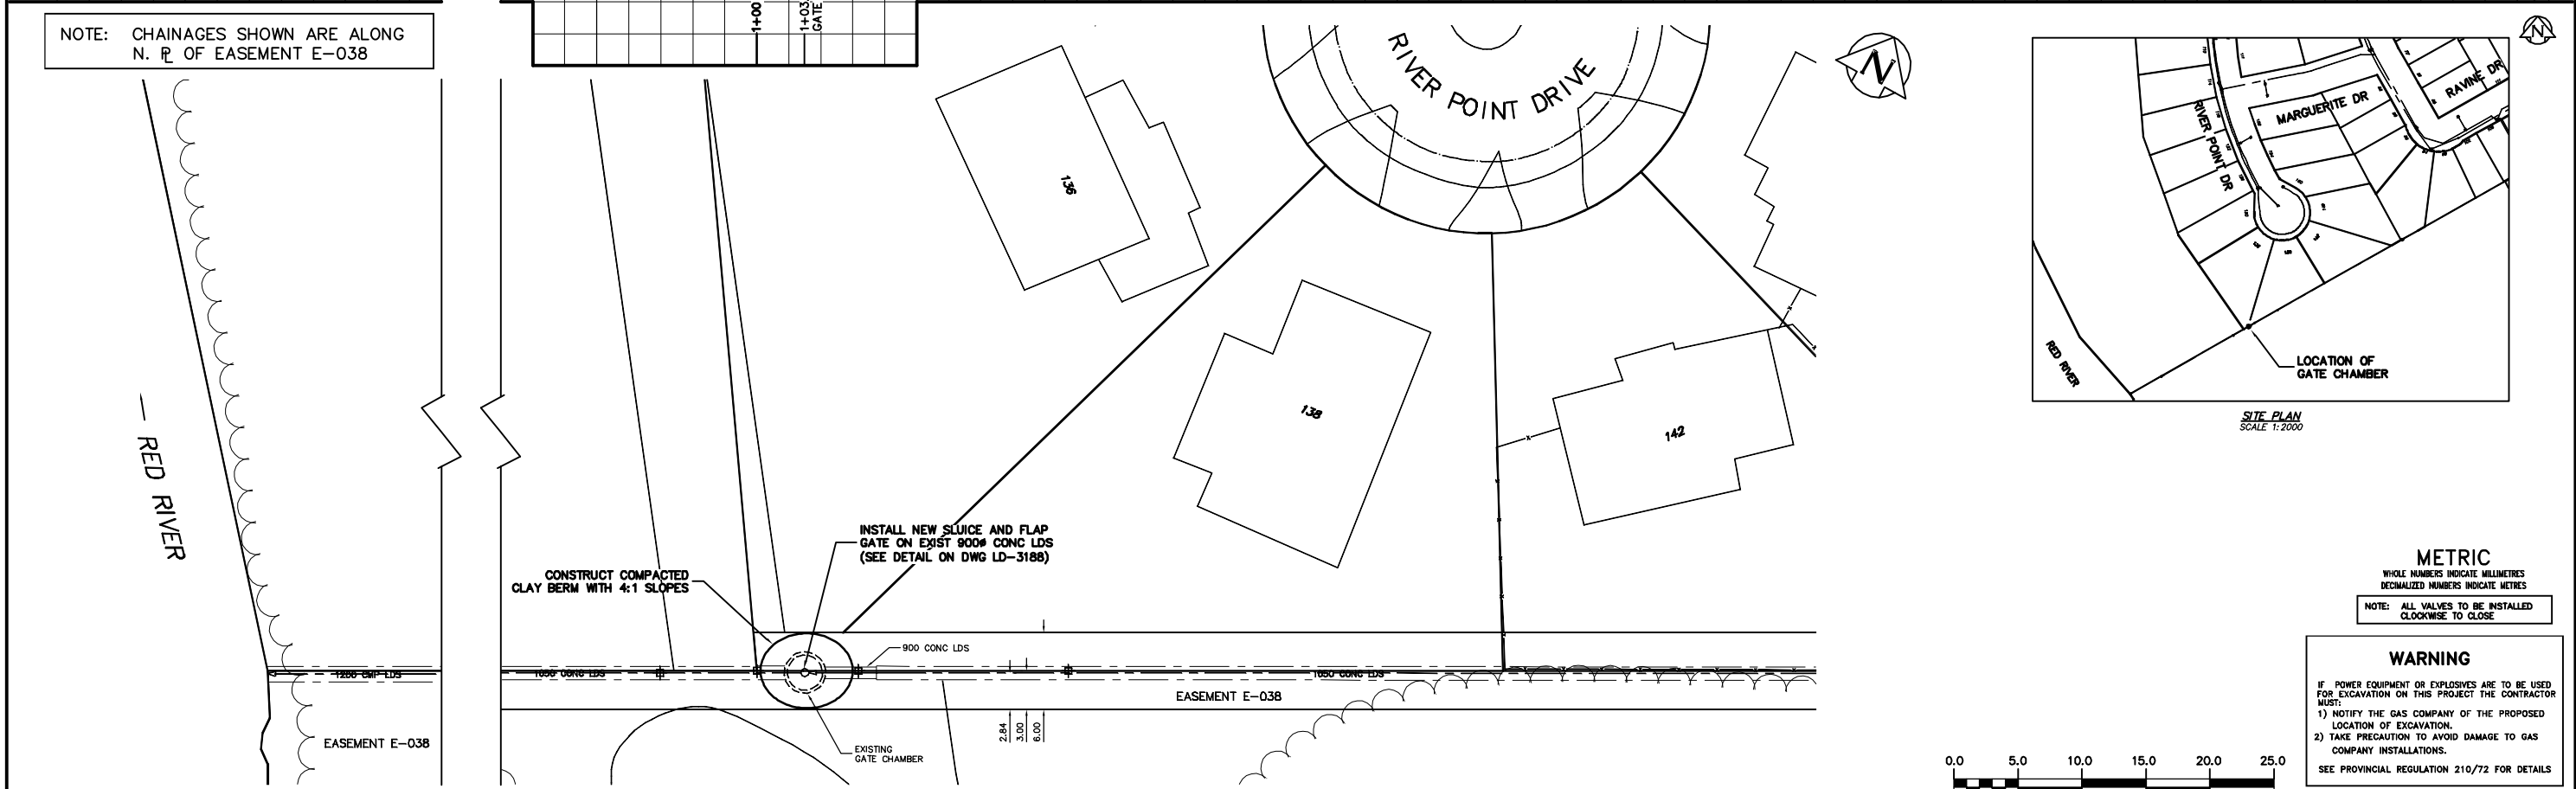

SITE PLAN SCALE 1:2000

METRIC
WHOLE NUMBERS INDICATE MILLIMETRES
DECIMALIZED NUMBERS INDICATE METRES
NOTE: ALL VALVES TO BE INSTALLED CLOCKWISE TO CLOSE

WARNING
IF POWER EQUIPMENT OR EXPLOSIVES ARE TO BE USED FOR EXCAVATION ON THIS PROJECT THE CONTRACTOR MUST:
1) NOTIFY THE GAS COMPANY OF THE PROPOSED LOCATION OF EXCAVATION.
2) TAKE PRECAUTION TO AVOID DAMAGE TO GAS COMPANY INSTALLATIONS.
SEE PROVINCIAL REGULATION 210/72 FOR DETAILS



200 WM	WATERMAIN	200 WM	SL, HYDRO	150 WM	WATERMAIN	150 WM
⊕	HYDRANT	⊕	MTS	⊕	HYDRANT	⊕
⊙	VALVE	⊙	TRAFFIC SIGNALS	⊙	VALVE	⊙
525 LDS	LAND DRAINAGE SEWER	525 LDS	GAS	300 LDS	LAND DRAINAGE SEWER	300 LDS
375 WWS	WASTEWATER SEWER	375 WWS	SURVEY BAR	250 WWS	WASTEWATER SEWER	250 WWS
○	MANHOLE	○	FENCE	⊗	PROFILE	⊗
□	CATCH BASIN	□	POLE - HYDRO, MTS	⊘	GROUND ABOVE PIPE	⊘
▽	CURB INLET	▽	CURB STOP	⊙		⊙
⊕	JUNCTIONS	⊕	GUY ANCHOR			
⊕	CULVERT	⊕	LIGHT STANDARD			
⊕	ANODE	⊕	TREE			
EXISTING	LEGEND-PLAN	PROPOSED	EXISTING	LEGEND-PLAN	PROPOSED	EXISTING
				LEGEND-PROFILE	PROPOSED	

LOCATION APPROVED UNDERGROUND STRUCTURES		B.M. ELEV.	FIELD BOOK #:
SUPPLY U/G STRUCTURES COMMITTEE	DATE	POSTED TO LBS	
NOTE: LOCATION OF UNDERGROUND STRUCTURES AS SHOWN ARE BASED ON THE BEST INFORMATION AVAILABLE BUT NO GUARANTEE IS GIVEN THAT ALL EXISTING UTILITIES ARE SHOWN OR THAT THE GIVEN LOCATIONS ARE EXACT. CONFIRMATION OF EXISTENCE AND EXACT LOCATION OF ALL SERVICES MUST BE OBTAINED FROM THE INDIVIDUAL UTILITIES BEFORE PROCEEDING WITH CONSTRUCTION.		NO. REVISIONS	DATE BY

CITY OF WINNIPEG WATER AND WASTE ENGINEERING DIVISION			
DESIGNED BY	DGS	CHECKED BY	TW
DRAWN BY	SW/CJH	APPROVED BY	KZ
HOR. SCALE	1:250	RELEASED FOR CONSTRUCTION	
VERTICAL	1:50		
DATE	2005 08 31	DATE	

ENGINEER'S SEAL
ORIGINAL SIGNED BY K.R. ZUREK
05/09/01

THE CITY OF WINNIPEG
WATER AND WASTE DEPARTMENT
2005 OUTFALL GATE CHAMBER UPGRADES
RIVER POINT DRIVE
LDS OUTFALL GATE CHAMBER
SITE PLAN

SHEET 6 OF 9
CITY DRAWING NUMBER
LD-3187

BID OPPORTUNITY: 493-2005
FILENAME: LD-3187.dwg
PLOT DATE: 2005 08 31