


Partial Plan - Upper Gym South Wall

Scale: 1:75

REVISIONS		
NO.	DATE	PARTICULARS
0	2003-07-31	ISSUED FOR DESIGN REVIEW
0	2004-07-12	ISSUED - ACCESSIBILITY REVIEW
0	2004-07-12	ISSUED - PUBLIC WORKS REVIEW
0	2004-10-28	FINAL - PUBLIC WORKS REVIEW
0	2004-12-22	ISSUED FOR TENDER
1	2005-03-23	EXPANDED TENDER

- GENERAL NOTES**
- AT WOOD WALLS SUPPORTING A WOOD ROOF STRUCTURE ENSURE GYP BD IS TYPE 'X' AND WRAP 16 GWB TYPE 'X' INTO OPENING.
  - REFER TO INTERIOR ELEVATIONS FOR HEIGHTS AND EXTENT OF STRAWBOARD AND TILE FINISHES
  - CONFIRM WALL STUD SIZES WITH STRUCTURAL WHERE CONFLICT EXISTS, USE LARGER STUD SIZE.
  - SUBSTITUTE NOTED GYP BD. WITH MOISTURE RESISTANT GYP BD. AT INTERIOR WASHROOM WALLS
  - AT CURVED STUD WALLS REDUCE SPACING TO 200 O/C AND BLD. UP GYP BD. WITH MULT-LAYERS FOR TOTAL GYP BD. THICKNESS.
  - AT FIRE RATED WALLS USE TYPE 'X' GYP BD.
  - PREFER TO GROUND PLAN DWG 11A2-1 PROVIDE 150 PERFORATED WEeping TILE AROUND ENTIRE BLDG PERIMETER CW FILTER SOCK DIRECT INTO SUMP PIT W/ 150 NON-PERFORATED PIPE. DISCHARGE THROUGH SIDEWALL ONTO P.C. SPLASHPAD ABOVE GRADE.
  - PROVIDE ROCK BORDER ON FILTER FABRIC OVER COMPACTED FILL. (REFER TO SPEC SECT. 04233 RANDOM ASHLAR LIMESTONE)
  - EXTEND ALL INTERIOR WALLS TO US STRUCTURE UNLESS NOTED.

PROFESSIONAL SEALS

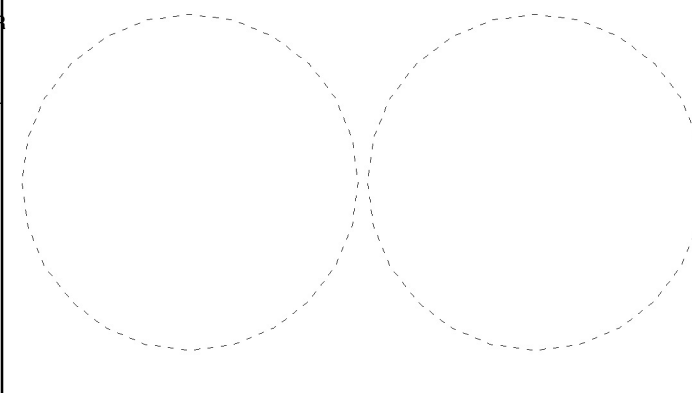

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PROJECT TITLE  
**RED RIVER COMMUNITY CENTRE REDEVELOPMENT**


LOCATION  
 WINNIPEG, MB  
 293 MURRAY AVENUE

CLIENT  
 THE CITY OF WINNIPEG

DRAWING TITLE  
**Ground Floor Plan**

DRAWN	APPROVED	DRAWING
GK / SL / CW	DT	<b>A2-1</b>
SCALE	DATE ISSUED	
1:75	2005-03-23	
JOB NUMBER	DATE PLOTTED	REVISION
2003-06	3/23/05	R-1

ORIGINAL SEALED BY:  
 Dudley T. Thompson  
 B.E.S. B.Arch. M.R.A.I.C.  
 M.A.A. O.A.A. S.A.A.  
 Date: 2005-03-23

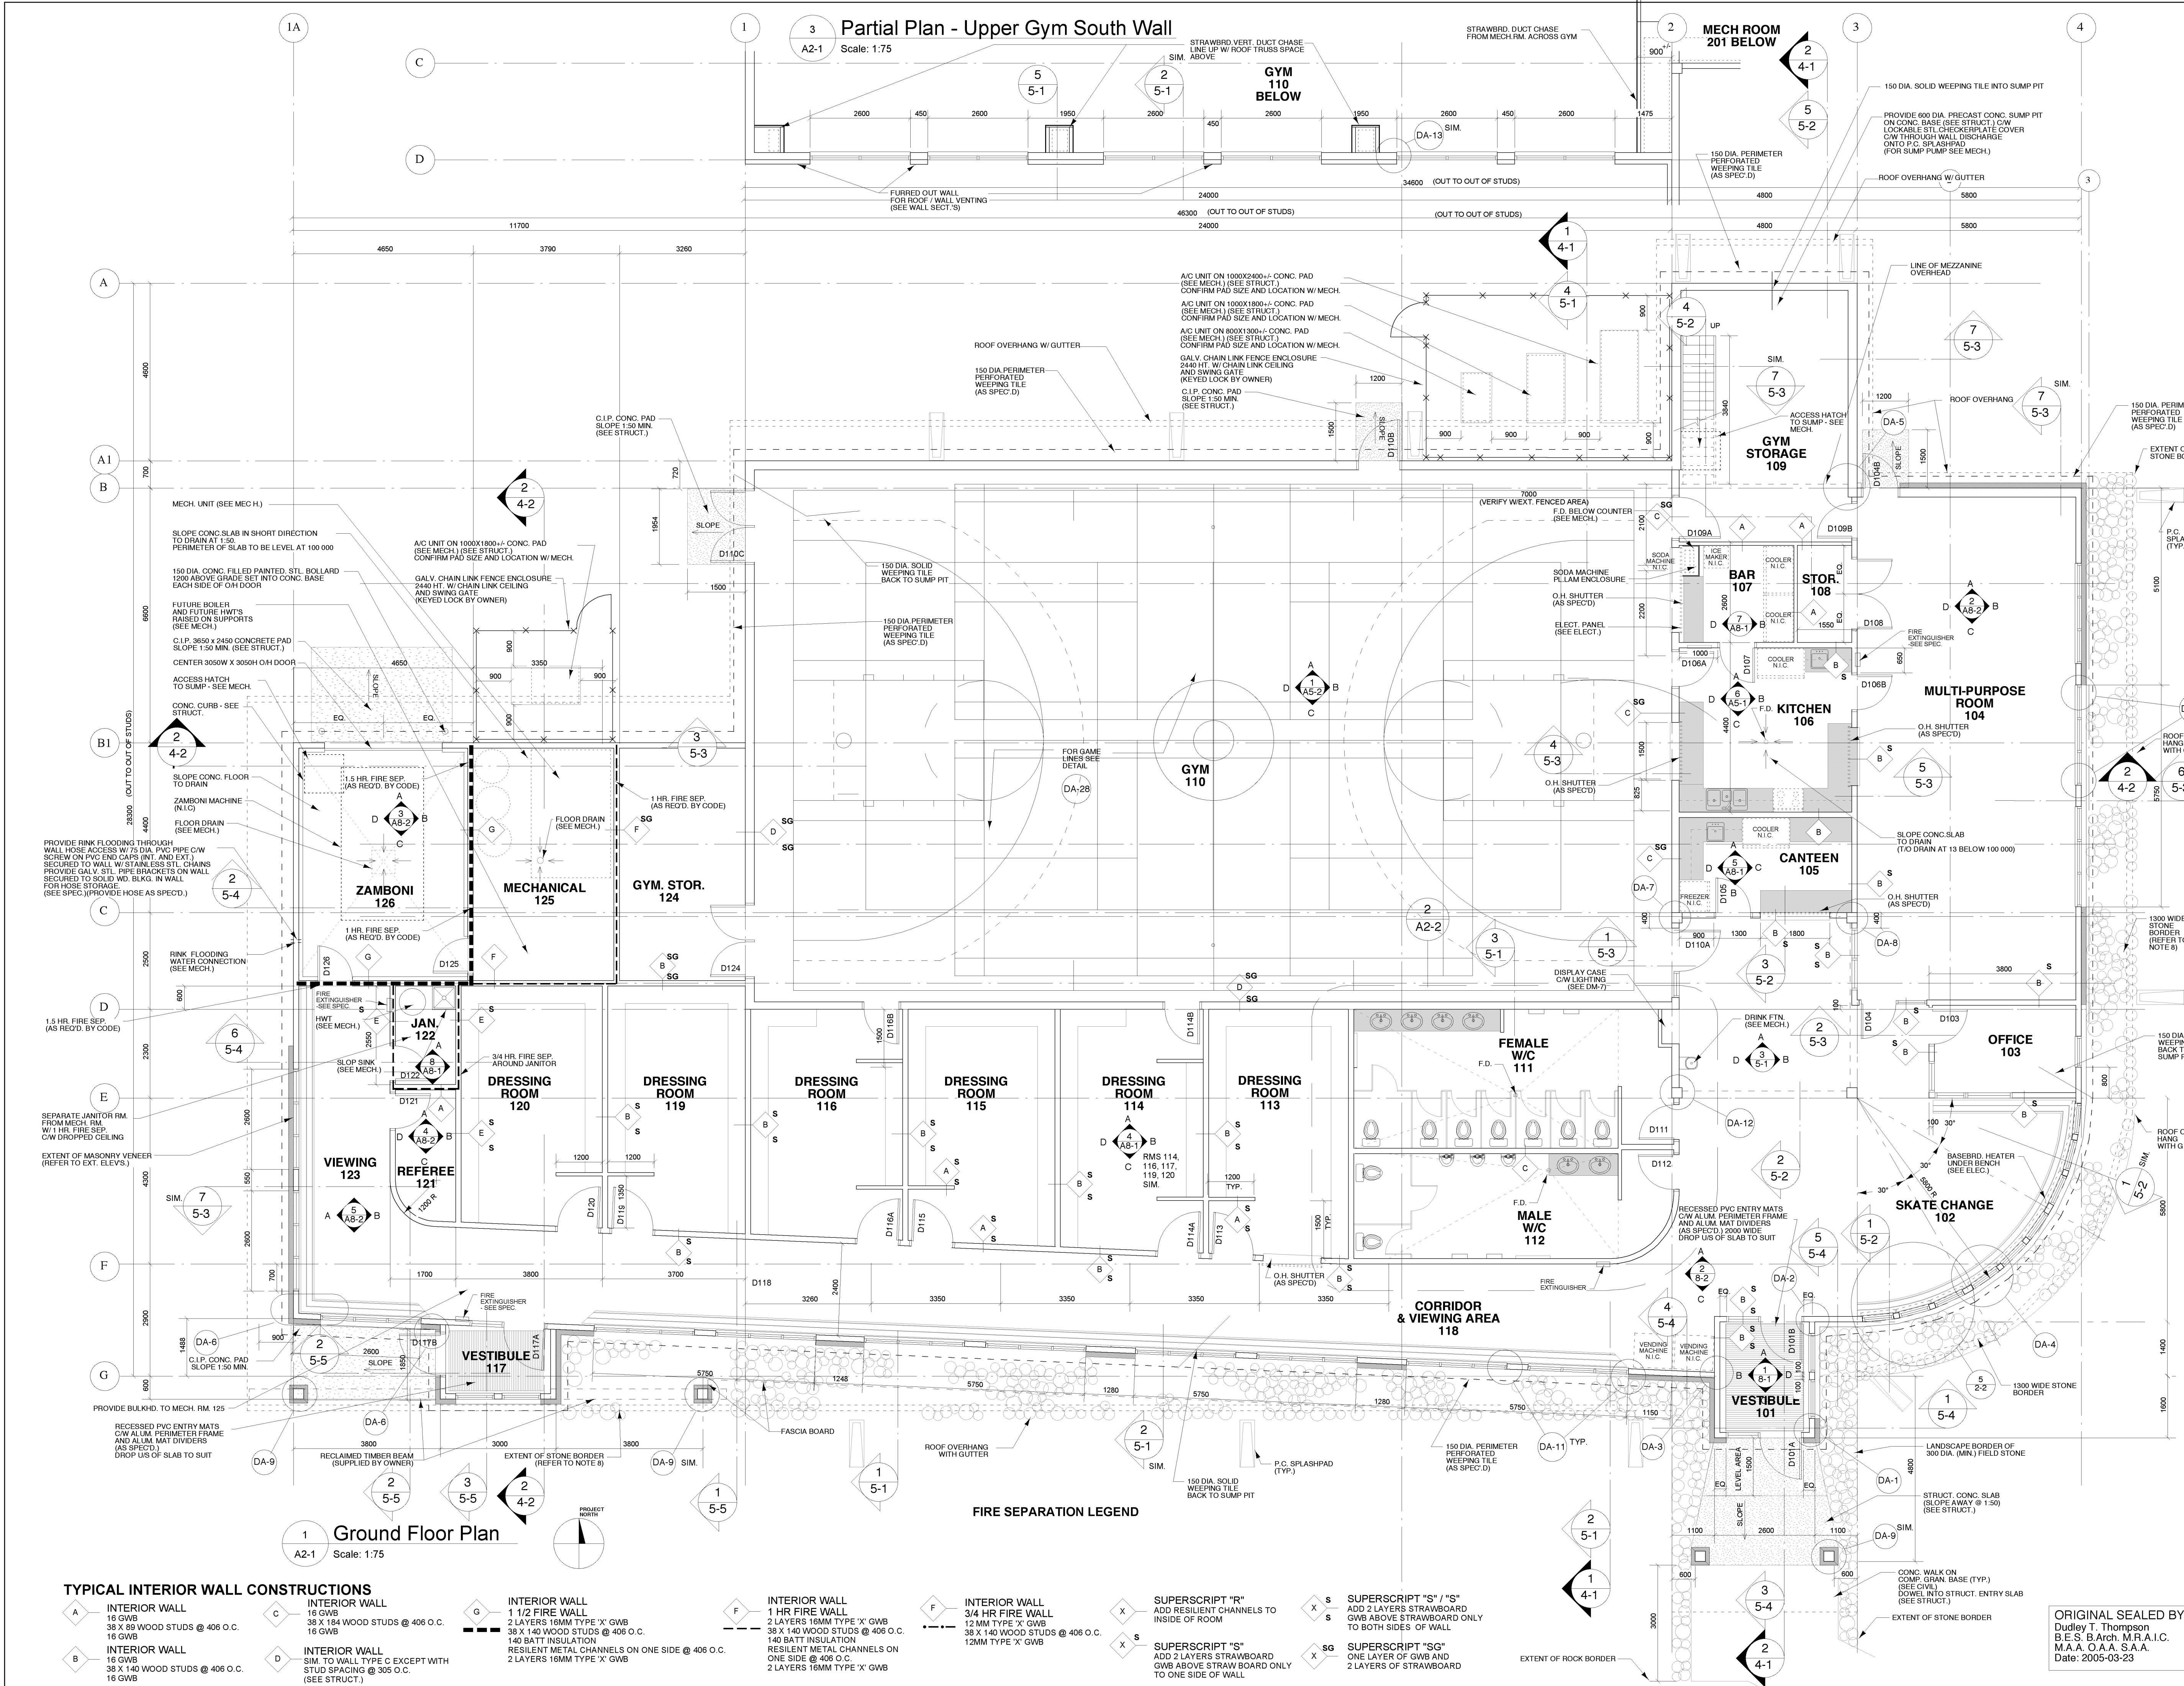

1 Ground Floor Plan  
 Scale: 1:75

**TYPICAL INTERIOR WALL CONSTRUCTIONS**

<b>A</b> INTERIOR WALL 16 GWB 38 X 89 WOOD STUDS @ 406 O.C. 16 GWB	<b>C</b> INTERIOR WALL 16 GWB 38 X 184 WOOD STUDS @ 406 O.C.	<b>G</b> INTERIOR WALL 1 1/2 FIRE WALL 2 LAYERS 16MM TYPE 'X' GWB 38 X 140 WOOD STUDS @ 406 O.C. 140 BATT INSULATION RESILIENT METAL CHANNELS ON ONE SIDE @ 406 O.C.
<b>B</b> INTERIOR WALL 16 GWB 38 X 140 WOOD STUDS @ 406 O.C. 16 GWB	<b>D</b> INTERIOR WALL SIM. TO WALL TYPE C EXCEPT WITH STUD SPACING @ 305 O.C. (SEE STRUCT.)	<b>F</b> INTERIOR WALL 1 1/2 FIRE WALL 3/4 HR FIRE WALL 12MM TYPE 'X' GWB 38 X 140 WOOD STUDS @ 406 O.C. 12MM TYPE 'X' GWB

<b>F</b> INTERIOR WALL 1 1/2 FIRE WALL 2 LAYERS 16MM TYPE 'X' GWB 38 X 140 WOOD STUDS @ 406 O.C. 140 BATT INSULATION RESILIENT METAL CHANNELS ON ONE SIDE @ 406 O.C.	<b>X</b> SUPERSCRIPIT "R" ADD RESILIENT CHANNELS TO INSIDE OF ROOM	<b>X</b> SUPERSCRIPIT "S" / "S" ADD 2 LAYERS STRAWBOARD GWB ABOVE STRAWBOARD ONLY TO BOTH SIDES OF WALL
<b>F</b> INTERIOR WALL 1 1/2 FIRE WALL 3/4 HR FIRE WALL 12MM TYPE 'X' GWB 38 X 140 WOOD STUDS @ 406 O.C. 12MM TYPE 'X' GWB	<b>X</b> SUPERSCRIPIT "S" ADD 2 LAYERS STRAWBOARD GWB ABOVE STRAWBOARD ONLY TO ONE SIDE OF WALL	<b>X</b> SUPERSCRIPIT "SG" ONE LAYER OF GWB AND 2 LAYERS OF STRAWBOARD

**FIRE SEPARATION LEGEND**

<b>F</b> INTERIOR WALL 1 1/2 FIRE WALL 3/4 HR FIRE WALL 12MM TYPE 'X' GWB 38 X 140 WOOD STUDS @ 406 O.C. 12MM TYPE 'X' GWB	<b>X</b> SUPERSCRIPIT "R" ADD RESILIENT CHANNELS TO INSIDE OF ROOM	<b>X</b> SUPERSCRIPIT "S" / "S" ADD 2 LAYERS STRAWBOARD GWB ABOVE STRAWBOARD ONLY TO BOTH SIDES OF WALL
<b>F</b> INTERIOR WALL 1 1/2 FIRE WALL 3/4 HR FIRE WALL 12MM TYPE 'X' GWB 38 X 140 WOOD STUDS @ 406 O.C. 12MM TYPE 'X' GWB	<b>X</b> SUPERSCRIPIT "S" ADD 2 LAYERS STRAWBOARD GWB ABOVE STRAWBOARD ONLY TO ONE SIDE OF WALL	<b>X</b> SUPERSCRIPIT "SG" ONE LAYER OF GWB AND 2 LAYERS OF STRAWBOARD