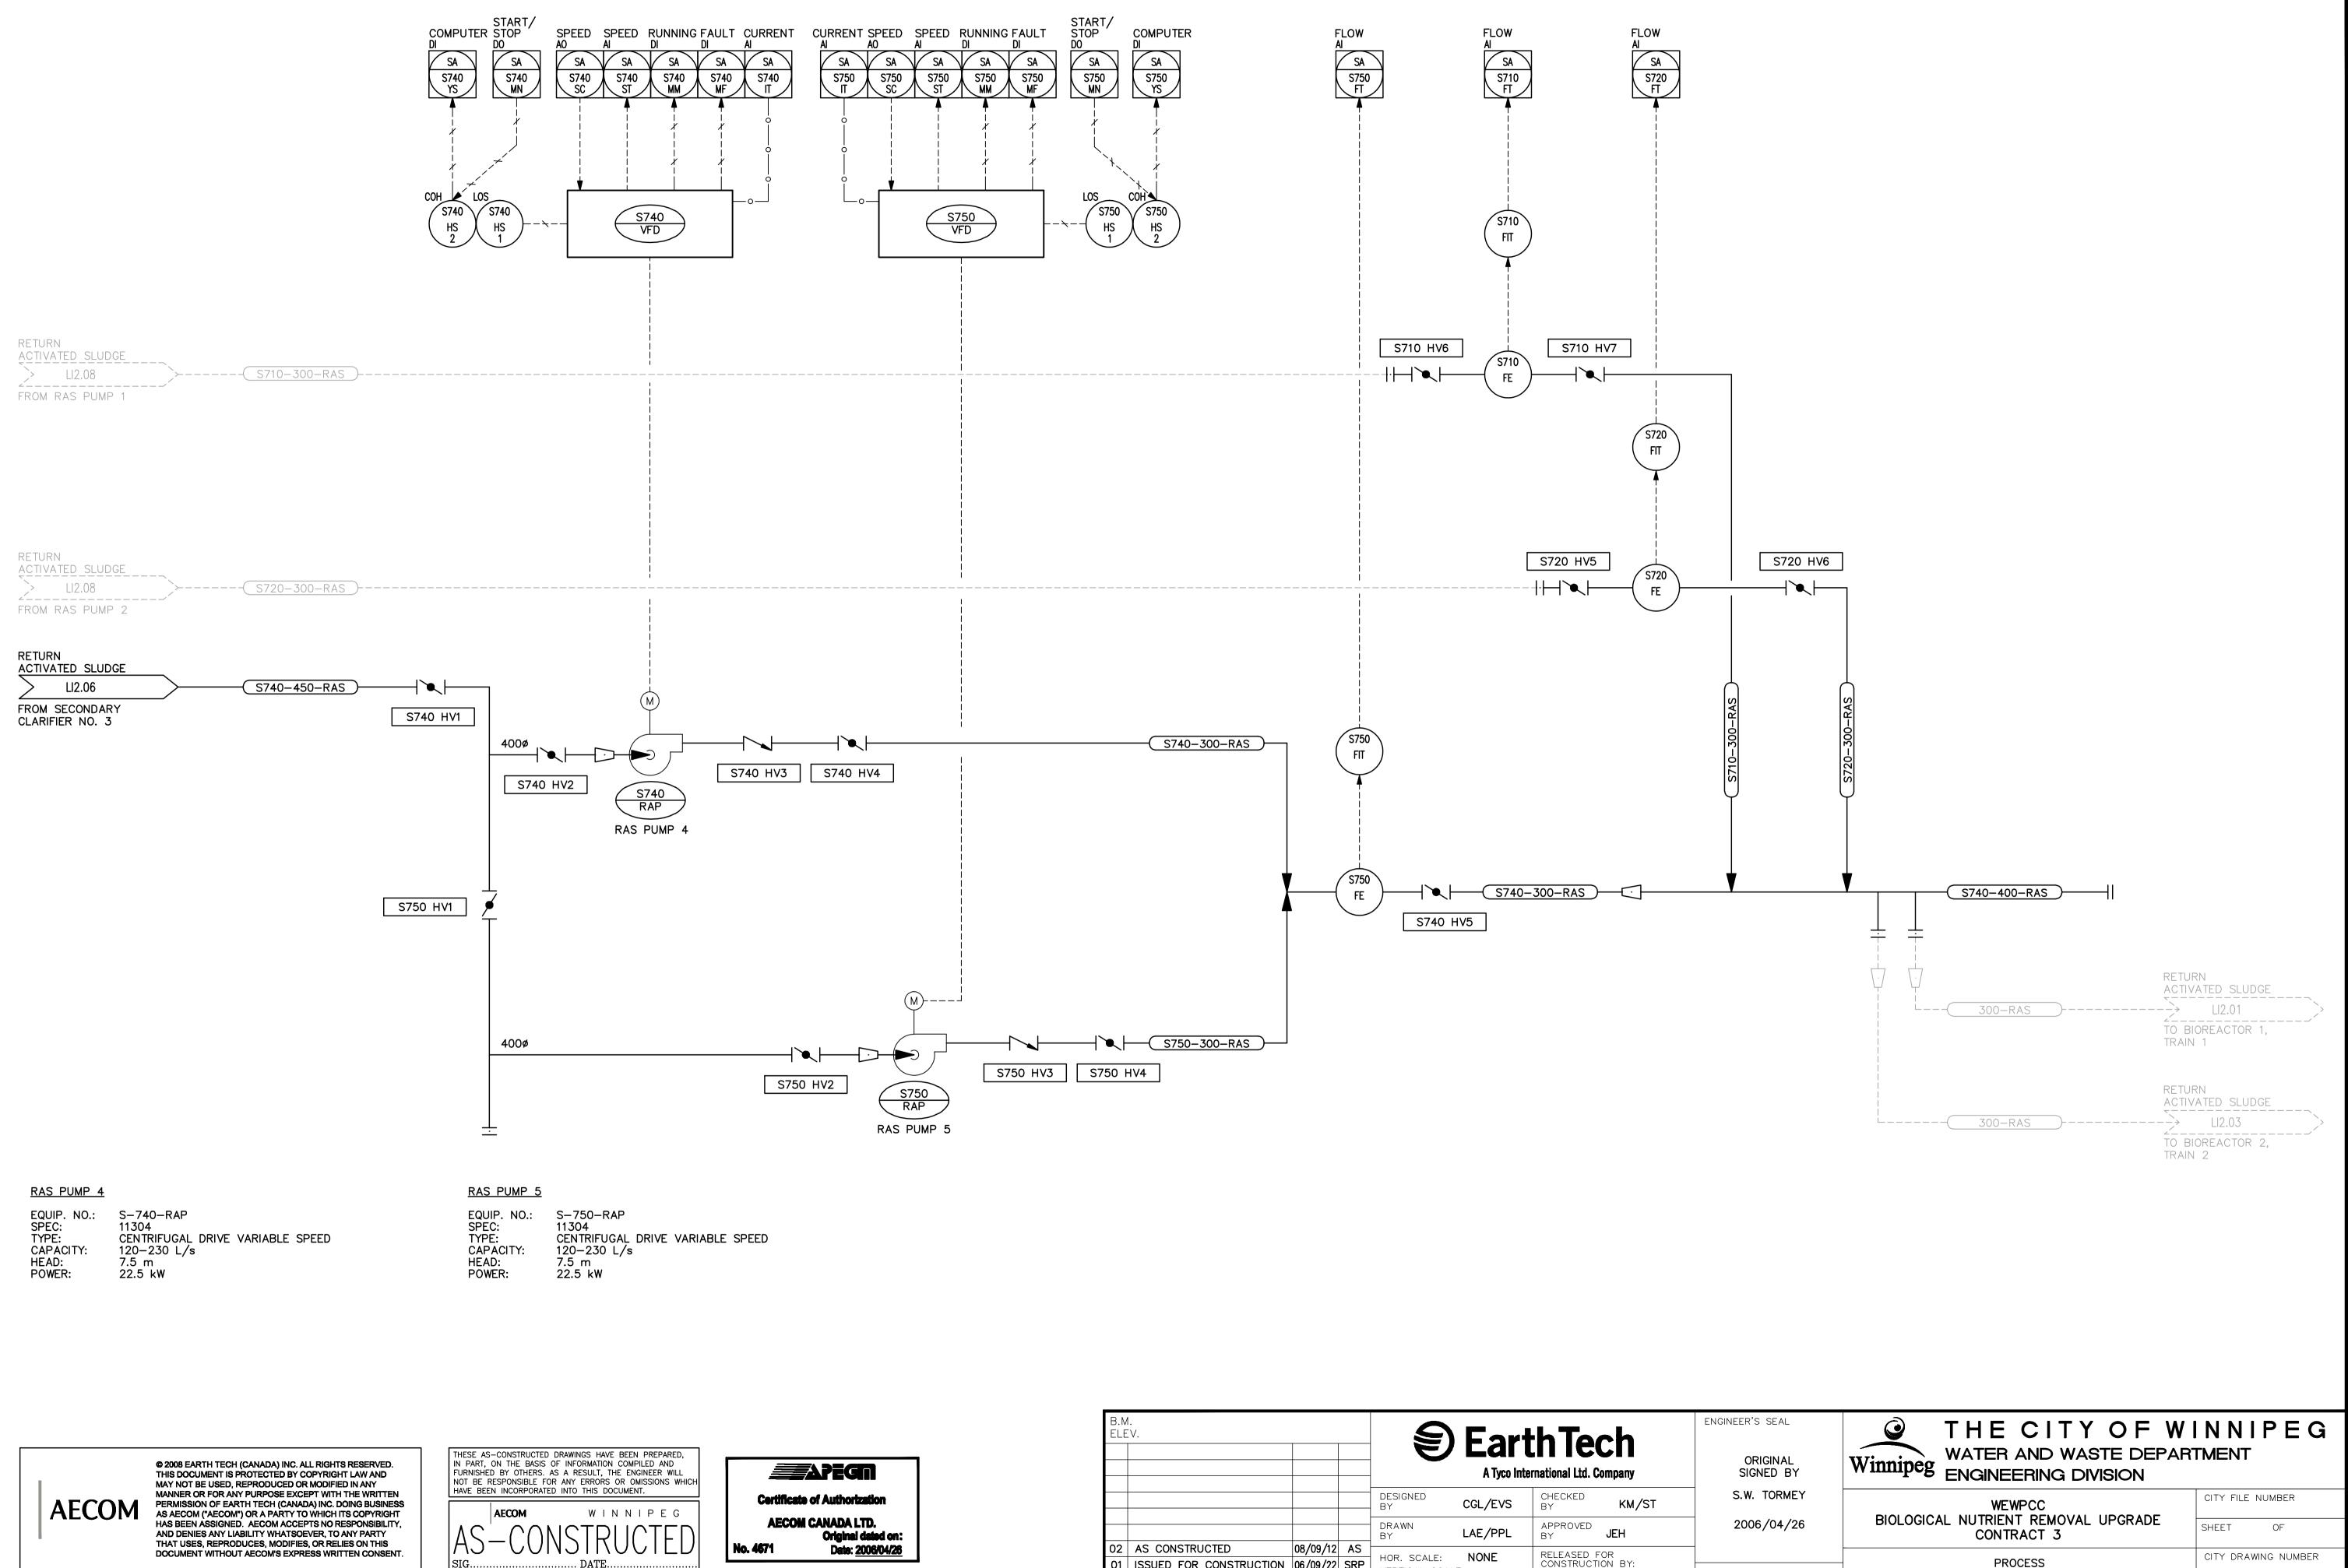
APPENDIX M – P & ID DRAWINGS

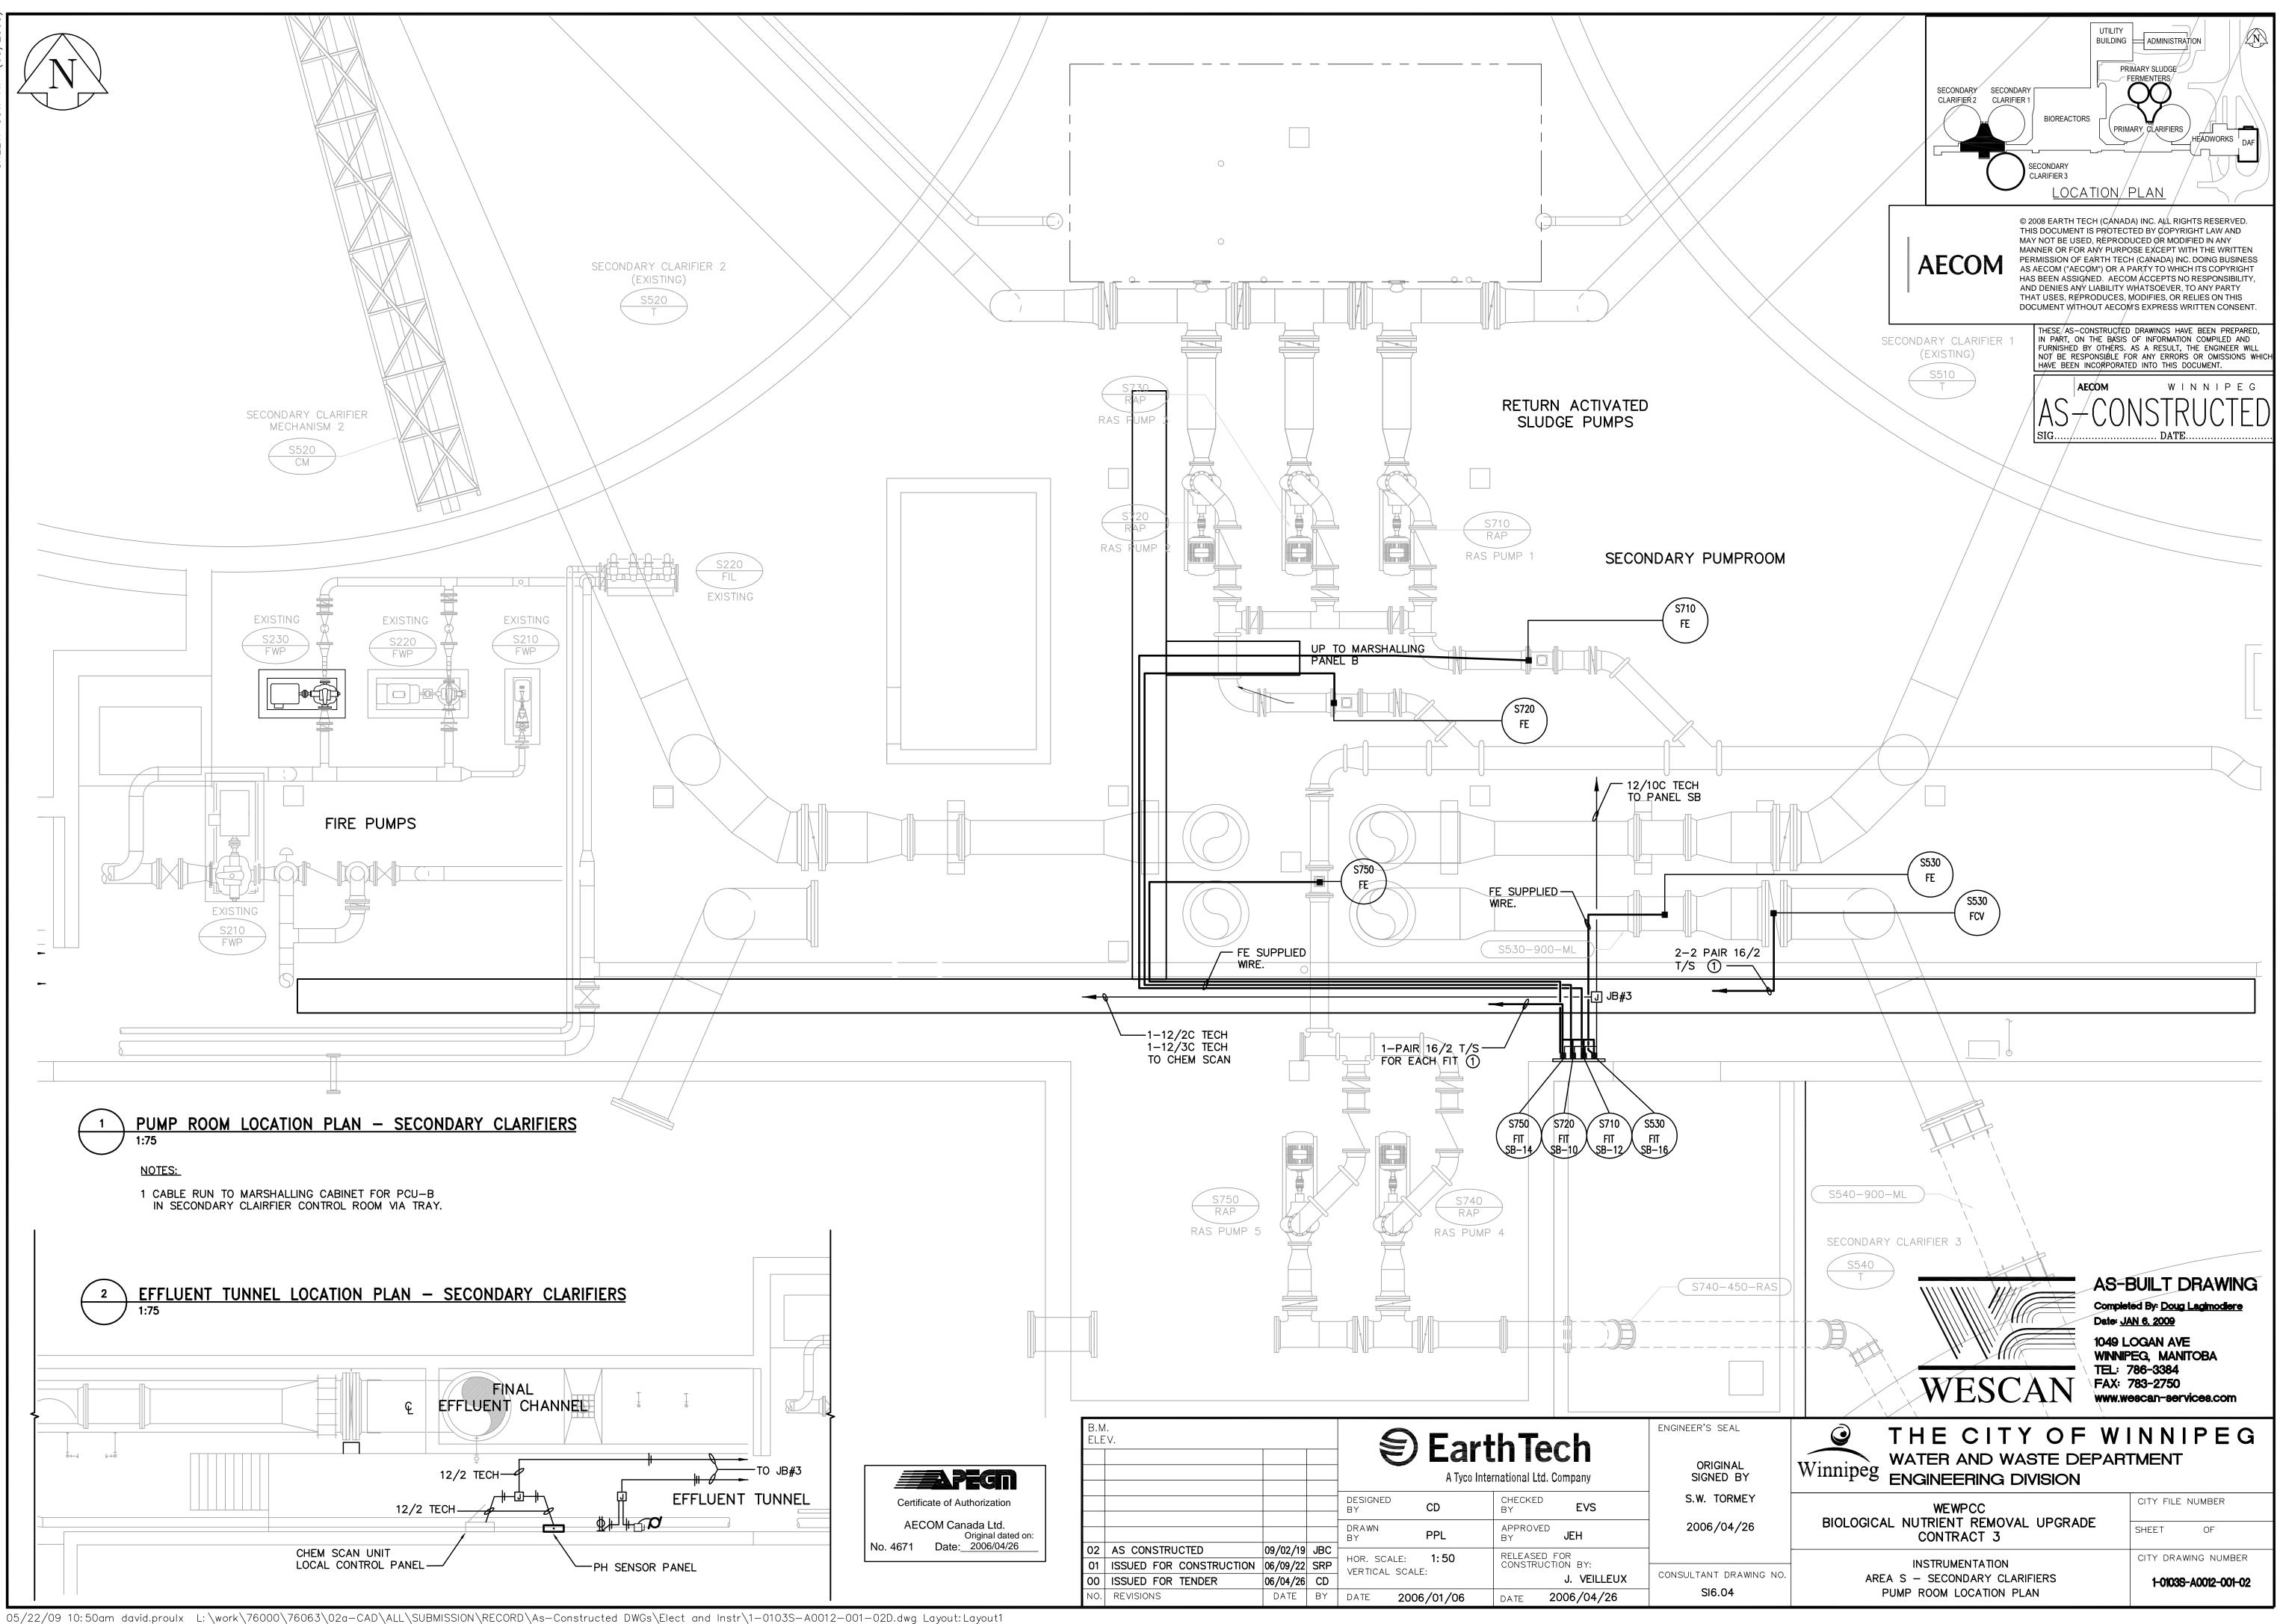
ITEM NO.	DRAWING NO.	DRAWING TITLE
1	1-0103S-A0005-001-02	Process Area S – Secondary Clarifier 3, Return Activated Sludge Pumping – P&ID
2	1-0103S-A0012-001-02	Instrumentation Area S – Secondary Clarifiers, Pump Room Location Plan
3	WEP-69	Process Piping Legend & Abbreviations
4	WEP-70	Service Piping Process Diagram
5	WEP-76	Mechanical Legend & Abbreviations
6	WEP-91	Process and Instrumentation Diagram No. 9 – Aeration/Blowers
7	WEP-92	Process and Instrumentation Diagram No. 10 – Secondary Clarifiers
8	WEP-93	Process and Instrumentation Diagram No. 11 – Final Effluent & Flushing Water Systems



03/13/09 11:22am gerardo.gilana L: \work\76000\76063\02a-CAD\ALL\SUBMISSION\RECORD\As-Constructed DWGs\Process and Mech\1-0103S-A0005-001-02D.dwg Layout: 1-0103S-A0005-001-02

B.M ELE				Ð	Earl			ENGINEER'S SEAL
					A lyco inte	rnational Ltd.	Company	SIGNED BY
				DESIGNED BY	CGL/EVS	CHECKED BY	KM/ST	S.W. TORMEY
				DRAWN BY	LAE/PPL	APPROVED BY	JEH	2006/04/26
02	AS CONSTRUCTED	08/09/12	AS		NONE	RELEASED	FOR	-
01	ISSUED FOR CONSTRUCTION	06/09/22	SRP	HOR. SCALE: VERTICAL SCAL		CONSTRUC		
00	ISSUED FOR TENDER	06/04/26	CD				J. VEILLEUX	CONSULTANT DRAWIN
NO.	REVISIONS	DATE	ΒY	DATE 200	5/07/06	DATE	2006/04/26	LI2.07

	Winnipeg THE CITY OF W WATER AND WASTE DEPAR ENGINEERING DIVISION	
	WEWPCC BIOLOGICAL NUTRIENT REMOVAL UPGRADE CONTRACT 3	CITY FILE NUMBER
NO.	PROCESS AREA S – SECONDARY CLARIFIER 3 RETURN ACTIVATED SLUDGE PUMPING – P&ID	CITY DRAWING NUMBER 1-01038-A0005-001-02



PIPE LEGEND

PIPE FITTING	FLANGED	SCREWED	VICTAULIC	WELDED
90ø ELBOW	\mathcal{P}	+	\sum	5
45ø ELBOW	\triangleright	+x	Þ	
TEE	Г	ıT-ı		്ര
LATERAL	凶	Ц	公	公
ELBOW TURNED DOWN	Ċ	Э		Œ
ELBOW TURNED UP	©7	СH	Ø	Ø]
ELBOW SIDE OUTLET DOWN		PH		
ELBOW SIDE OUTLET UP		9 1		Ø
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REDUCER ECCENTRIC	Ħ	-D	þ	D
EXPANSION JOINT	M			
FLANGE		þ		þ
UNION				
CAP	þ	E	∎⊐	
ORFICE				Ц

VALVE LEGEND

VALVE	FLANGED	SCREWED
GATE		\bowtie
BALL		þ
PLUG		\Diamond
GLOBE		X
NEEDLE		₩ N
CHECK		14
WAFER GATE	И	
BUTTERFLY	И	
KNIFE GATE	\bowtie	
PRESSURE RED		Xv
CONTROL		

WEWPC-1 PPL-A1

NOTE:

PROCESS PIPING 65mm DIAMETER AND SMALLER IS SHOWN SINGLE LINE. PROCESS PIPING LARGER THAN 65mm

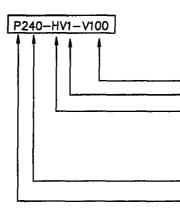
DIAMETER IS SHOWN DOUBLE LINE.

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REID,	CROWTHER & PARTNERS LIMITED WINNIPEG
AS	CONSTRUCTED
SIG. AL	DATE NOV. 29 94

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				L			

AREA M	-PERIMETER R
AREA H	-HEADWORKS
AREA P	-PRIMARY CLA
AREA S	-SECONDARY F
AREA U	-UTILITY AND
AREA L	-GENERAL SITE

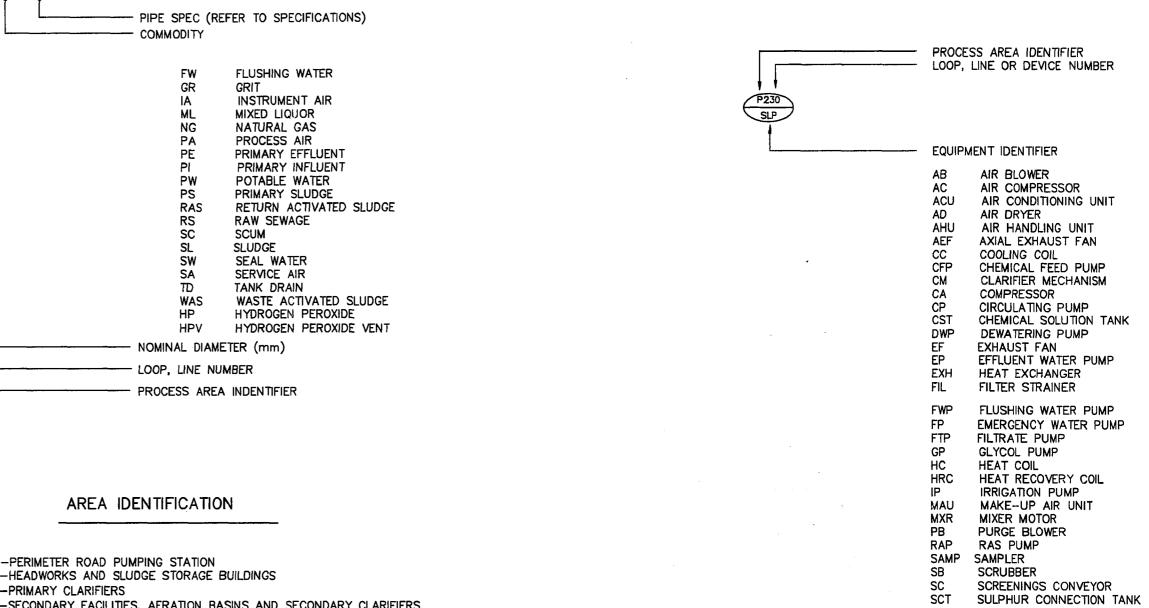


P210-SL1

B.M	
ELE	
1	A
0	IS
NQ.	R

PIPE IDENTIFICATION

EQUIPMENT IDENTIFICATION



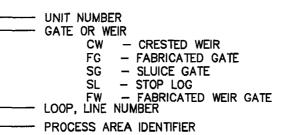
FACILITIES, AERATION BASINS AND SECONDARY CLARIFIERS ADMINISTRATION BUILDINGS E DEVELOPMENT AREA

VALVE IDENTIFICATION

	ON P & ID SHEETS	ONLY; REFER TO SPECIFICATION	IS)
 UNIT NUMBER			
 VALVE FUNCTION			
HV – HAND	OPERATED ISOLATIO	N VALVE OR CHECK VALVE	

- LOOP, LINE OR DEVICE NUMBER - PROCESS AREA IDENTIFIER

GATE AND WEIR IDENTIFICATION



SLP

SMP

SP

SST

STP

TD

WP

WAP

UPS

HPP

HTK

DRAIN POINT

ABBREVIATIONS

PRIMARY SLUDGE PUMP

SLUDGE STORAGE TANK

SLUDGE TRANSFER PUMP

HYDROGEN PEROXIDE PUMP

UNINTERRRUPTIBLE POWER SUPPLY

HYDROGEN PEROXIDE STORAGE TANK

SUMP PUMP

TRUCK DOOR

WAS PUMP

HOT WATER PUMP

SCUM PUMP

DR FC FP FLEXIBLE COUPLING (DRESSER STYLE)

- FLUSHING POINT
- GC SP GROOVED COUPLING (VICTAULIC STYLE) SAMPLE POINT
- FE FLOW ELEMENT
- AVERAGE DRY WEATHER FLOW PEAK DRY WEATHER FLOW ADWF PDWF
- PWWF PEAK WET WEATHER FLOW
- PS PIPE SUPPORT

CONTROL VALVE IDENTIFICATION

PROCESS AREA IDENTIFIER LOOP, LINE OR DEVICE NUMBER

VALVE FUNCTION

- FCV FLOW CONTROL VALVE
- PCV PROCESS CONTROL VALVE TCV - TEMPERATURE CONTROL VALVE

69-006 237.636 m Reid Crowther ENGINEER'S SEAL THE CITY OF WINNIPEG WORKS AND OPERATIONS DIVISION the second s WATERWOMKS WASTE AND DISPOSAL DEPT. Ϋ́, Ċ. CHECKED BY DESIGNED CITY DRAWING NUMBER LEONG(WEST END WATER POLLUTION PAL BY CONTROL CENTRE DRAWN APPROVED 630 SHEET OF SC/GGB ΒY ΒY AREA L - GENERAL AND SITEWORKS PROFESSIO RELEASED FOR CONSTRUCTION: HOR. SCALE: N.T.S. S CONSTRUCTED 94,09,26 DJT VERTICAL: PROCESS PIPING LEGEND & CONSULTANT DRAWING NO. SSUED FOR TENDER 91,06,17 PAL WEP-69ABBREVIATIONS 60910 - LP2 EVISIONS DATE BY DATE 94-09-13 DATE

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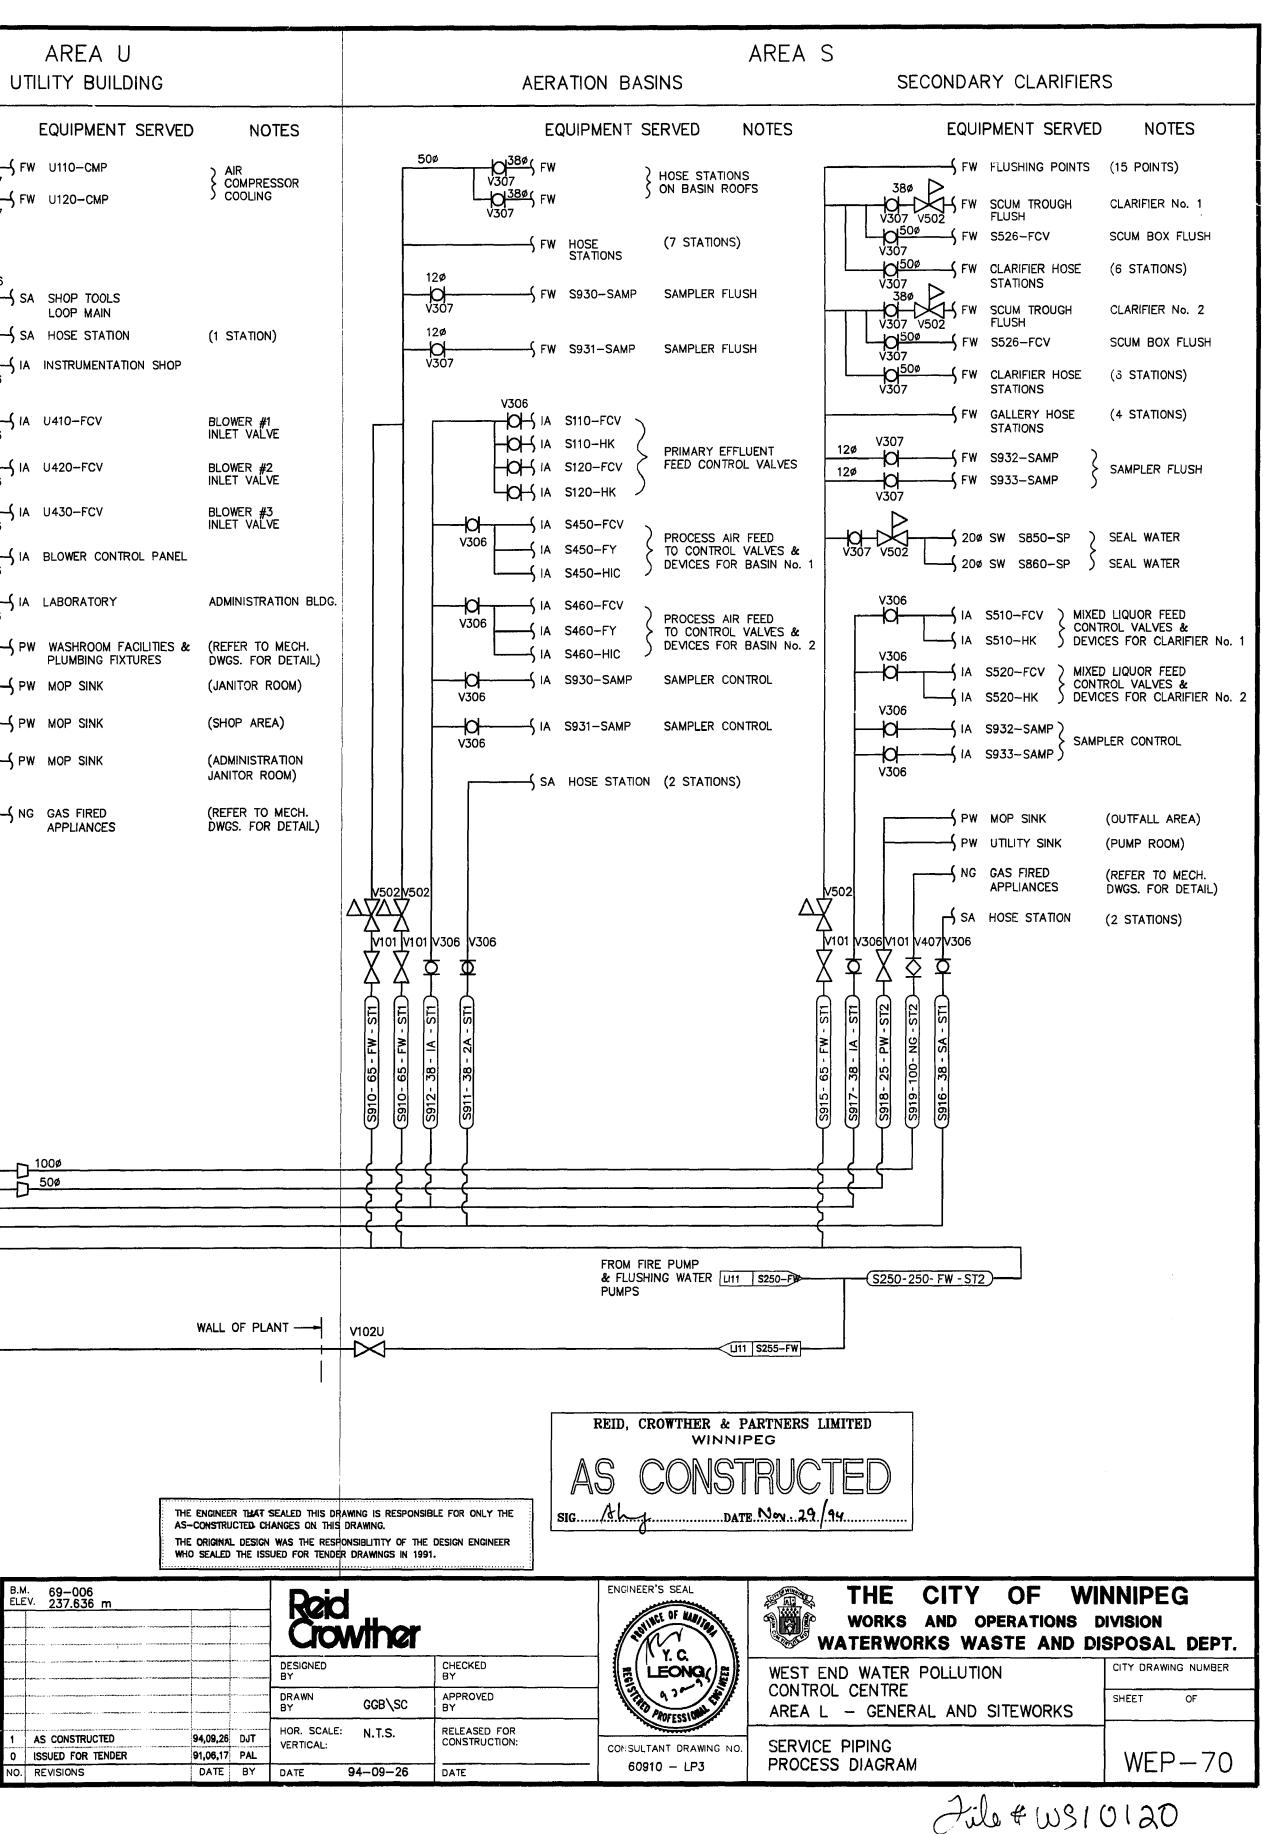
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Hile # WS10119



AREA H HEADWORKS & SLUDGE STORAGE	AREA P PRIMARY CLARIFIERS	UT
EQUIPMENT SERVED NOTES	PRIMARY CLARIFIERS EQUIPMENT SERVED NOTES FW FLUSHING POINTS (12 POINTS) FW FLUSH CLARIFIER No. 1 FUSH FW SCUM TROUGH CLARIFIER No. 1 FUSH FW P313-FCV SCUM BOX FLUSH V307 FW CLARIFIERS (6 STATIONS) V307 FW SCUM TROUGH CLARIFIER No. 2 FLUSH SCUM TROUGH CLARIFIER No. 2 V307 FW SCUM TROUGH CLARIFIER No. 2 FLUSH SCUM TROUGH CLARIFIER No. 2 FUSH FW 9323-FCV SCUM BOX FLUSH V307 V502 FW P323-FCV SCUM BOX FLUSH V307 FW GALLERY HOSE (6 STATIONS) STATIONS STATIONS SEAL WATER S00 [#] 20 [#] SW P310-SP SEAL WATER V307 V502 20 [#] SW P320-SP SEAL WATER S0 [#] 32 [#] SA P230-SLP PRIMARY SLUDGE PUMPS SUDGE SA HOSE STATION	$ \begin{array}{c ccccccccccccccccccccccccccccccccccc$
$ \begin{array}{c ccccccccccccccccccccccccccccccccccc$	V502 V101 V306 V101 V407 V306 FUTURE LIS - KIS -	V502 V502 V101 V306 V306 V101 V407 V101 V306 V306 V101 V407
V102U 	PLANT FIRE LOOP	
DRAWING. PROVIDE ALL PIPING, FITTINGS, VALVING, ETC	T1 T2 T2 PIPING. TER IR S TER IR S	- Transfer

5	VALVES ON	THE	SERVICE	PIPING	SYSTEM	SHALL	BE	LOCATED	IN	THE	FIELD.
υ.	AVEATO OU	1176	OFILLIOF	1.0.040	010100						



<u>LEGEND</u>

SANITARY DRAIN BELOW SLAB	
SANITARY DRAIN ABOVE SLAB	
ACID DRAIN	AD
DOMESTIC COLD WATER	
DOMESTIC HOT WATER	
DOMESTIC HOT WATER RECIRC.	
LABORATORY VACUUM	LV
LABORATORY WATER	LW
INSTRUMENT AIR	———— IA ————
ACID VENT	AV
VENT	- - V
HEATING GLYCOL SUPPLY	GLS
HEATING GLYCOL RETURN	GLR
NATURAL GAS	— — — NG — — —
BALL OR GATE VALVE	X
GLOBE VALVE	D#CI
PRESSURE REDUCING VALVE	×
BALANCING VALVE	ø
GAS COCK	₹
CHECK VALVE	7
REDUCED PRESSURE BACKFLOW PREVENTOR	X ZX
STRAINER	احرا
CLEAN OUT	C.O.I⊢—
FLUSH MOUNT CLEANOUT	C.O. 🕀—
FLOOR DRAIN	
FUNNEL FLOOR DRAIN	- FD2
RUNNING TRAP	
PUMP	۲
MOTORIZED DAMPER	M
	M F
BACKDRAFT DAMPER	(B)
BALANCING DAMPER	<u>e</u>
CONTROL SWITCH	©
THERMOSTAT	Ō
DIFFUSERS AND GRILLES	
DIFFUSERS AND GRILLES	SIZE CAPACITY
SUPPLY AIR	
RETURN AIR	
EXHAUST AIR	

WEWPC-1 PML-A1

EQUIPMENT IDENTIFICATION

P230 SLP

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 $r = N^{-1}$

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1.1

DEVICE NUMBER

PROCESS AREA IDENTIFIER

EQUIPMENT IDENTIFIER

ACU AIR CLEANING UNIT AIR HANDLING UNIT AHU AEF AXIAL EXHAUST FAN CIRCULATING PUMP CP CONDENSING UNIT CU CUH CABINET UNIT HEATER DOMESTIC HOT WATER HEATER DWH EXHAUST FAN EF EX EXPANSION TANK FORCED AIR FURNACE FAF HP HAND PUMP HPT HYDROPNEUMATIC TANK GH GLYCOL HEATER GP GLYCOL PUMP MUA MAKE-UP AIR UNIT PRESSURE BOOSTER PUMP PBP PWH PRESSURE WASH HEATER PWP POTABLE WATER PUMP PWT POTABLE WATER TANK SCU SMP UH SPOT COOLING UNIT SUMP PUMP UNIT HEATER

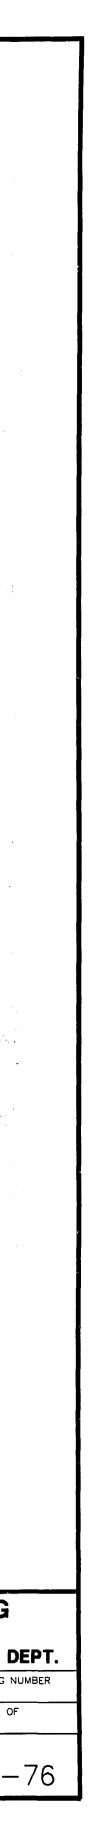
> REID, CROWTHER & PARTNERS LIMITED WINNIPEG CONSTRUCTED AS SIG Slag The DATE /TEC 2/99

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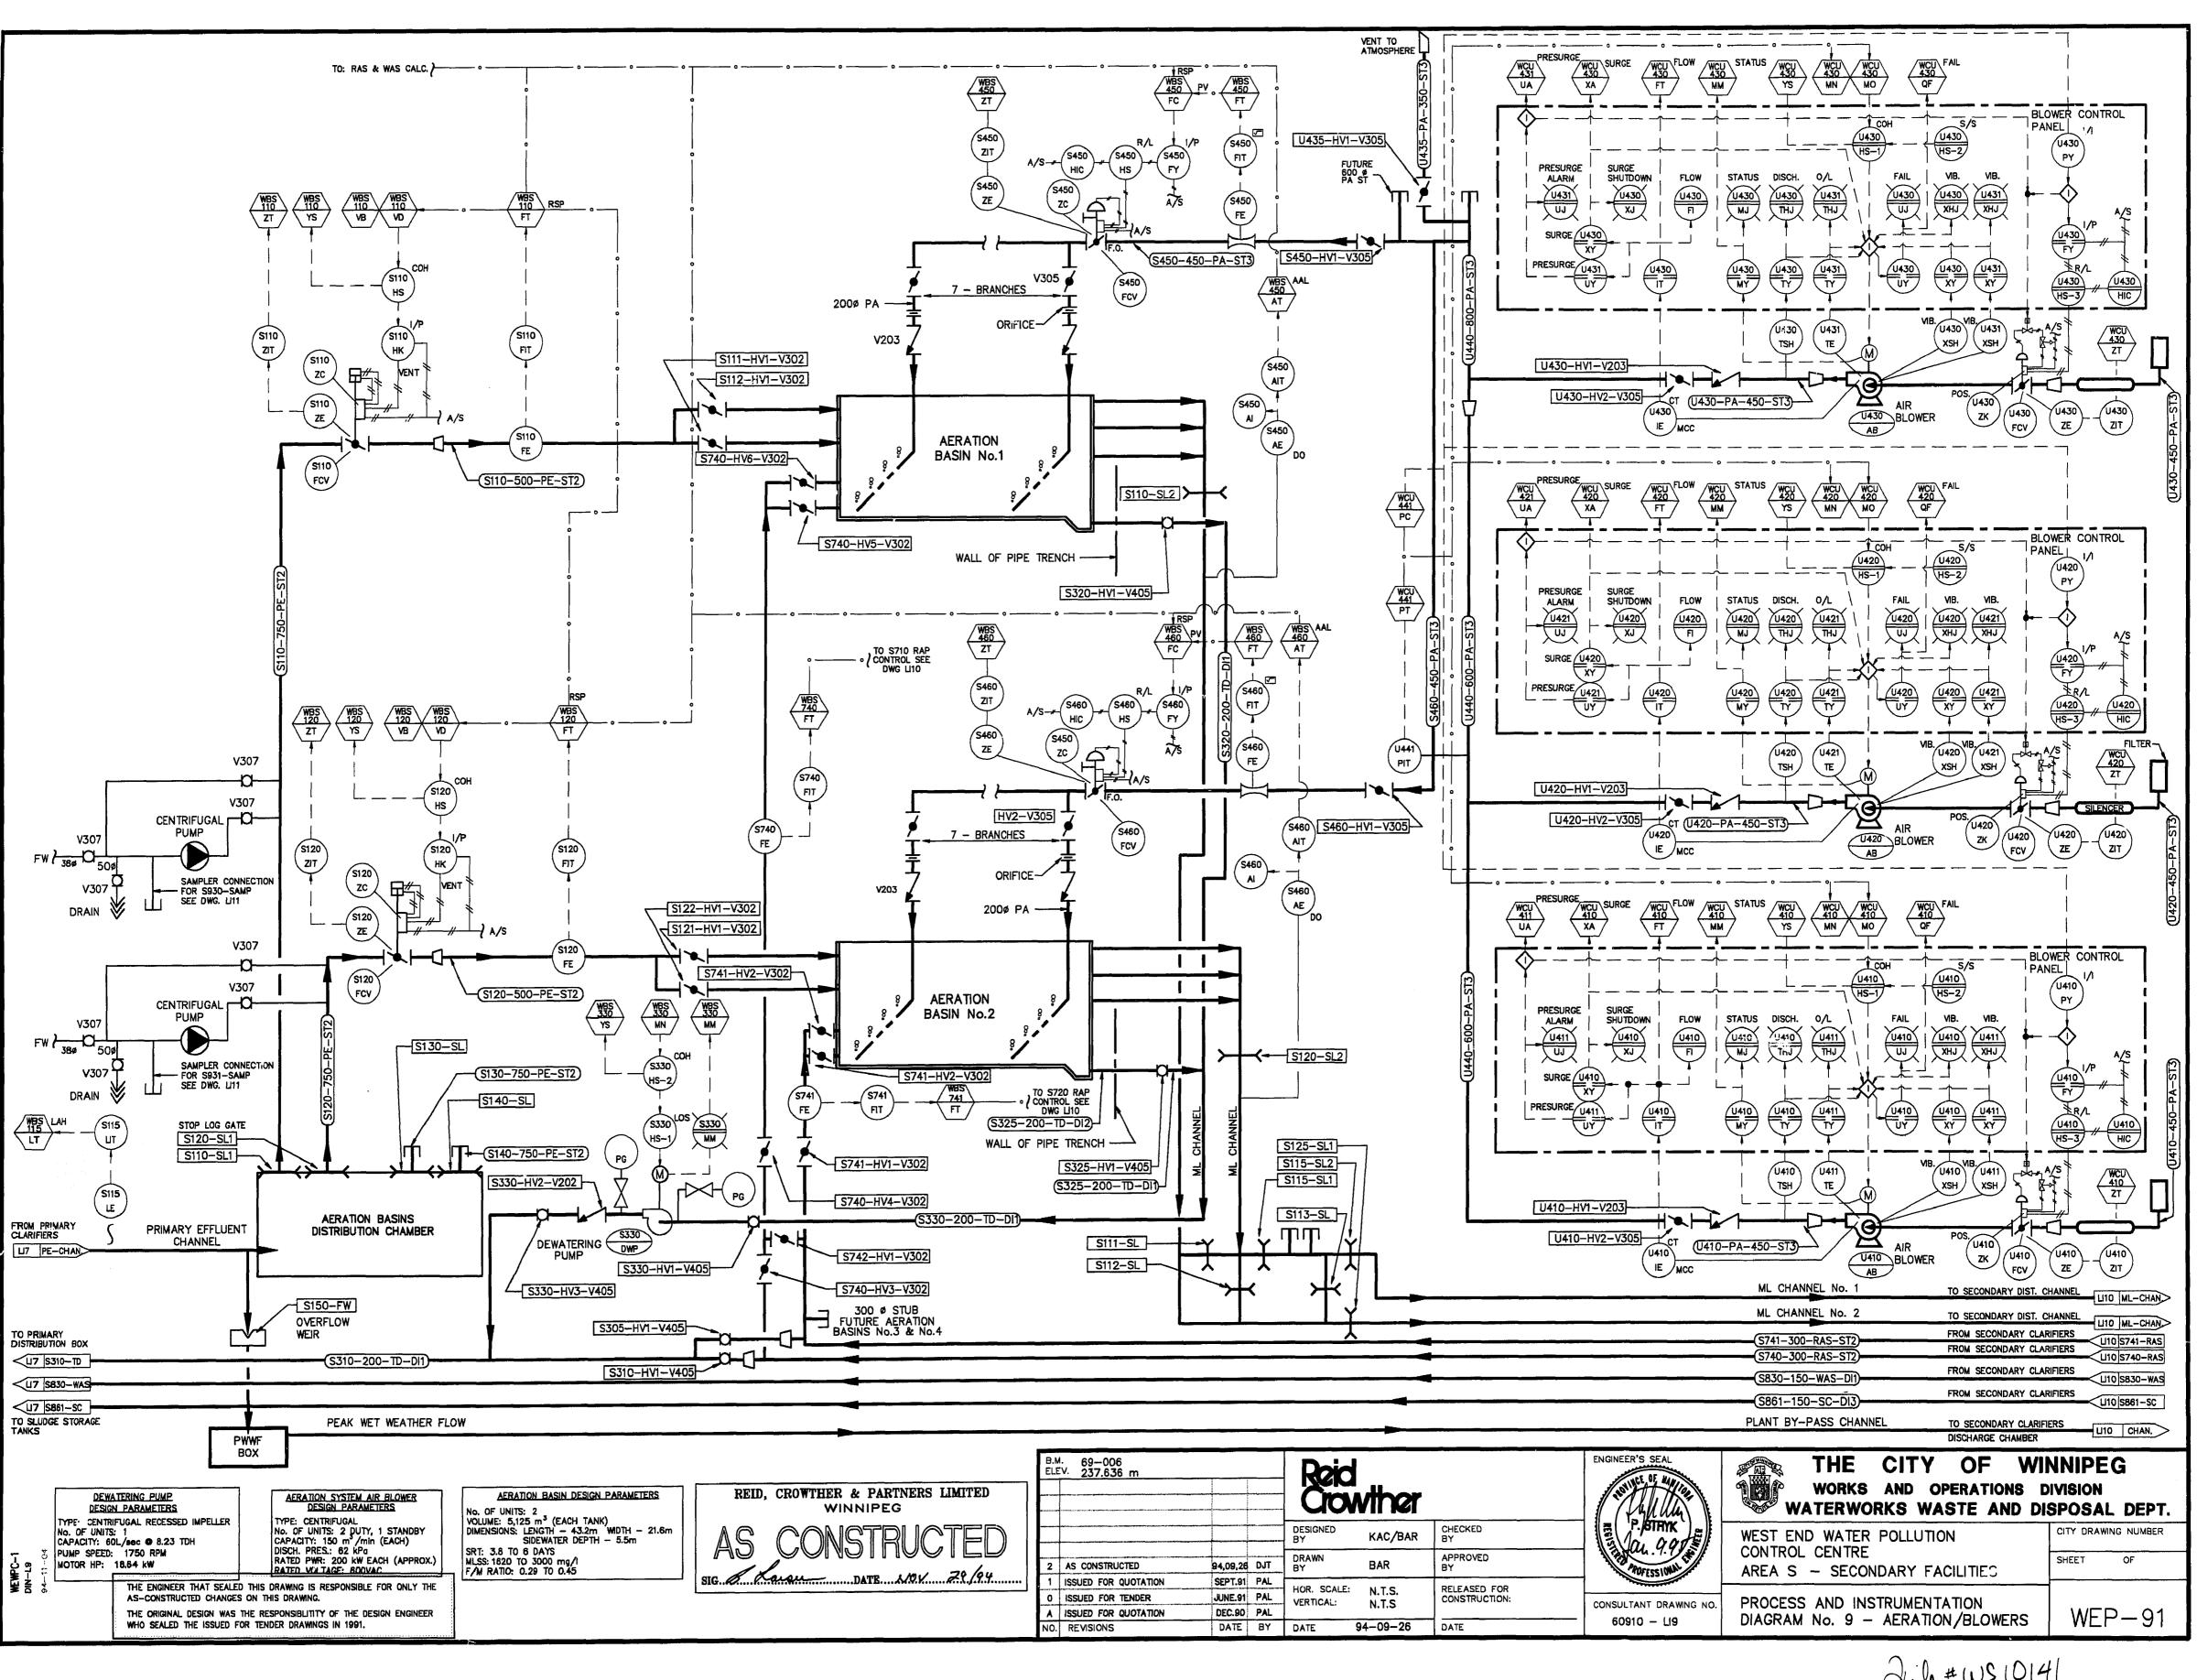
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B.M ELE	4. 69–006 EV. 237.636 m			Reid Crowther			ENGINEER'S SEAL	WORKS AND OPERATIONS DIVISION WATERWORKS WASTE AND DISPOSAL DE		
		n		DESIGNED BY DRAWN BY	· SR SR	CHECKED BY APPROVED BY	REABURN E	WEST END WATER POLLUTION CONTROL CENTRE AREA L - GENERAL AND SITEWORKS	CITY DRAWING NU	
1		94,09,26 91,06,17		HOR. SCALE		RELEASED FOR CONSTRUCTION:	CONSULTANT DRAWING NO. 60910 - LM1	MECHANICAL LEGEND & ABBREVIATIONS	 WEP-	
NO.	REVISIONS	DATE	BY	DATE	94-09-13	DATE			¥¥L	

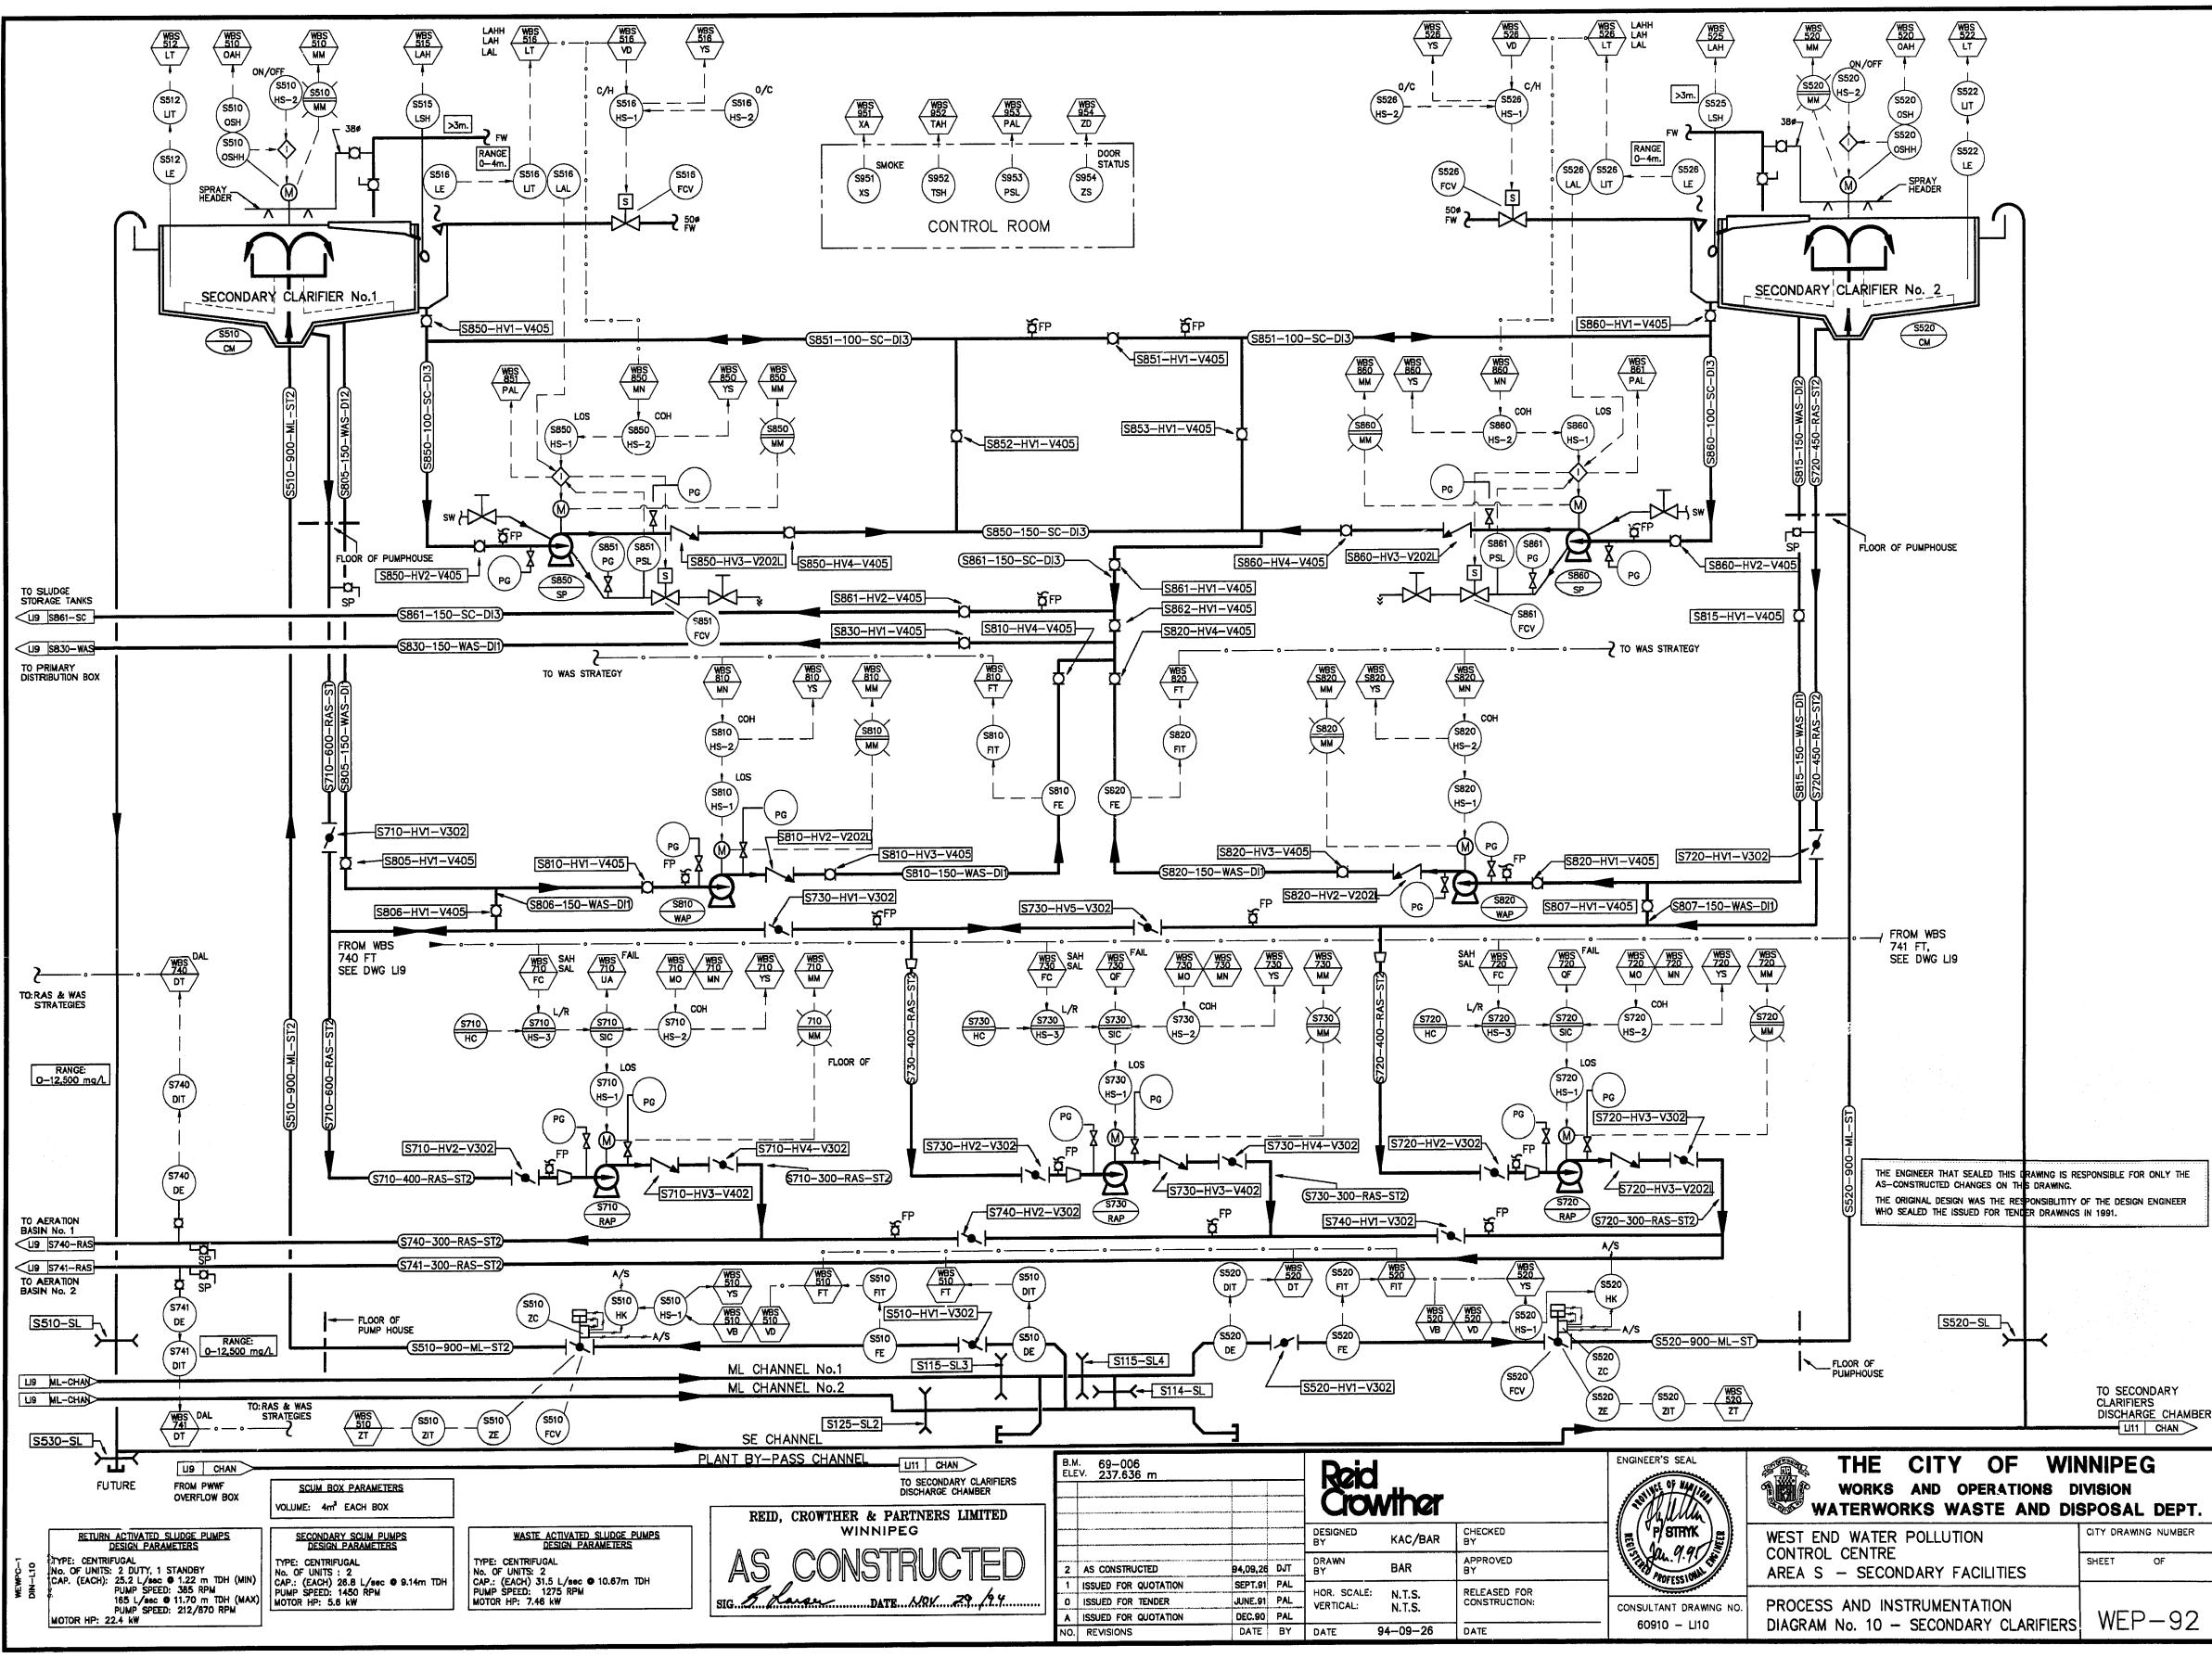
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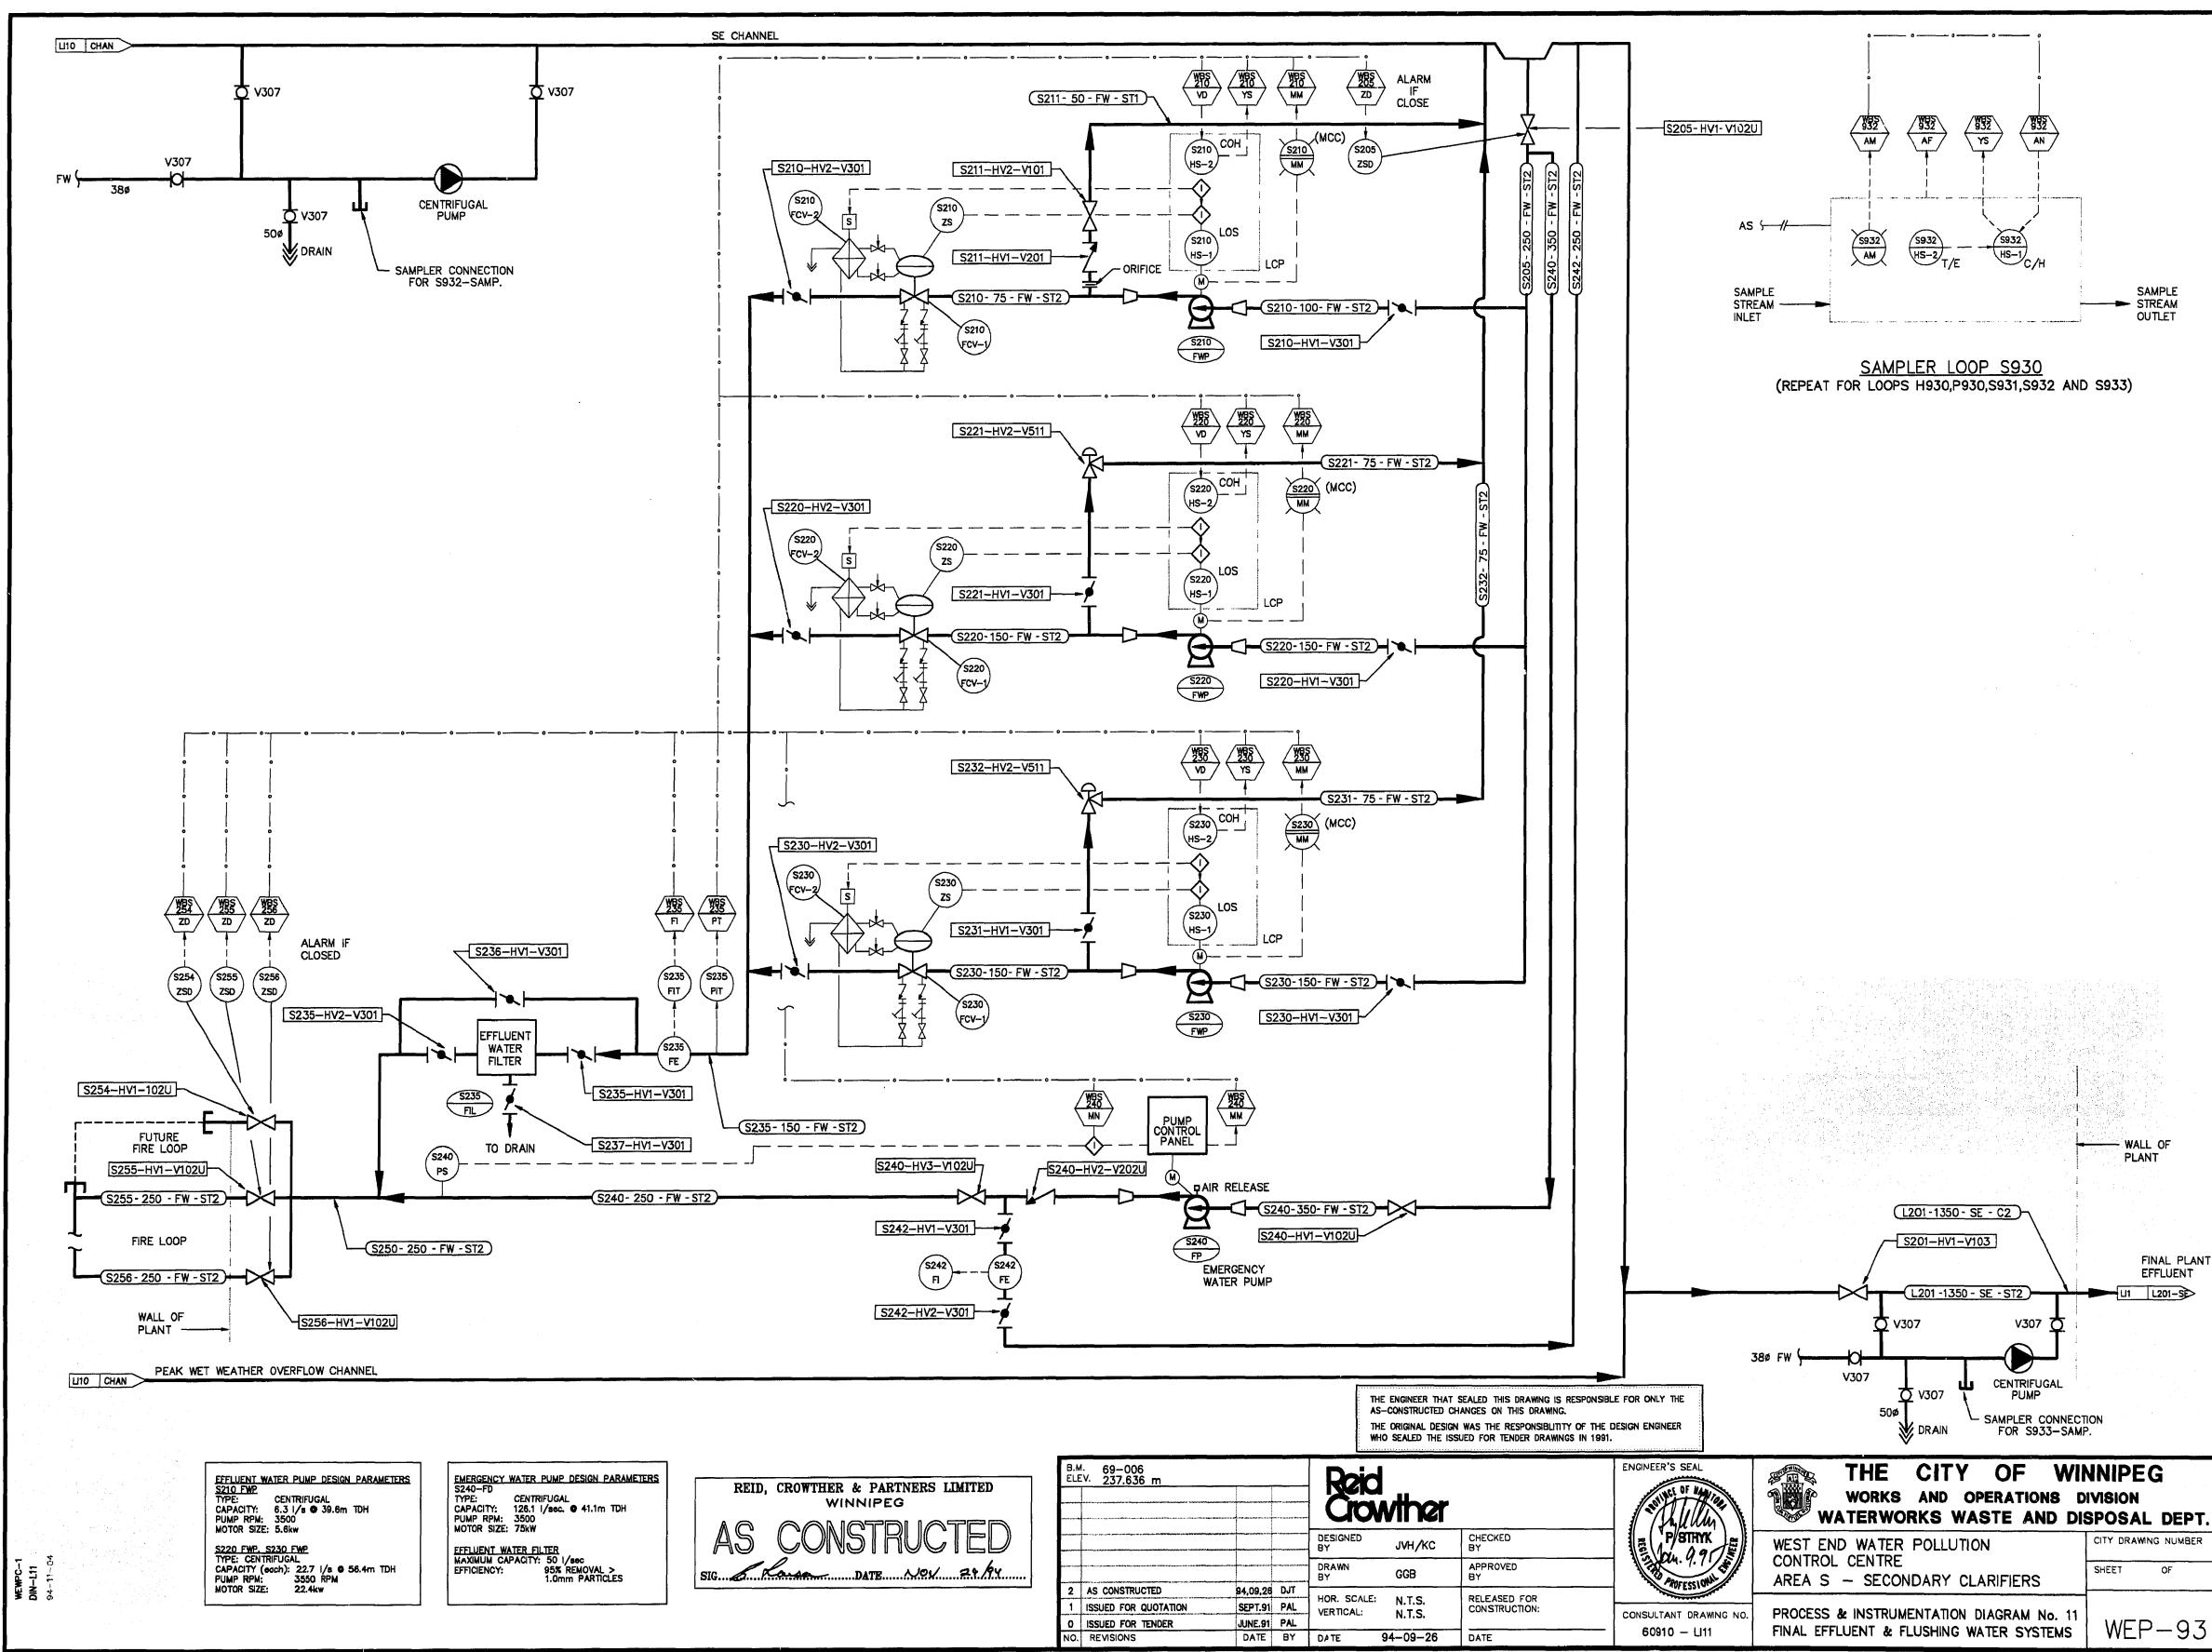


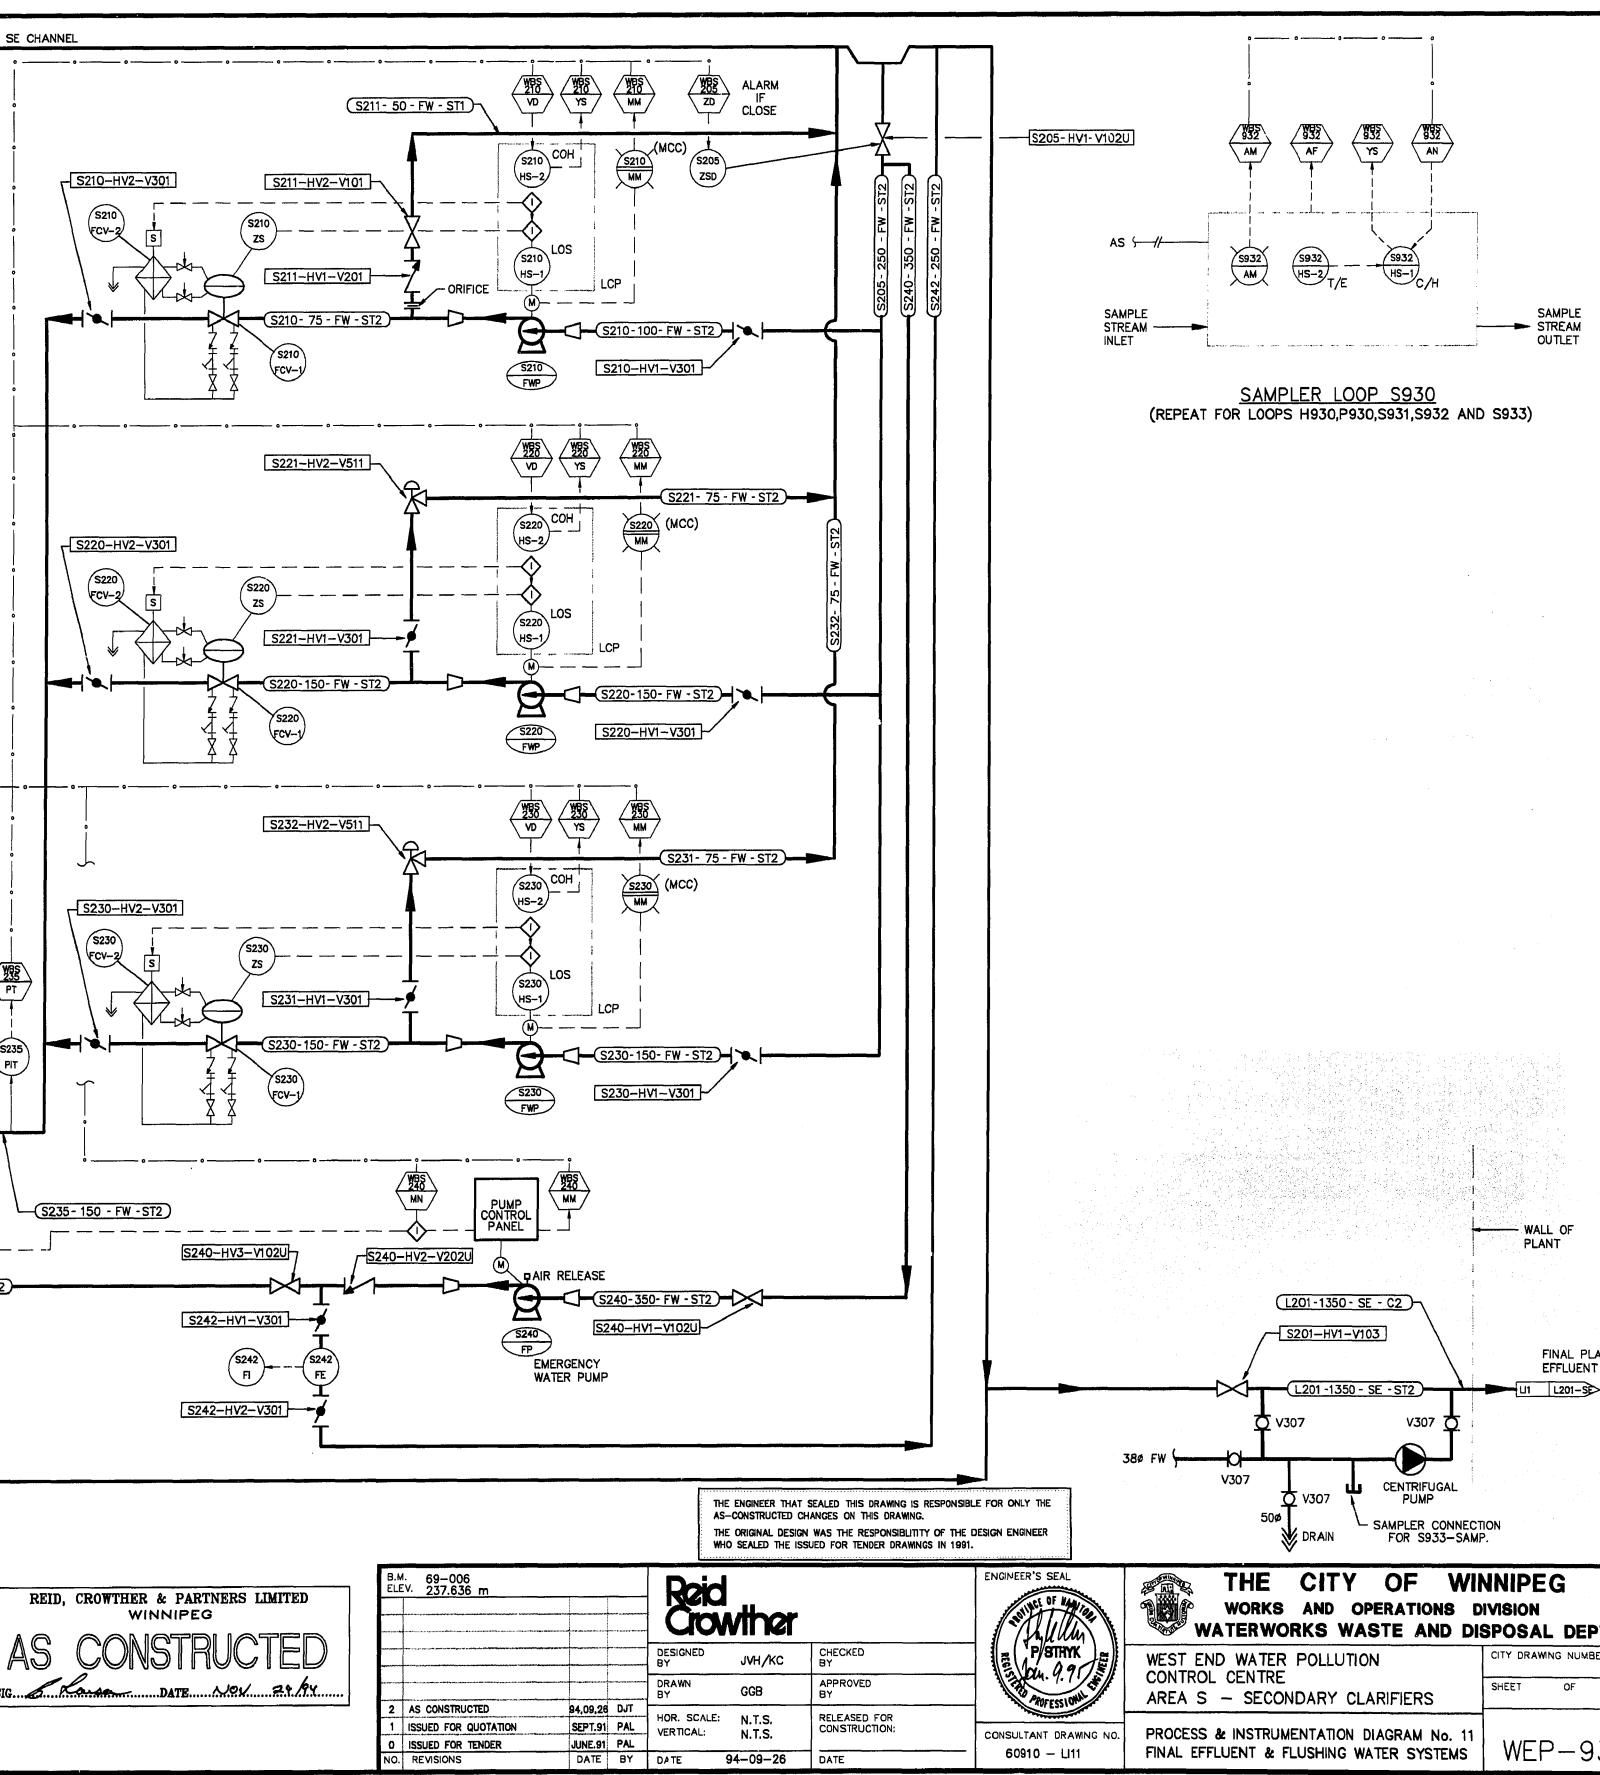
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