




## MECHANICAL DEMOLITION NOTES

DO NOT DISCONNECT EXISTING SECURITY SYSTEM COMPONENTS (MOTION SENSORS, DOOR CONTACTS, ETC). HANG LOOSE COMPONENTS ABOVE NEW CEILING SPACE TEMPORARY FOR REINSTALLATION BY-OTHERS.

- REMOVE AND DISCARD EXISTING AIR CONDITIONING CONDENSER UNIT AND ALL ASSOCIATED PIPING AND ELECTRICAL COMPONENTS.
- REMOVE & DISCARD EXTERIOR HOSE BIB AND ALL ASSOCIATED PLUMBING LINES BACK TO SOURCE.

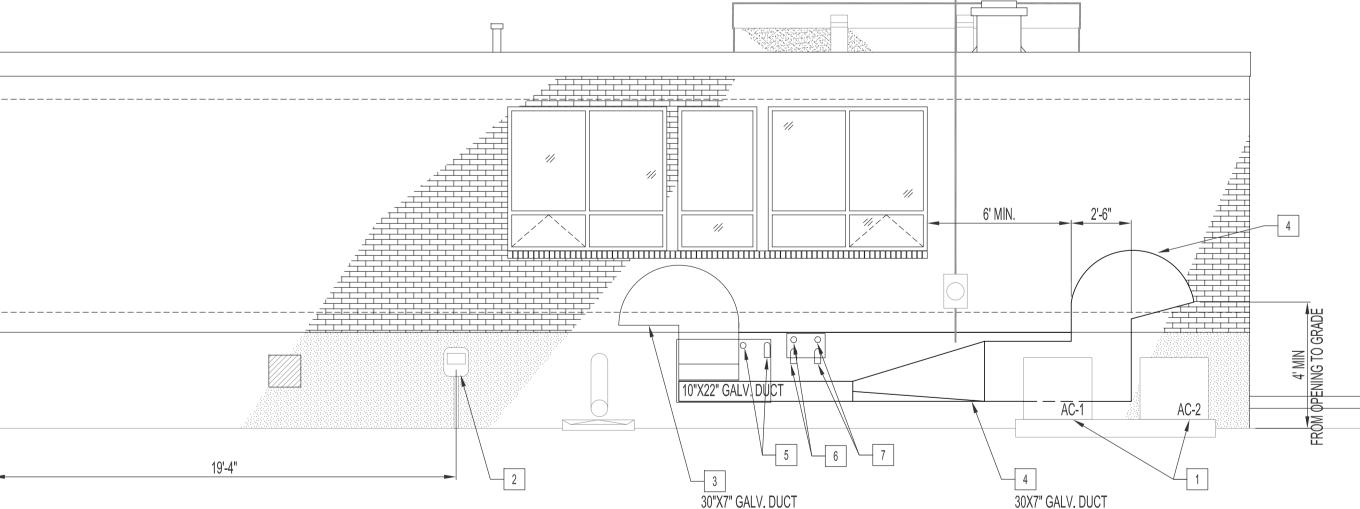


ELEVATION "A" - MECHANICAL RENOVATION SCALE: 1/4"=1'-0"

## MECHANICAL RENOVATION NOTES

- SUPPLY & INSTALL NEW AIR CONDITIONING CONDENSERS (AC-1 & AC-2) ON CONCRETE PAD. CONCRETE PAD SHOWN ON DRAWING L2.
- 2 NEW RELOCATED GAS SERVICE, METER AND PRV (BY MANITOBA HYDRO.)

SUPPLY & INSTALL, UNLESS OTHERWISE NOTED.

- FRESH AIR INTAKE GOOSE NECK DUCT CONNECTING TWO INTERIOR 14"X8" F/A DUCTS TO HRV-1 & HRV-2. OPENING SHALL HAVE BIRD SCREEN. MOUNT FLUSH WITH EXTERIOR WALL.
- EXHAUST GOOSE NECK DUCT CONNECTING TWO INTERIOR 14"X8" EXHAUST DUCTS FROM HRV-1 & HRV-2. OPENING SHALL HAVE BIRD SCREEN. MOUNT FLUSH WITH EXTERIOR WALL.
- 5 FURNACE, AHU-1, GAS VENTING.
- 6 FURNACE, AHU-2, GAS VENTING.
- 7 3" GAS VENTING FOR WATER HEATER, P-9.

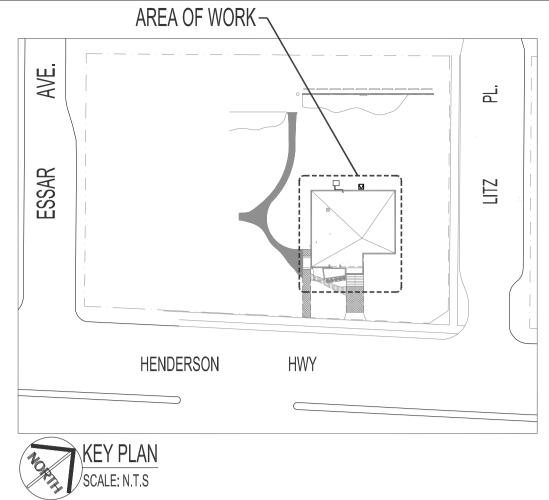

MECHANICAL DRAWING LIST		
SHEET No.	SHEET TITLE	
M1	PARTIAL SITE PLAN - MECHANICAL - DEMOLITION & RENOVATION	
M2	BASEMENT FLOOR PLAN - MECHANICAL - DEMOLITION & RENOVATION	
M3	MAIN FLOOR PLAN - MECHANICAL - DEMOLITION & RENOVATION	
M4	BASEMENT FLOOR PLAN - IN-FLOOR PLUMBING & CONCRETE FLOOR - DEMOLITION & RENOVATION	
M5	BASEMENT FLOOR PLAN - PLUMBING - DEMOLITION & RENOVATION	
M6	MAIN FLOOR PLAN - PLUMBING - DEMOLITION & RENOVATION	

MECHANICAL SYMBOLS SUPPLY & INSTALL, UNLESS OTHERWISE NOTED		
+	WATER CLOSET	
•	LAVATORY	
-0-	FLOOR OR SHOWER DRAIN	
Н	WALL HYDRANT	
— cw — cw —	COLD WATER (CW)	
— нw —— нw —	HOT WATER (HW)	
—— HWR ——— HWR ——	HOT WATER RETURN (HWR)	
and the second s	SANITARY SEWER BELOW GRADE	
	WEEPING TILE	
V	PLUMBING VENT	
C.O.	PLUMBING CLEANOUT	
P	WATER HAMMER SHOCK ABSORBER	
—— G ———	GAS PIPING	
	SUPPLY AIR ————	
	RETURN AIR, EXHAUST	
	BALANCING DAMPER	
T	THERMOSTAT	
GM	GAS METER	
F.D	FIRE DAMPER	
A 24×24 180	TYPE OF GRILLE OR DIFFUSER SIZE IN INCHES CAPACITY IN CFM	
	DOUBLE TURNING VANES	
	FLEXIBLE DUCT CONNECTOR	
	GATE VALVE	
	GLOBE VALVE	
	CHECK VALVE	

## NOTES :

BID OPPORTUNITY №: 629-2007. THESE DRAWINGS SHALL NOT BE SCALED.

DETAILED INFORMATION SHOWN ARE CORRECT.

AND ALL OPENINGS NOT SHOWN ON DRAWINGS.

REFER TO BID OPPORTUNITY PROJECT SPECIFICATION FOR ADDITIONAL INFORMATION.

THE CONTRACTOR SHALL VISIT THE SITE AND SATISFY ONESELF ALL DIMENSIONS, DATUM, AND

THE CONTRACTOR IS TO REVIEW AND COORDINATE ALL ARCHITECTURAL, MECHANICAL, ELECTRICAL, STRUCTURAL & COMMUNICATION DRAWINGS FOR LAYOUTS & ADDITIONAL OPENINGS THROUGH FLOORS, WALLS, AND CEILINGS FOR DUCT, PIPE & ELECTRICAL RISERS

ALL PLUMBING PENETRATIONS THRU FLOORS SHALL HAVE THE PIPING IN CONTACT WITH THE WALL ABOVE OR BELOW, WHERE POSSIBLE.

ALL OPENINGS THROUGH FIRE ASSEMBLIES INCLUDING MECHANICAL RM. (B-04) ARE TO BE FIR STOPPED AND SEALED WITH ULC APPROVED FIRE STOPPING TO MAINTAIN THE INTEGRITY OF THE FIRE SEPARATION, AND PROVIDE A SMOKE-TIGHT BARRIER.

ALL PRODUCTS AND MATERIALS TO BE USED AND INSTALLED SHALL CONFORM WITH ANNUFACTURER'S SPECIFICATIONS & APPLICABLE CODES.

THE CONTRACTOR SHALL BE RESPONSIBLE TO PATCH AND MAKE GOOD ALL EXISTING CONSTRUCTION AFFECTED BY THE REMOVAL OF ALL ITEMS FORMING THE PART OF THE RENOVATION WORK.

WHERE NEW FLOORING AND BASE IS TO BE INSTALLED IN EXISTING AREAS (REFER TO FLOOR PLAN AND ROOM SCHEDULE) THE EXISTING FLOORING SURFACE AND BASE MUST BE REMOVED UNLESS OTHERWISE NOTED. ALL FLOOR SURFACES SHALL BE PREPARED IN ACCORDANCE TO

MANUFACTURER'S RECOMMENDATIONS FOR INSTALLATION OF NEW FLOOR.

WHERE PAINTING OF EXISTING WALLS IS INDICATED ON THE ROOM SCHEDULE, THESE WALLS MUST BE CLEANED OF ANY EXISTING WALL COVERING, PATCHED & PREPARED TO ACCEPT NEW MATERIAL, UNLESS OTHERWISE NOTED.

ALL UNDERGROUND SERVICES AND PAVING ON CITY RIGHT-OF-WAY SHALL BE IN ACCORDANCE WITH "THE CITY OF WINNIPEG STANDARD CONSTRUCTION SPECIFICATIONS". LOCATION OF UNDERGROUND SERVICES AS SHOWN ARE BASED ON THE BEST INFORMATION AVAILABLE BUT NO GUARANTEE IS GIVEN THAT ALL EXISTING UTILITIES ARE SHOWN OR THAT THE GIVEN LOCATIONS ARE EXACT. CONFIRMATION OF EXISTENCE AND EXACT LOCATION OF ALL SERVICES MUST BE OBTAINED FROM THE INDIVIDUAL UTILITIES BEFORE PROCEEDING WITH AN CONSTRUCTION.

LAYOUT SHOWN IS SCHEMATIC ONLY. LAYOUT MAY NOT REFLECT THE TRUE PLUMBING OR PIPE ROUTES. ALL ROUTINGS SHALL RUN PARALLEL OR PERPENDICULAR TO BUILDING LINES. GROUP SAME SERVICES, WHERE POSSIBLE, TO RUN PARALLEL OR PERPENDICULAR TO BUILDING LINES. ALL ROUTINGS SHALL RUN AS HIGH AS POSSIBLE AT THE CRAWLSPACE AND BASEMENT CEILING LEVEL.

DO NOT PASS ROUTINGS THROUGH STRUCTURAL MEMBERS WITHOUT CONSULTING THE CONTRACT ADMINISTRATOR.

ALL FIXTURE SUPPLY & RETURN LINES SHALL HAVE SHUT-OFF VALVES AT FIXTURE.

DO NOT DISCONNECT EXISTING SECURITY SYSTEM COMPONENTS (MOTION SENSORS, DOOR CONTACTS). HANG LOOSE COMPONENTS ABOVE NEW CEILING SPACE TEMPORARY FOR REINSTALLATION BY-OTHERS.

ALL DUCTWORK PENETRATING FIRE SEPARATIONS SHALL HAVE FIRE DAMPERS INSTALLED TO MEET THE APPLICABLE STANDARDS AND CODES.

ORIGINAL STAMPED BY: DOUG PALEY, P. ENG. DATE: 2007.11.05

SEE ADDENDUM 1 BID OPPORTUNITY 629-2007 RCP 2007.11.05
REVISED NOTES

NO. REVISION/DESCRIPTION BY DATE

DRAWN BY RCP/DTA CHECKED BY APPROVED

DATE 2007.10.11 USER APPROVAL



CITY OF WINNIPEG
PLANNING, PROPERTY &
DEVELOPMENT DEPARTMENT
CIVIC ACCOMMODATIONS DIVISION
300 - 65 GARRY ST. R3C 4K4

PROJECT

COMMUNITY POLICE SERVICE CENTRE

1400 HENDERSON HWY.

SHEET TITLE

PARTIAL SITE PLAN MECHANICAL

DEMOLITION & RENOVATION

AS SHOWN 2004-023 SHEET NO. M1R1

DRAWING SHEET SIZE: A1 (841mm x 594mm) PLOT 1:1