


DRAWING NOTES

- 1) 10 PSIG (69kPa) 5 PSIG (34.5kPa) PRV OUTSIDE BUILDING. VENT REGULATOR ABOVE ROOF ELEVATION.
- (2) PROVIDE 650 mm ISOLATION VALVE ABOVE GRADE BEFORE BUILDING ENTRY.
- 3 CONTINUATION OF 650 mm NATURAL GAS PIPING DRAWING NUMBER WH-C0210.
- (4) 650 mm NATURAL GAS REGULATOR VENT UP TO ROOF.
- 5 DOMESTIC COLD WATER AND DOMESTIC HOT WATER UP TO UPPER LEVEL WASHROOM.
- 6 RPZ BFP VALVE.
- 7 40 TEMPERED WATER FROM MIXING VALVE UP TO RAIL CAR EMERGENCY SHOWER

 8 15mm PIPE TO EACH TRAP CONNECTION FROM TRAP PRIMING STATION.
- 9 20 BALANCING VALVE IN HOT WATER RECIRC. SYSTEM.
- (10) STEAM BOILER NATURAL GAS REGULATOR.
- (11) NATURAL GAS REGULATOR (5 PSIG/34.5kpa TO 8" w.c./2 kpa).

GENERAL NOTES

- MECHANICAL CONTRACTOR SHALL COORDINATE WITH OTHER TRADES. REPORT DISCREPANCIES TO MECHANICAL ENGINEER.
- MECHANICAL CONTRACTOR SHALL INSULATE ALL DOMESTIC COLD, HOT, RECERC. TEMPERED AND PROCESS HOT WATER LINES.

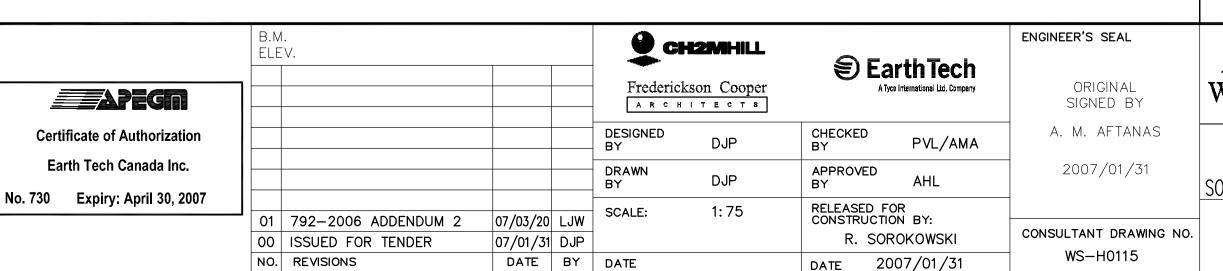

SCALE 1:50

SCALE 1:1



THE CITY OF WINNIPEG WATER AND WASTE DEPARTMENT Winnipeg ENGINEERING DIVISION

WATER TREATMENT PLANT CITY FILE NUMBER BULK CHEMICAL STORAGE SHEET SODIUM HYPOCHLORITE AND CHEMICAL STORAGE BUILDING

> MECHANICAL PARTIAL MECHANICAL ROOM PLUMBING PLAN

CITY DRAWING NUMBER 1-0601S-A-H0115-001-01D